



ABBREVIATIONS	
AFF	ABOVE FINISHED FLOOR
A/C	AIR CONDITIONING
ALT	ALTERNATE
AL, ALUM	ALUMINUM
AB	ANCHOR BOLT
∠	ANGLE
BD	BOARD
BOT	BOTTOM
BRG	BEARING
BLDG	BUILDING
BUR	BUILT UP ROOFING
CLG	CEILING
CT	CERAMIC TILE
CCTV	CLOSED CIRCUIT TELEVISION
CLO	CLOSET
COL	COLUMN
CMU	CONCRETE MASONRY UNIT
CJ	CONTROL JOINT
DEMO	DEMOLISH, DEMOLITION
DIA	DIAMETER
DIM	DIMENSION
DR	DOOR
DBL	DOUBLE
DN	DOWN
DS	DOWNSPOUT
DF	DRINKING FOUNTAIN
DW	DISHWASHER
DWG	DRAWING
(E)	EXISTING
EAC	EACH
ELEG	ELECTRIC (AL)
EWC	ELECTRIC WATER COOLER
EW	ELECTRIC WATER HEATER
ELEV	ELEVATION
EQ	EQUAL
EJ	EXPANSION JOINT
FFE	FINISH FLOOR ELEVATION
FA	FIRE ALARM
FE	FIRE EXTINGUISHER
FEC	FIRE EXTINGUISHER CABINET
FH	FIRE HYDRANT
FL	FLOOR (ING)
FD	FLOOR DRAIN
GA	GAGE, GAUGE
GALV	GALVANIZED
GL	GLASS, GLAZING
GB	GRAB BAR
GWB	GYPSUM WALLBOARD
HVAC	HEATING / VENTILATING / AIR COND.
HT	HEIGHT
HC	HOLLOW CORE
HM	HOLLOW METAL
HB	HOSE BIBB
HR	HOUR
IN	INCH
ID	INSIDE DIAMETER
INV	INVERT
JT	JOINT
LAV	LAVATORY
LLV	LONG LEG VERTICAL
LLH	LONG LEG HORIZONTAL
MH	MANHOLE
MFR	MANUFACTURE (ER)
MO	MASONRY OPENING
MAX	MAXIMUM
MECH	MECHANIC (AL)
MTL	METAL
MIN	MINIMUM
MISC	MISCELLANEOUS
NRC	NOISE REDUCTION COEFFICIENT
NO1	NOMINAL
N	NORTH
NC	NOT IN CONTRACT
NTS	NOT TO SCALE
NO	NUMBER
OC	ON CENTER (S)
OD	OUTSIDE DIAMETER
PTD	PAPER TOWEL DISPENSER
PL	PLATE
PVC	POLYVINYL CHLORIDE
PSI	POUNDS PER SQUARE INCH
PT	PRESSURE TREATED
PL	PROPERTY LINE
QT	QUARRY TILE
R	RADIUS
REF	REFERENCE
REF	REFRIGERATOR
RCIP	REINFORCED CONCRETE PIPE
REQ'D	REQUIRED
RA	RETURN AIR
REV	REVISION (S), REVISED
RD	ROOF DRAIN
RM	ROOM
RO	ROUGH OPENING
SHT	SHEET
SM	SIMILAR
SC	SOLID CORE
STC	SOUND TRANSMITTANCE COEFFICIENT
SPEC	SPECIFICATION (S)
SFR	SPRINKLER
SQ	SQUARE
SS	STAINLESS STEEL
STD	STANDARD
STL	STEEL
STO	STORAGE
THR	THRESHOLD
TPD	TOILET PAPER DISPENSER
TB	TOILET BAR
TYP	TYPICAL
UC	UNDERCUT
UL	UNDERWRITER'S LABORATORY
UR	URINAL
UN	UNLESS OTHERWISE NOTED
VERT	VERTICAL
VCT	VINYL COMPOSITION TILE
VOL	VOLUME
WC	WATER CLOSET
WH	WATER HEATER
WJ	WELDED WIRE FABRIC
W	WITH
WO	WITHOUT
WD	WOOD
YD	YARD

# SUWANNEE COUNTY SCHOOL BOARD SUWANNEE PRIMARY SCHOOL ADDITIONS AND REMODELING

1625 WALKER AVE., SW

LIVE OAK, FLORIDA

## CONSTRUCTION DOCUMENTS FOR BID/PERMIT

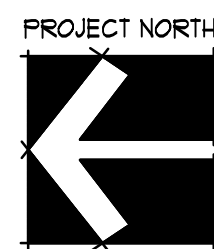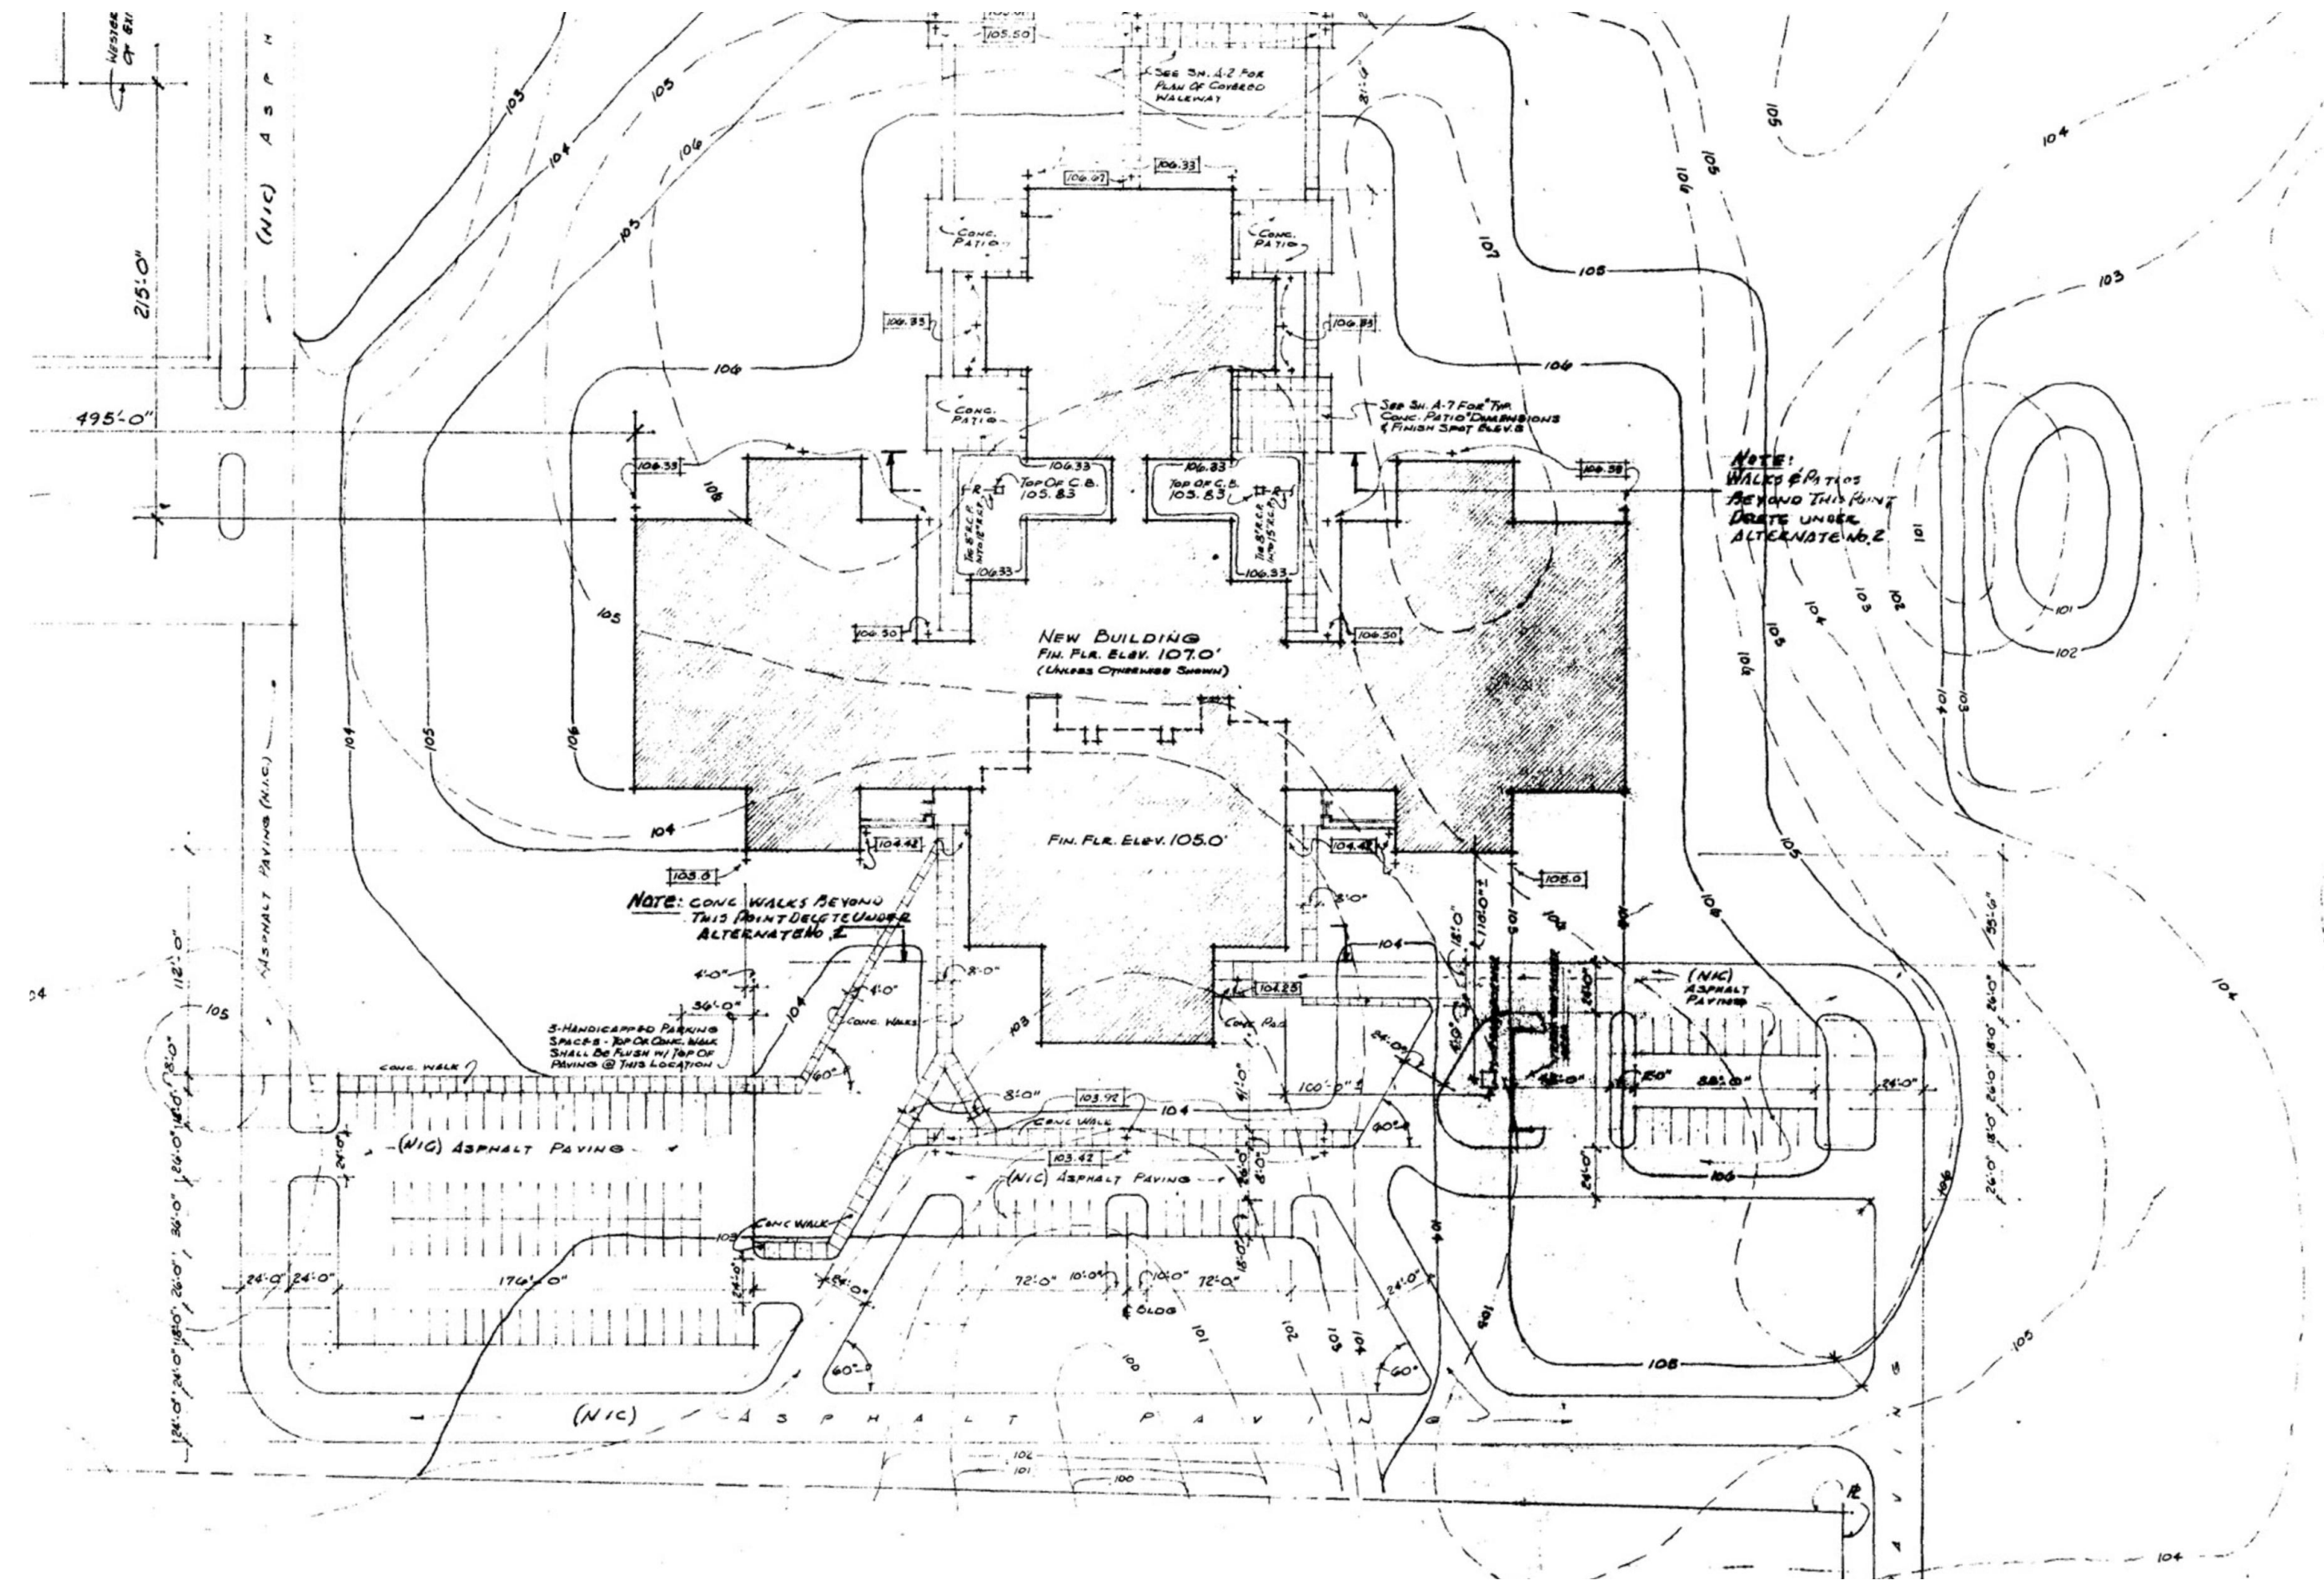


EXISTING CAMPUS SITE PLAN

SCALE: 1/8"=1'-0"

### GENERAL NOTES

- ALL GRAPHIC SCALES INDICATED ON THE DRAWINGS ARE FOR 14"x36" PAGE SIZE ONLY.
- TO THE BEST OF OUR KNOWLEDGE THESE DOCUMENTS COMPLY WITH THE APPLICABLE MINIMUM BUILDING CODES AND THE APPLICABLE FIRE SAFETY STANDARDS IN ACCORDANCE WITH THE FLORIDA BUILDING CODE AND 633 FLORIDA STATUTES.
- DETAILS SHALL APPLY TO ALL SIMILAR CONDITIONS UNLESS A DIFFERENT DETAIL IS SHOWN.
- ALL PLANS OF EXISTING CONDITIONS ARE BASED UPON THE ORIGINAL DESIGN DRAWINGS DATED 1914 BY ZEB LACKEY AND ASSOCIATES ARCHITECTS. EXISTING FEATURES MAY DIFFER, ESPECIALLY OUTSIDE OF THE AREAS OF MAJOR WORK.


### SYMBOLS LIST

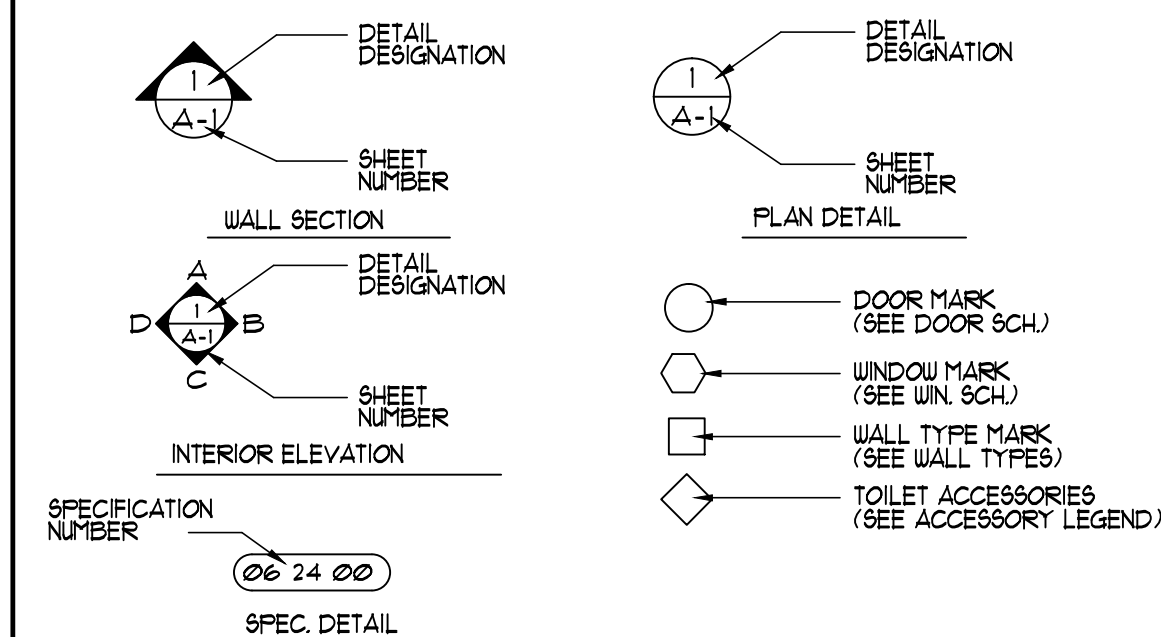

### DRAWING LIST

REVISIONS		ARCHITECTURAL	
		COV	COVER SHEET
		LS-1	LIFE SAFETY PLAN
		LS-2	ENLARGED LIFE SAFETY PLAN
		A-0-0	CONSTRUCTION SEQUENCE PLAN
		A-0-1	ENLARGED DEMOLITION PLAN
		A-1-0	NEW FLOOR PLAN
		A-1-1	NEW ENLARGED FLOOR PLAN
		A-1-2	NEW ENLARGED FLOOR PLAN
		A-2-0	NEW REFLECTED CEILING PLAN
		A-2-1	NEW ENLARGED REFLECTED CEILING PLAN
		A-2-2	NEW ENLARGED REFLECTED CEILING PLAN
		A-3-0	NEW ROOF PLAN AND DRAINAGE
		A-4-0	NEW PARTIAL EXT. ELEV.
		A-5-0	BUILDING SECTIONS
		A-6-0	WALL SECTIONS
		A-7-0	INTERIOR ELEVATIONS
		A-8-0	DOOR AND WIN. SCHEDULES AND TYPES
		A-8-1	DOOR AND WINDOW DETAILS
		A-8-2	CARPENTRY DETAILS
		A-8-3	WALL TYPES AND U.A.S.S. RATINGS
		STRUCTURAL	
		S-0-1	GENERAL NOTES AND DETAILS
		S-0-2	GENERAL NOTES
		S-0-3	WIND DIAGRAM
		S-1-1	FOUNDATION AND FRAMING ZONE A
		S-2-1	FOUNDATION AND FRAMING ZONE B
		S-3-1	SECTIONS AND DETAILS
		S-3-2	SECTIONS AND DETAILS
		S-3-3	SECTIONS AND DETAILS
		PLUMBING	
		P-0-1	PLUMBING LEGENDS AND NOTES
		P-1-0	PLUMBING PLAN
		P-1-2	PLUMBING ENLARGED PLANS
		MECHANICAL	
		M-0-1	MECHANICAL LEGENDS, ABBRS. AND NOTES
		M-0-2	MECHANICAL ENLARGED DEMOLITION PLANS
		M-1-1	MECHANICAL FLOOR PLANS
		M-2-1	MECHANICAL ROOF PLAN
		M-3-1	MECHANICAL DETAILS
		M-3-2	MECHANICAL SCHEDULES
		ELECTRICAL	
		E-0-1	ELECTRICAL LEGEND AND NOTES
		E-1-0	ELECTRICAL OVERALL PLAN
		E-1-1	ELECTRICAL DEMOLITION PLAN
		E-2-1	LIGHTING PLANS
		E-3-1	POWER SYSTEMS PLANS
		E-4-1	ELECTRICAL ONE-LINE AND SCHEDULES
		E-4-2	ELECTRICAL DETAILS

### VICINITY MAP

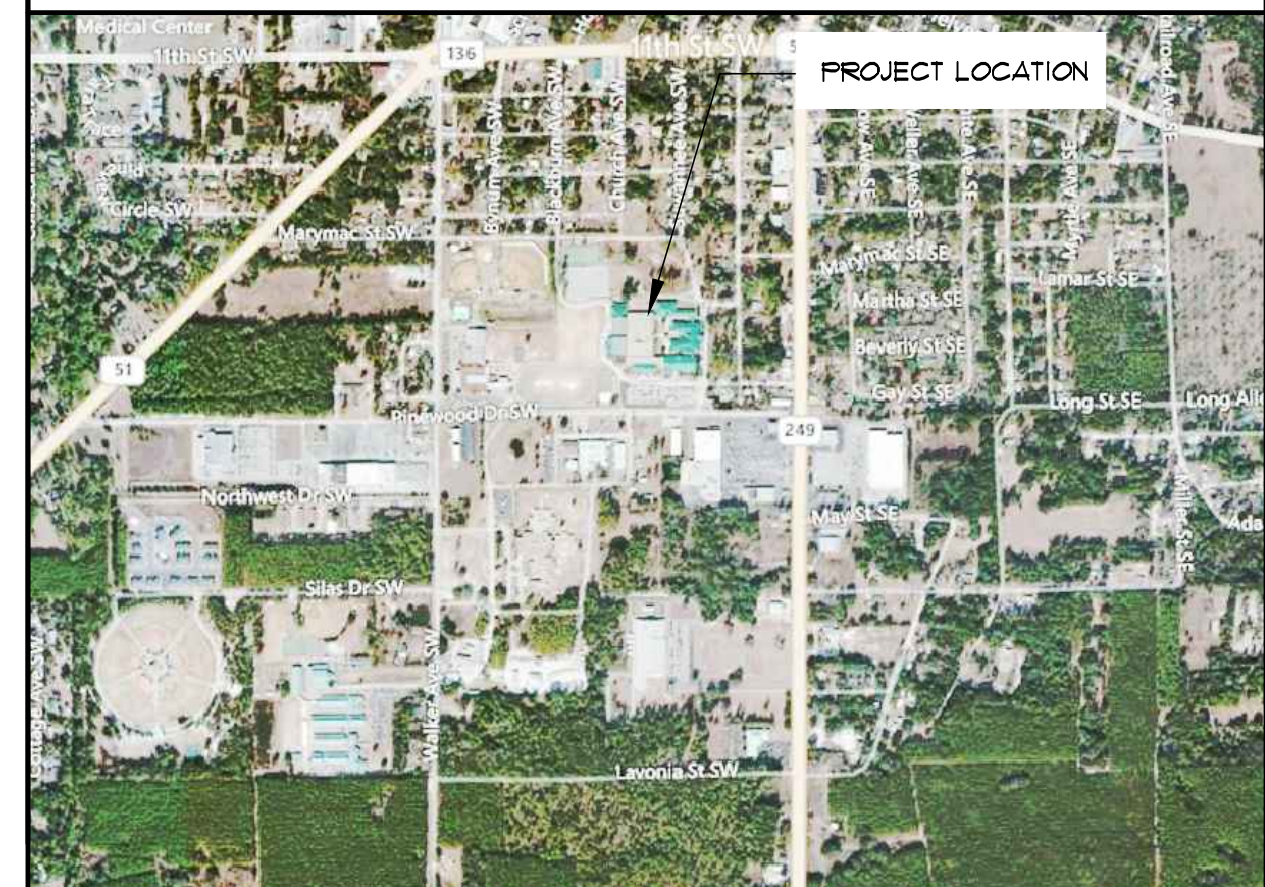

### REVISIONS AND UPDATES

02/14/14			CONSTRUCTION DOCUMENTS FOR BID/PERMIT

**SUWANNEE COUNTY SCHOOL BOARD**  
**SUWANNEE PRIMARY SCHOOL**  
**ADDITIONS AND REMODELING**  
1625 WALKER AVE., SW  
LIVE OAK, FLORIDA

**COVER SHEET**


drawn 02/18/14 CNK  
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approved JCZ

AA-C000568

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FL. REG. AR0009521  
Job no. 20051  
**COV**

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TELEPHONE (321) 631-8030



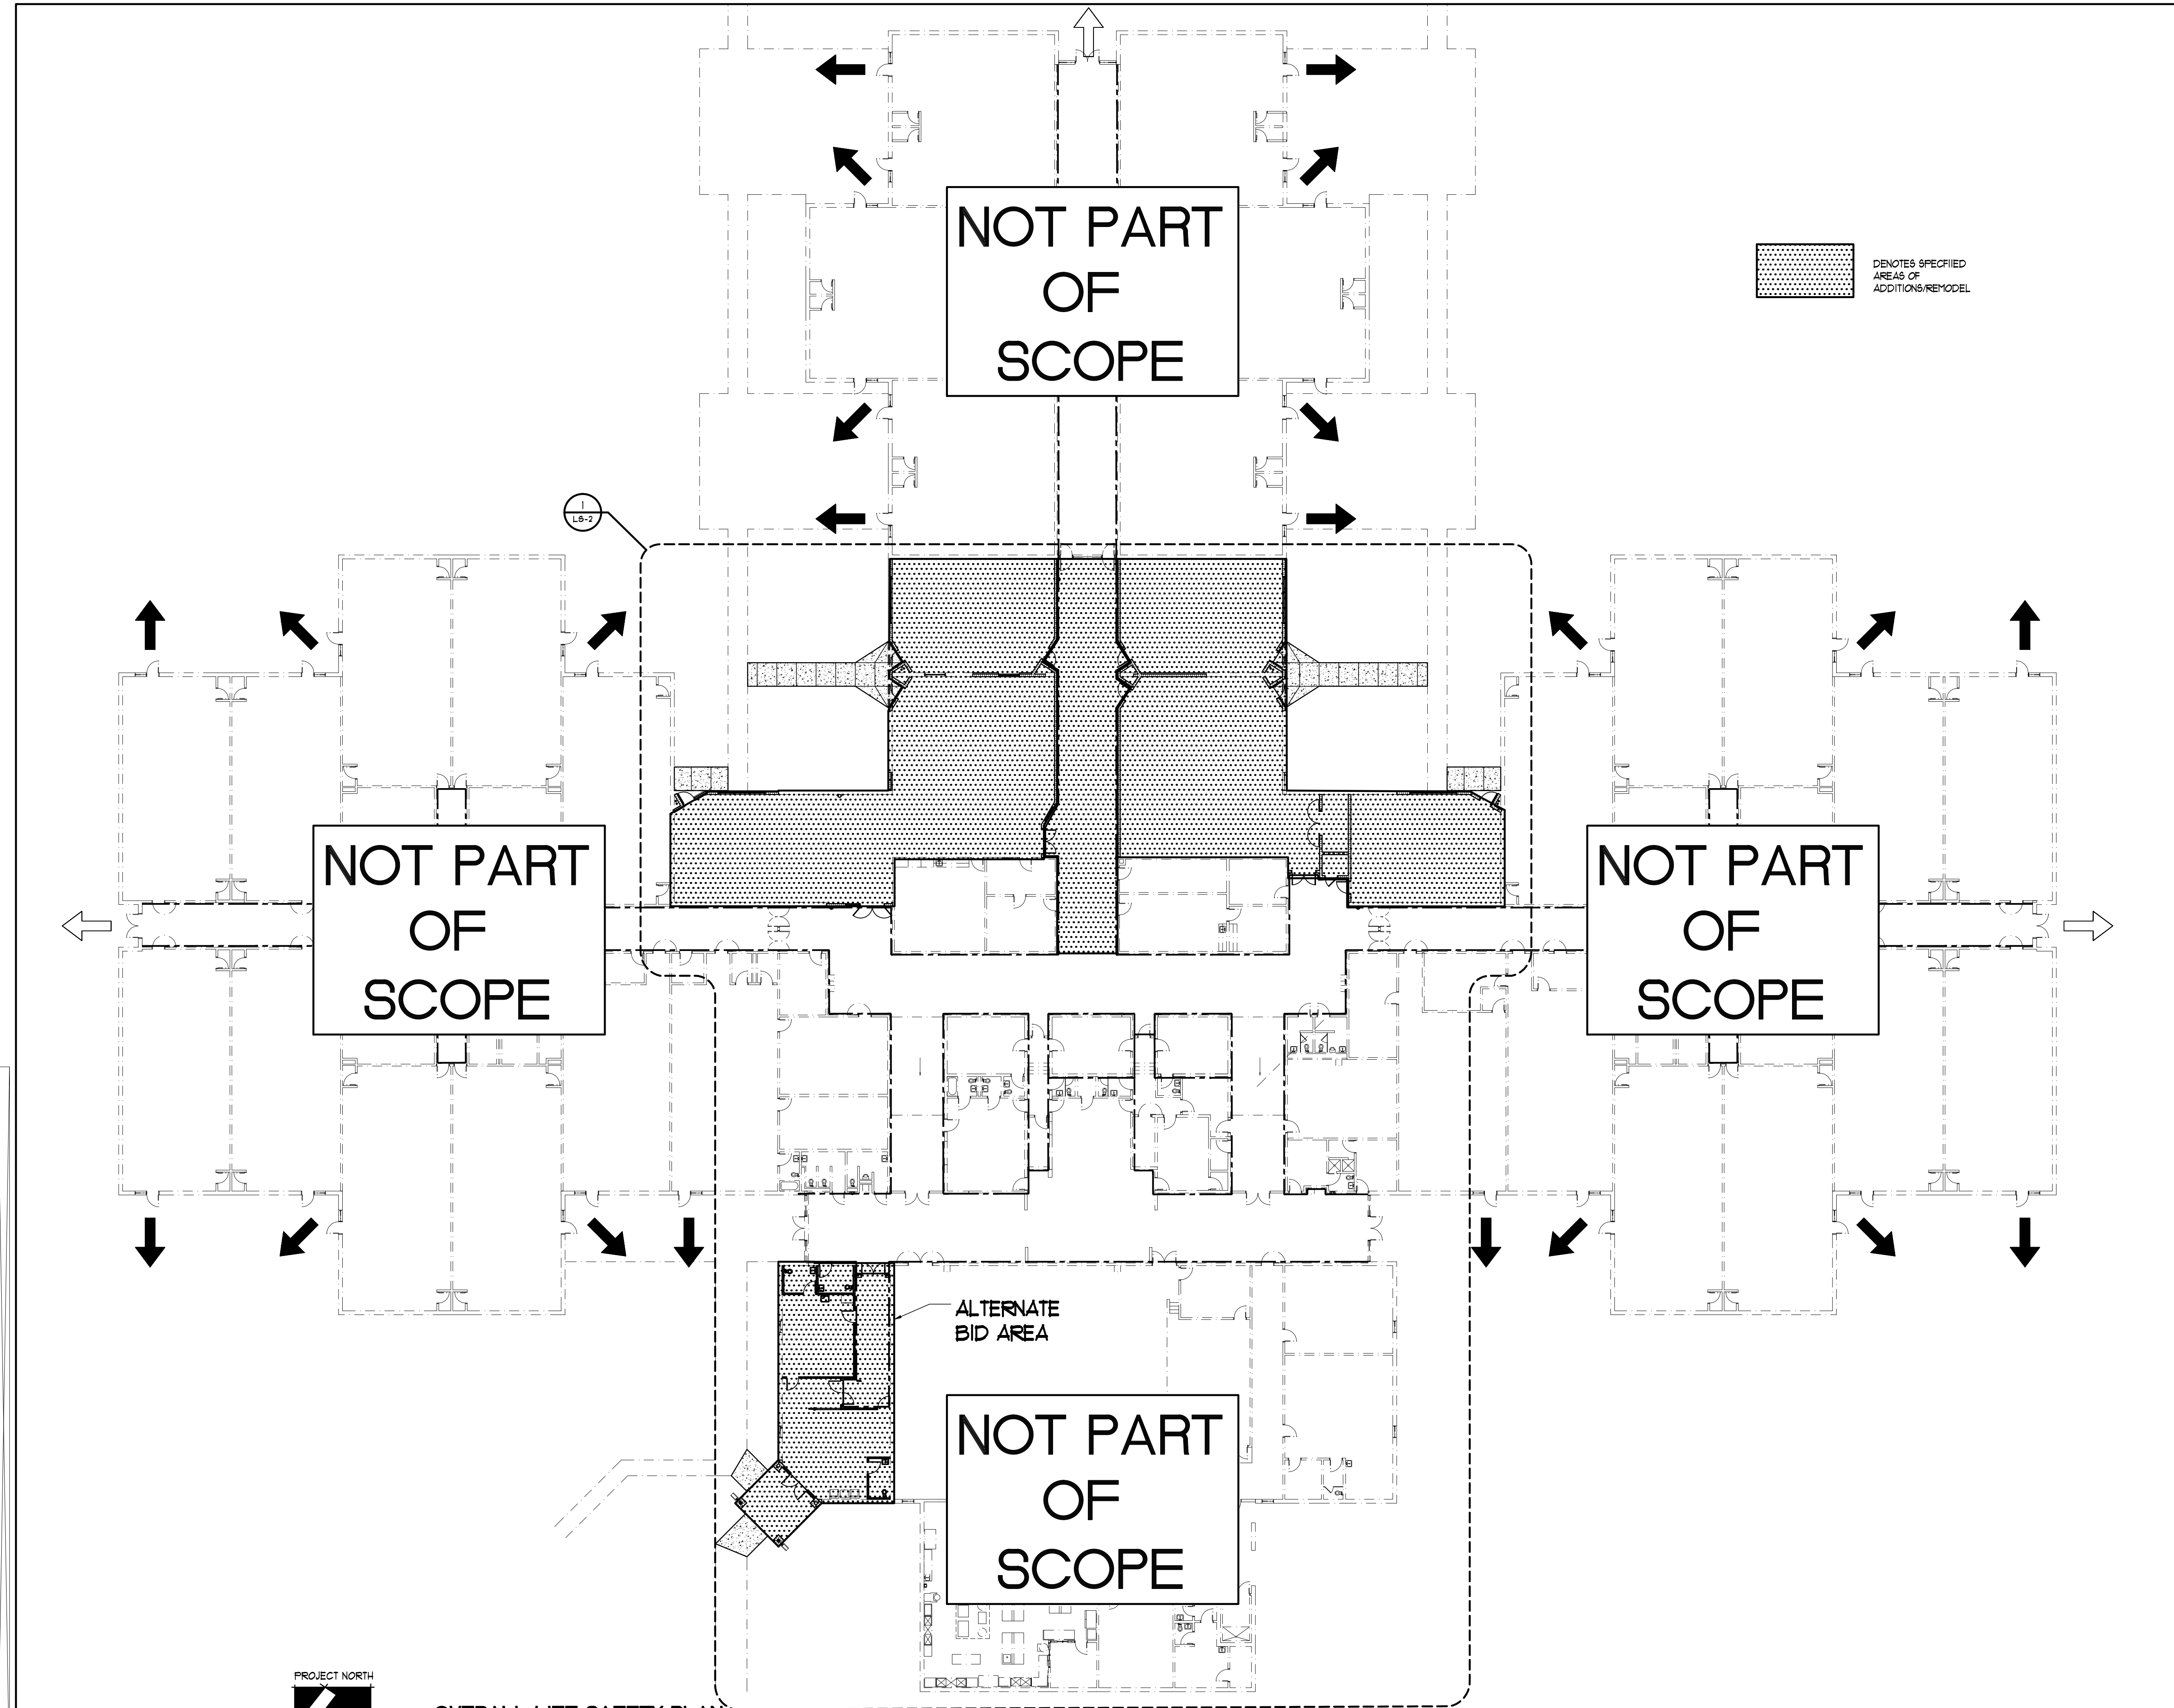

LIFE SAFETY / CODE COMPLIANCE NOTES

APPLICABLE CODES

FLORIDA BUILDING CODE - 2010  
FBC MECHANICAL CODE 2010  
FBC PLUMBING CODE 2010  
FLORIDA FIRE PREVENTION CODE 2010

OCCUPANCY CLASSIFICATION

FLORIDA BUILDING CODE - EDUCATIONAL OCCUPANCY PER SECTIONS 305  
FLORIDA FIRE PREVENTION CODE - EDUCATIONAL (EXISTING) RENOVATION/REMODEL  
NOTE: BUILDING AREA IS GROSS AREA WITHIN EXTERIOR WALLS PER FBC 502.1 AND 1002.1  
  
ADDED AREA:  
CLASSROOM ADDITIONS: 2,426 SF

CONSTRUCTION SEPARATION

NOT-APPLICABLE

CONSTRUCTION TYPE

FLORIDA BUILDING CODE: EXISTING (EQUIVALENT TO TYPE II A)  
FIRE SPRINKLER SYSTEM: NONE

BUILDING HEIGHT AND ALLOWABLE AREA

HEIGHT (FBC TABLE 503) - MAX. HEIGHT IS 65 FT  
AREA (FBC TABLE 503) - 26,500 SF

EXITING / EGRESS

MIN. NUMBER OF EXITS (PER FBC TABLE 1021.1 AND FFPC)  
- OCCUPANT LOAD 1 - 500 (PER STORY) + 2, 3 PROVIDE EXITS.  
  
TRAVEL DISTANCES (SEE PLAN FOR PATHS)  
- MAXIMUM COMMON PATH: 15 FT. (PER FBC 1014.3)  
  
- MAXIMUM TRAVEL DISTANCE: 150 FT. (PER FBC TABLE 1016.1)  
  
- DEAD END CORRIDOR: 20 FT. (PER FBC 1018.4)  
  
EXIT WIDTHS: (SEE PLANS FOR WIDTHS) (PER FBC 1005.1)  
DOORS:  
- 02 INCHES / PERSON (MIN. WIDTH TO BE 36 INCHES)  
  
RAMPS:  
- 02 INCHES / PERSON W/ 1/12 MAX. SLOPE  
  
STAIRS:  
- 03 INCHES / PERSON  
  
CORRIDOR:  
- 02 INCHES / PERSON + X 02' + INCHES MIN. WIDTH SHALL BE 44 INCHES  
OR 12 INCHES (PER FBC 1018.2 AND FFPC 302.3.2)

LIFE SAFETY SYMBOL LEGEND

INDICATES PRIMARY EXIT OR EXIT ACCESS

INDICATES SECONDARY EXIT ACCESS

INDICATES PRIMARY COMMON PATH OF TRAVEL (DISTANCE FEET)

INDICATES PRIMARY PATH OF TRAVEL (DISTANCE FEET)

INDICATES SECONDARY PATH OF TRAVEL (DISTANCE FEET)

INDICATES DOOR WITH FIRE RATING LABEL (IE: 30, 60, 45, OR 20 MINUTE)

INDICATES MAXIMUM DOOR EXIT CAPACITY (PERSONS)

INDICATES SMOKE TIGHT WALL/PARTITION

INDICATES 1 HR FIRE RATED WALL/PARTITION (SMOKE RESISTANT)

INDICATES OCCUPANT LOAD PER FBC FOR SPECIFIC ROOMS

INDICATES MAX. OCCUPANCY SIGN

INDICATES FIRE EXTINGUISHER ON BRACKET OR IN CABINET

INDICATES EMERGENCY LIGHTS (SEE ELEC. DRAWINGS)

INDICATES FIRE ALARM STROBE AND HORN (SEE ELEC. DRAWINGS)

INDICATES FIRE BELL (SEE ELEC. DRAWINGS)

INDICATES FIRE ALARM PULL STATION (SEE ELEC. DRAWINGS)

INDICATES EXIT SIGN - (SEE ELEC. DIAGS. FOR ADDITIONAL DEVICES)

SMOKE DETECTOR (SD) AND HEAT DETECTOR

CLEAR WIDTH AND MAXIMUM EGRESS CAPACITY (PERSONS)

REVISIONS AND UPDATES

02/14/14		CONSTRUCTION DOCUMENTS FOR BID/PERMIT

SUWANNEE COUNTY SCHOOL BOARD  
SUWANNEE PRIMARY SCHOOL  
ADDITIONS AND REMODELING  
1625 WALKER AVE. SW  
LIVE OAK, FLORIDA

OVERALL LIFE SAFETY PLAN

drawn 02/18/14	CHK	checked 02/16/14	JCZ	approved	JCZ
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FL. REG. AR0009521

Job no. 20051
LS-1

PROJECT NORTH


OVERALL LIFE SAFETY PLAN

SCALE: 1" = 20'


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TELEPHONE (321) 631-8030



PROJECT NORTH  
  
1 ENLARGED LIFE SAFETY PLAN  
SCALE: 1/6" = 1'-0"

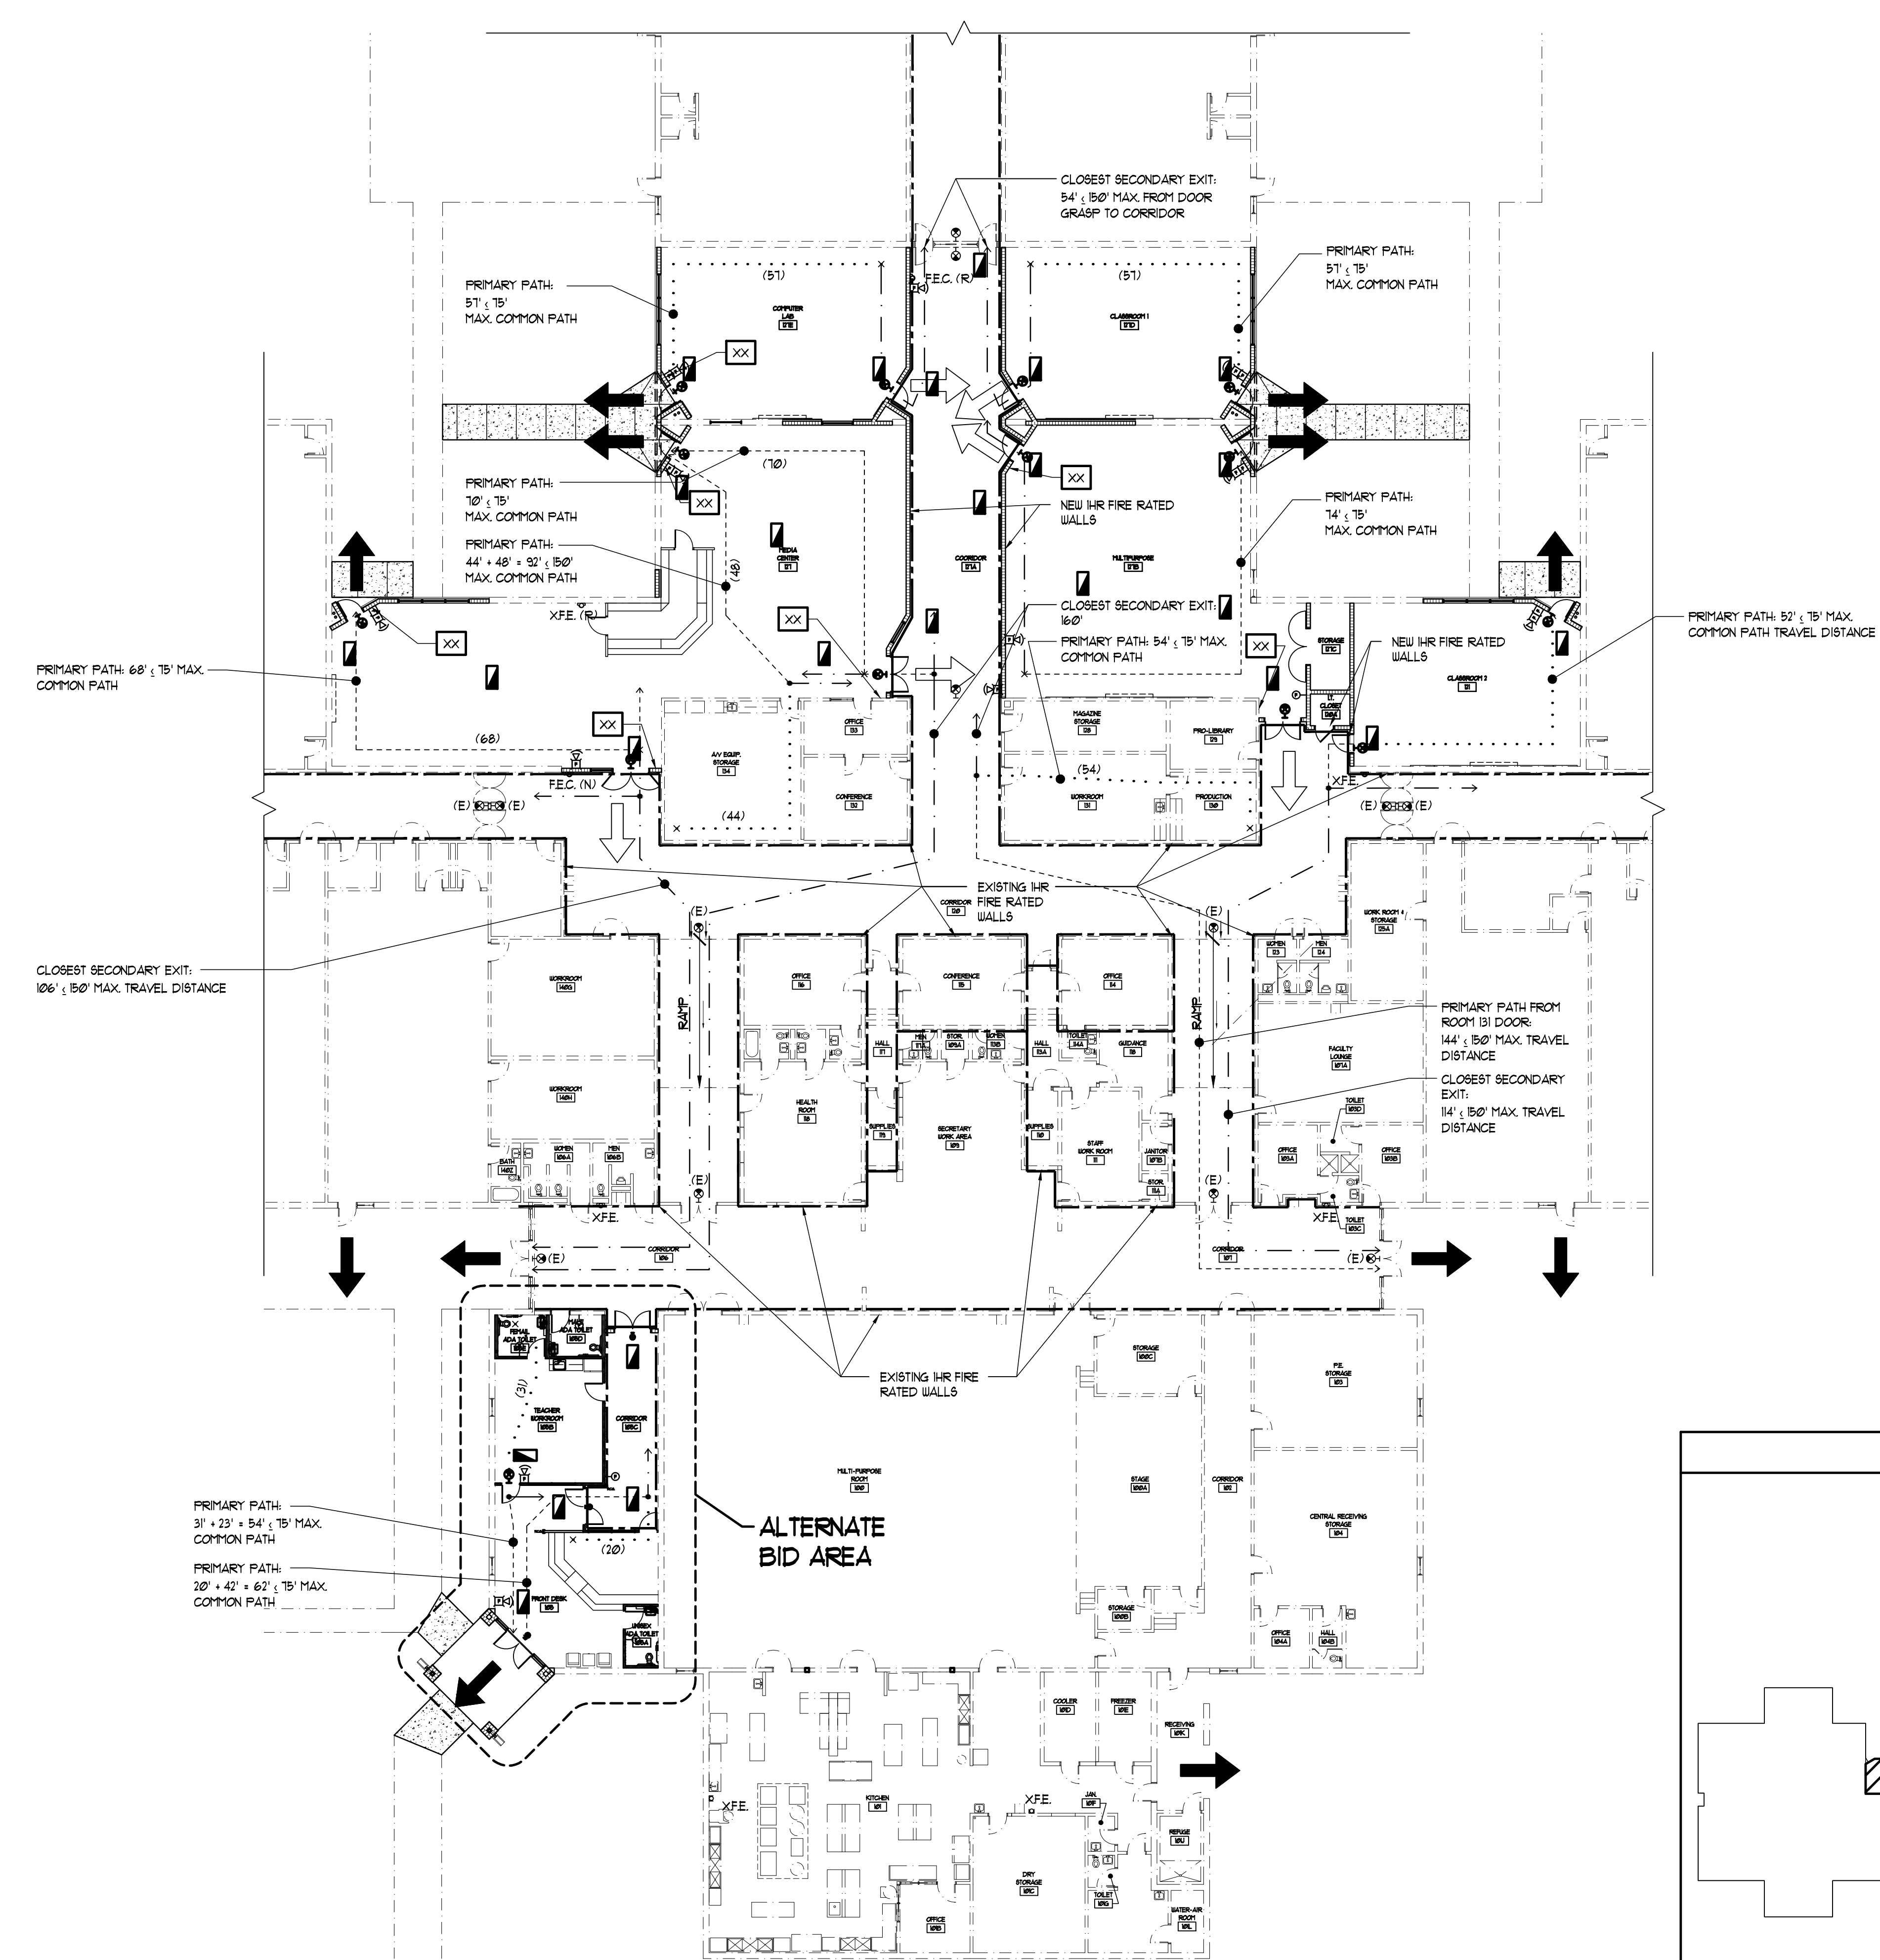

**LIFE SAFETY / CODE COMPLIANCE NOTES**

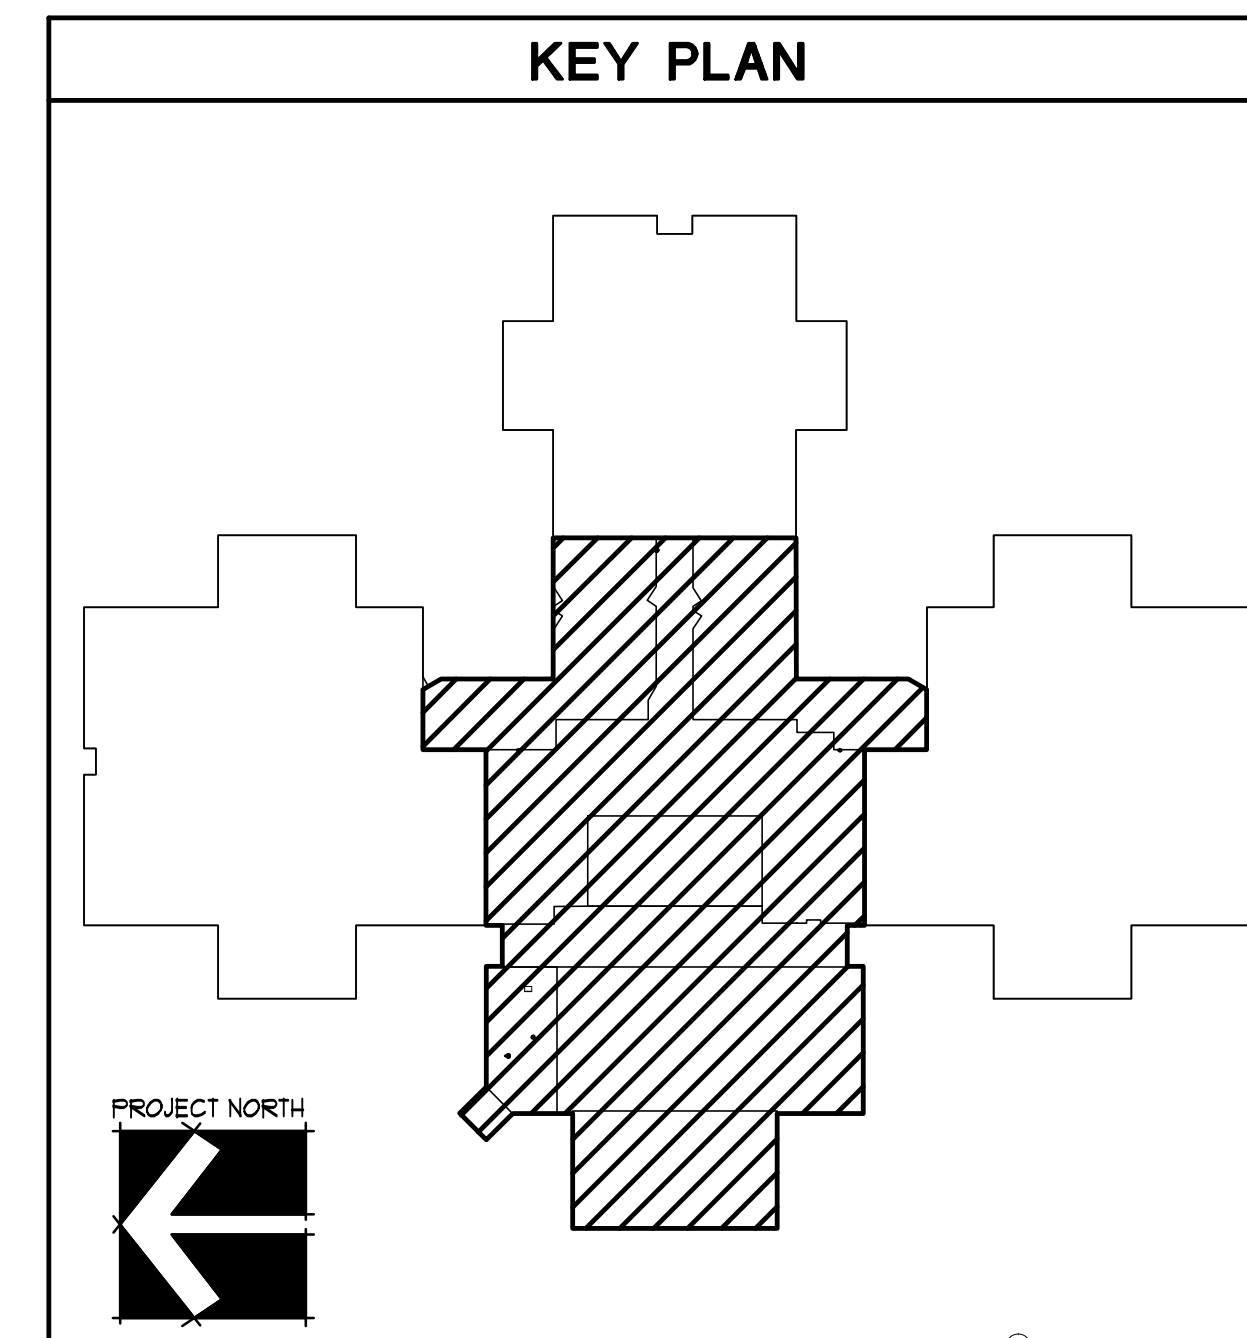APPLICABLE CODES	
FLORIDA BUILDING CODE - 2010 FBC MECHANICAL CODE 2010 FBC PLUMBING CODE 2010 FLORIDA FIRE PREVENTION CODE 2010	
OCCUPANCY CLASSIFICATION	
FLORIDA BUILDING CODE - EDUCATIONAL OCCUPANCY PER SECTIONS 305 FLORIDA FIRE PREVENTION CODE - EDUCATIONAL (EXISTING) RENOVATION/REMODEL NOTE: BUILDING AREA IS GROSS AREA WITHIN EXTERIOR WALLS PER FBC 502.1 AND 1002.1  ADDED AREA: CLASSROOM ADDITIONS: 2,426 SF	
CONSTRUCTION SEPARATION	
NOT-APPLICABLE	
CONSTRUCTION TYPE	
FLORIDA BUILDING CODE: FIRE SPRINKLER SYSTEM:	EXISTING (EQUIVALENT TO TYPE II A) NONE
BUILDING HEIGHT AND ALLOWABLE AREA	
HEIGHT (FBC TABLE 503) - MAX. HEIGHT IS 65 FT AREA (FBC TABLE 503) - 26,500 SF	
EXITING / EGRESS	
MIN. NUMBER OF EXITS (PER FBC TABLE 1021.1 AND FFPC) - OCCUPANT LOAD 1-500 (PER STORY) + 2-3 PROVIDE EXITS.  TRAVEL DISTANCES (SEE PLAN FOR PATHS) - MAXIMUM COMMON PATH: 15 FT. (PER FBC 1014.3)  - MAXIMUM TRAVEL DISTANCE: 150 FT. (PER FBC TABLE 1016.1)  - DEAD END CORRIDOR: 20 FT. (PER FBC 1018.4)  EXIT WIDTHS: (SEE PLANS FOR WIDTHS) (PER FBC 1005.1) DOORS: - 21 INCHES / PERSON (MIN. WIDTH TO BE 36 INCHES)  RAMPS: - 21 INCHES / PERSON W/ 1/2 MAX. SLOPE  STAIRS: - 23 INCHES / PERSON  CORRIDOR: - 21 INCHES / PERSON + X 2' + INCHES MIN. WIDTH SHALL BE 44 INCHES OR 12 INCHES (PER FBC 1018.2 AND FFPC 382.3.2)	

**LIFE SAFETY SYMBOL LEGEND**

	INDICATES PRIMARY EXIT OR EXIT ACCESS
	INDICATES SECONDARY EXIT ACCESS
	INDICATES PRIMARY COMMON PATH OF TRAVEL (DISTANCE FEET)
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	INDICATES DOOR WITH FIRE RATING LABEL (IE: 30, 60, 45, OR 20 MINUTE)
	INDICATES MAXIMUM DOOR EXIT CAPACITY (PERSONS)
	INDICATES SMOKE TIGHT WALL/PARTITION
	INDICATES 1 HR FIRE RATED WALL/PARTITION (SMOKE RESISTANT)
	INDICATES OCCUPANT LOAD PER FBC FOR SPECIFIC ROOMS
	INDICATES MAX. OCCUPANCY SIGN
	INDICATES FIRE EXTINGUISHER ON BRACKET OR IN CABINET
	XFE - EXISTING FIRE EXTINGUISHER
	INDICATES EMERGENCY LIGHTS (SEE ELEC. DRAWINGS)
	INDICATES FIRE ALARM STROBE AND HORN (SEE ELEC. DRAWINGS)
	INDICATES FIRE BELL (SEE ELEC. DRAWINGS)
	FIRE ALARM PULL STATION (SEE ELEC. DRAWINGS)
	INDICATES EXIT SIGN - (SEE ELEC. DIAGS. FOR ADDITIONAL DEVICES)
	SMOKE DETECTOR (SD) AND HEAT DETECTOR
	CLEAR WIDTH AND MAXIMUM EGRESS CAPACITY (PERSONS)

**REVISIONS AND UPDATES**

DATE	DESCRIPTION
02/14/14	CONSTRUCTION DOCUMENTS FOR BID/PERMIT

**SUWANNEE COUNTY SCHOOL BOARD**  
**SUWANNEE PRIMARY SCHOOL**  
**ADDITIONS AND REMODELING**  
1625 WALKER AVE., SW  
LIVE OAK, FLORIDA

ENLARGED LIFE SAFETY PLAN



drawn 02/18/14 CNK checked 02/18/14 JCZ approved JCZ

AA-C000568

JOHN C. ZWICK, R.A.  
FL. REG. AR0009521

Job no. 20051  
**LS-2**

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1 CONSTRUCTION SEQUENCE PLAN  
SCALE: 1" = 20'

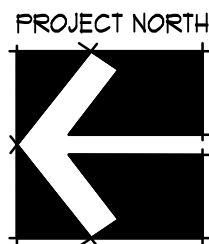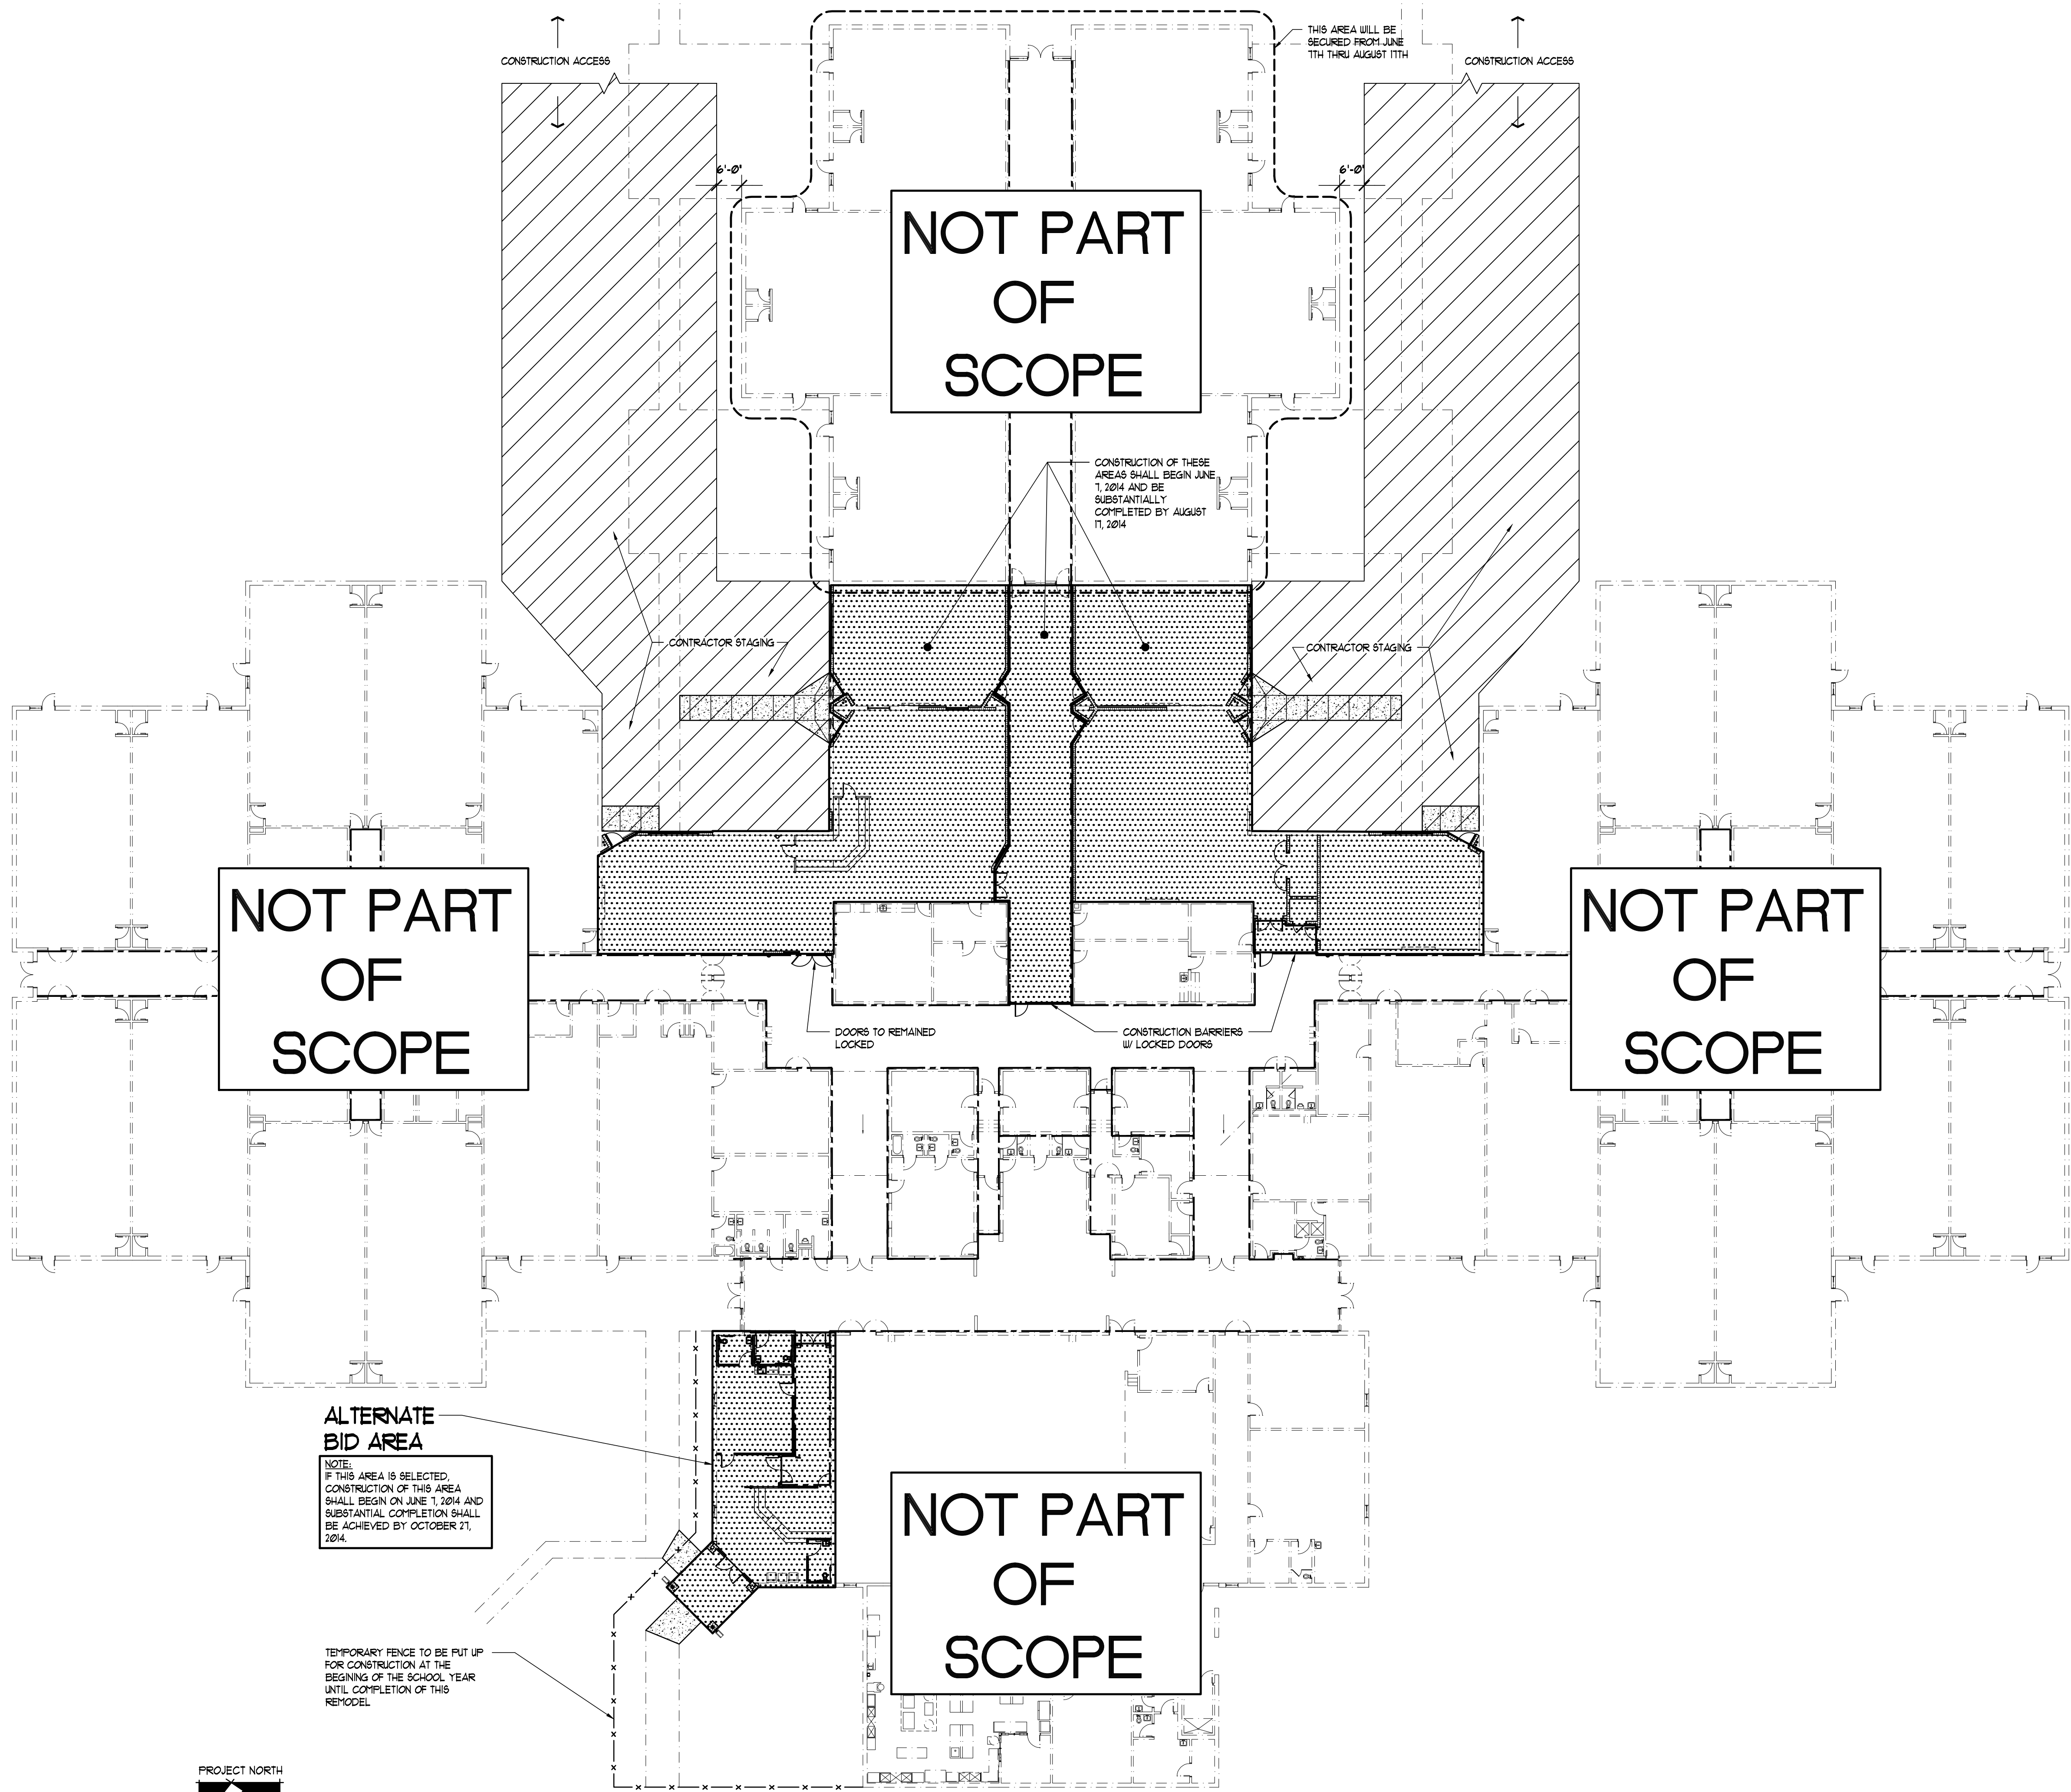GENERAL NOTES

1. CONTRACTOR TO COORDINATE WITH THE SCSSB-FM AND ARCHITECT PRIOR TO CONSTRUCTION AS TO SYSTEMS (FIRE, ELECT. AND MECH) THAT WILL BE AFFECTED AND ENSURE THAT DATA INTEGRITY AND POWER WILL BE MAINTAINED CONTINUOUSLY THROUGHOUT DEMOLITION AND CONSTRUCTION.
2. ALL CONSTRUCTION REQUIRING THE DISRUPTION OF THE NORMAL WORKING ENVIRONMENT WILL BE SUBJECT TO APPROVAL AND COORDINATION WITH SCSSB-FM.
3. TEMPORARY CONSTRUCTION BARRIERS WILL BE SET UP PRIOR TO CONSTRUCTION TO PROVIDE A DUST FREE SEAL OF THE SCSSB AREAS.
4. REPLACE ANY MISSING, DAMAGED, OR DIRTY CEILING TILES IN ADJACENT AREAS OR REPLACE ENTIRE CEILING IN ROOM.
5. REPAINT ALL PREVIOUS PAINTED WALLS IN RENOVATED AREAS.
6. PATCH, REPAIR & PAINT ALL ADJACENT AREAS DAMAGED BY DEMOLITION (TYPICAL).
7. ALL PLANS OF EXISTING CONDITIONS ARE BASED UPON THE ORIGINAL DESIGN DRAWINGS DATED 1914 BY ZEB LACKEY AND ASSOCIATES ARCHITECTS. EXISTING FEATURES MAY DIFFER, ESPECIALLY OUTSIDE OF THE AREAS OF MAJOR WORK.
8. ALL DIMENSIONS FROM EXISTING WALLS TO NEW FEATURES ARE FROM THE EXISTING FINISH FACE UNLESS NOTED OTHERWISE.
9. SEE ENGINEERING DRAWINGS FOR ADDITIONAL DEMOLITION REQUIREMENTS.

SEQUENCE NOTES

1. SEE DIVISION 00 SPECIFICATIONS FOR OTHER CONTRACTOR REQUIREMENTS.
2. THE DISTRICT WILL OCCUPY REMOTE LOCATIONS OF THIS CAMPUS FOR SUMMER SCHOOL. THE CONTRACTOR SHALL NOT IMPED THE OPERATIONS OR SAFETY OF THOSE AREAS WITHOUT ADVANCED PERMISSION FROM THE DISTRICT FM.
3. ALL DISTURBED SITE AREA SHALL BE REPAIRED.

REVISIONS AND UPDATES


02/14/14		CONSTRUCTION DOCUMENTS FOR BID/PERMIT

SUWANNEE COUNTY SCHOOL BOARD  
SUWANNEE PRIMARY SCHOOL  
ADDITIONS AND REMODELING  
1625 WALKER AVE., SW LIVE OAK, FLORIDA  
CONSTRUCTION SEQUENCE PLAN

drawn 02/18/14	CNK	checked 02/16/14	JCZ	approved	JCZ
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**RZK** ARCHITECTS RZK, INC.  
800 FLORIDA AVENUE SUITE 202 COCOA, FLORIDA 32922  
JOB NO. 20031  
A-0.0



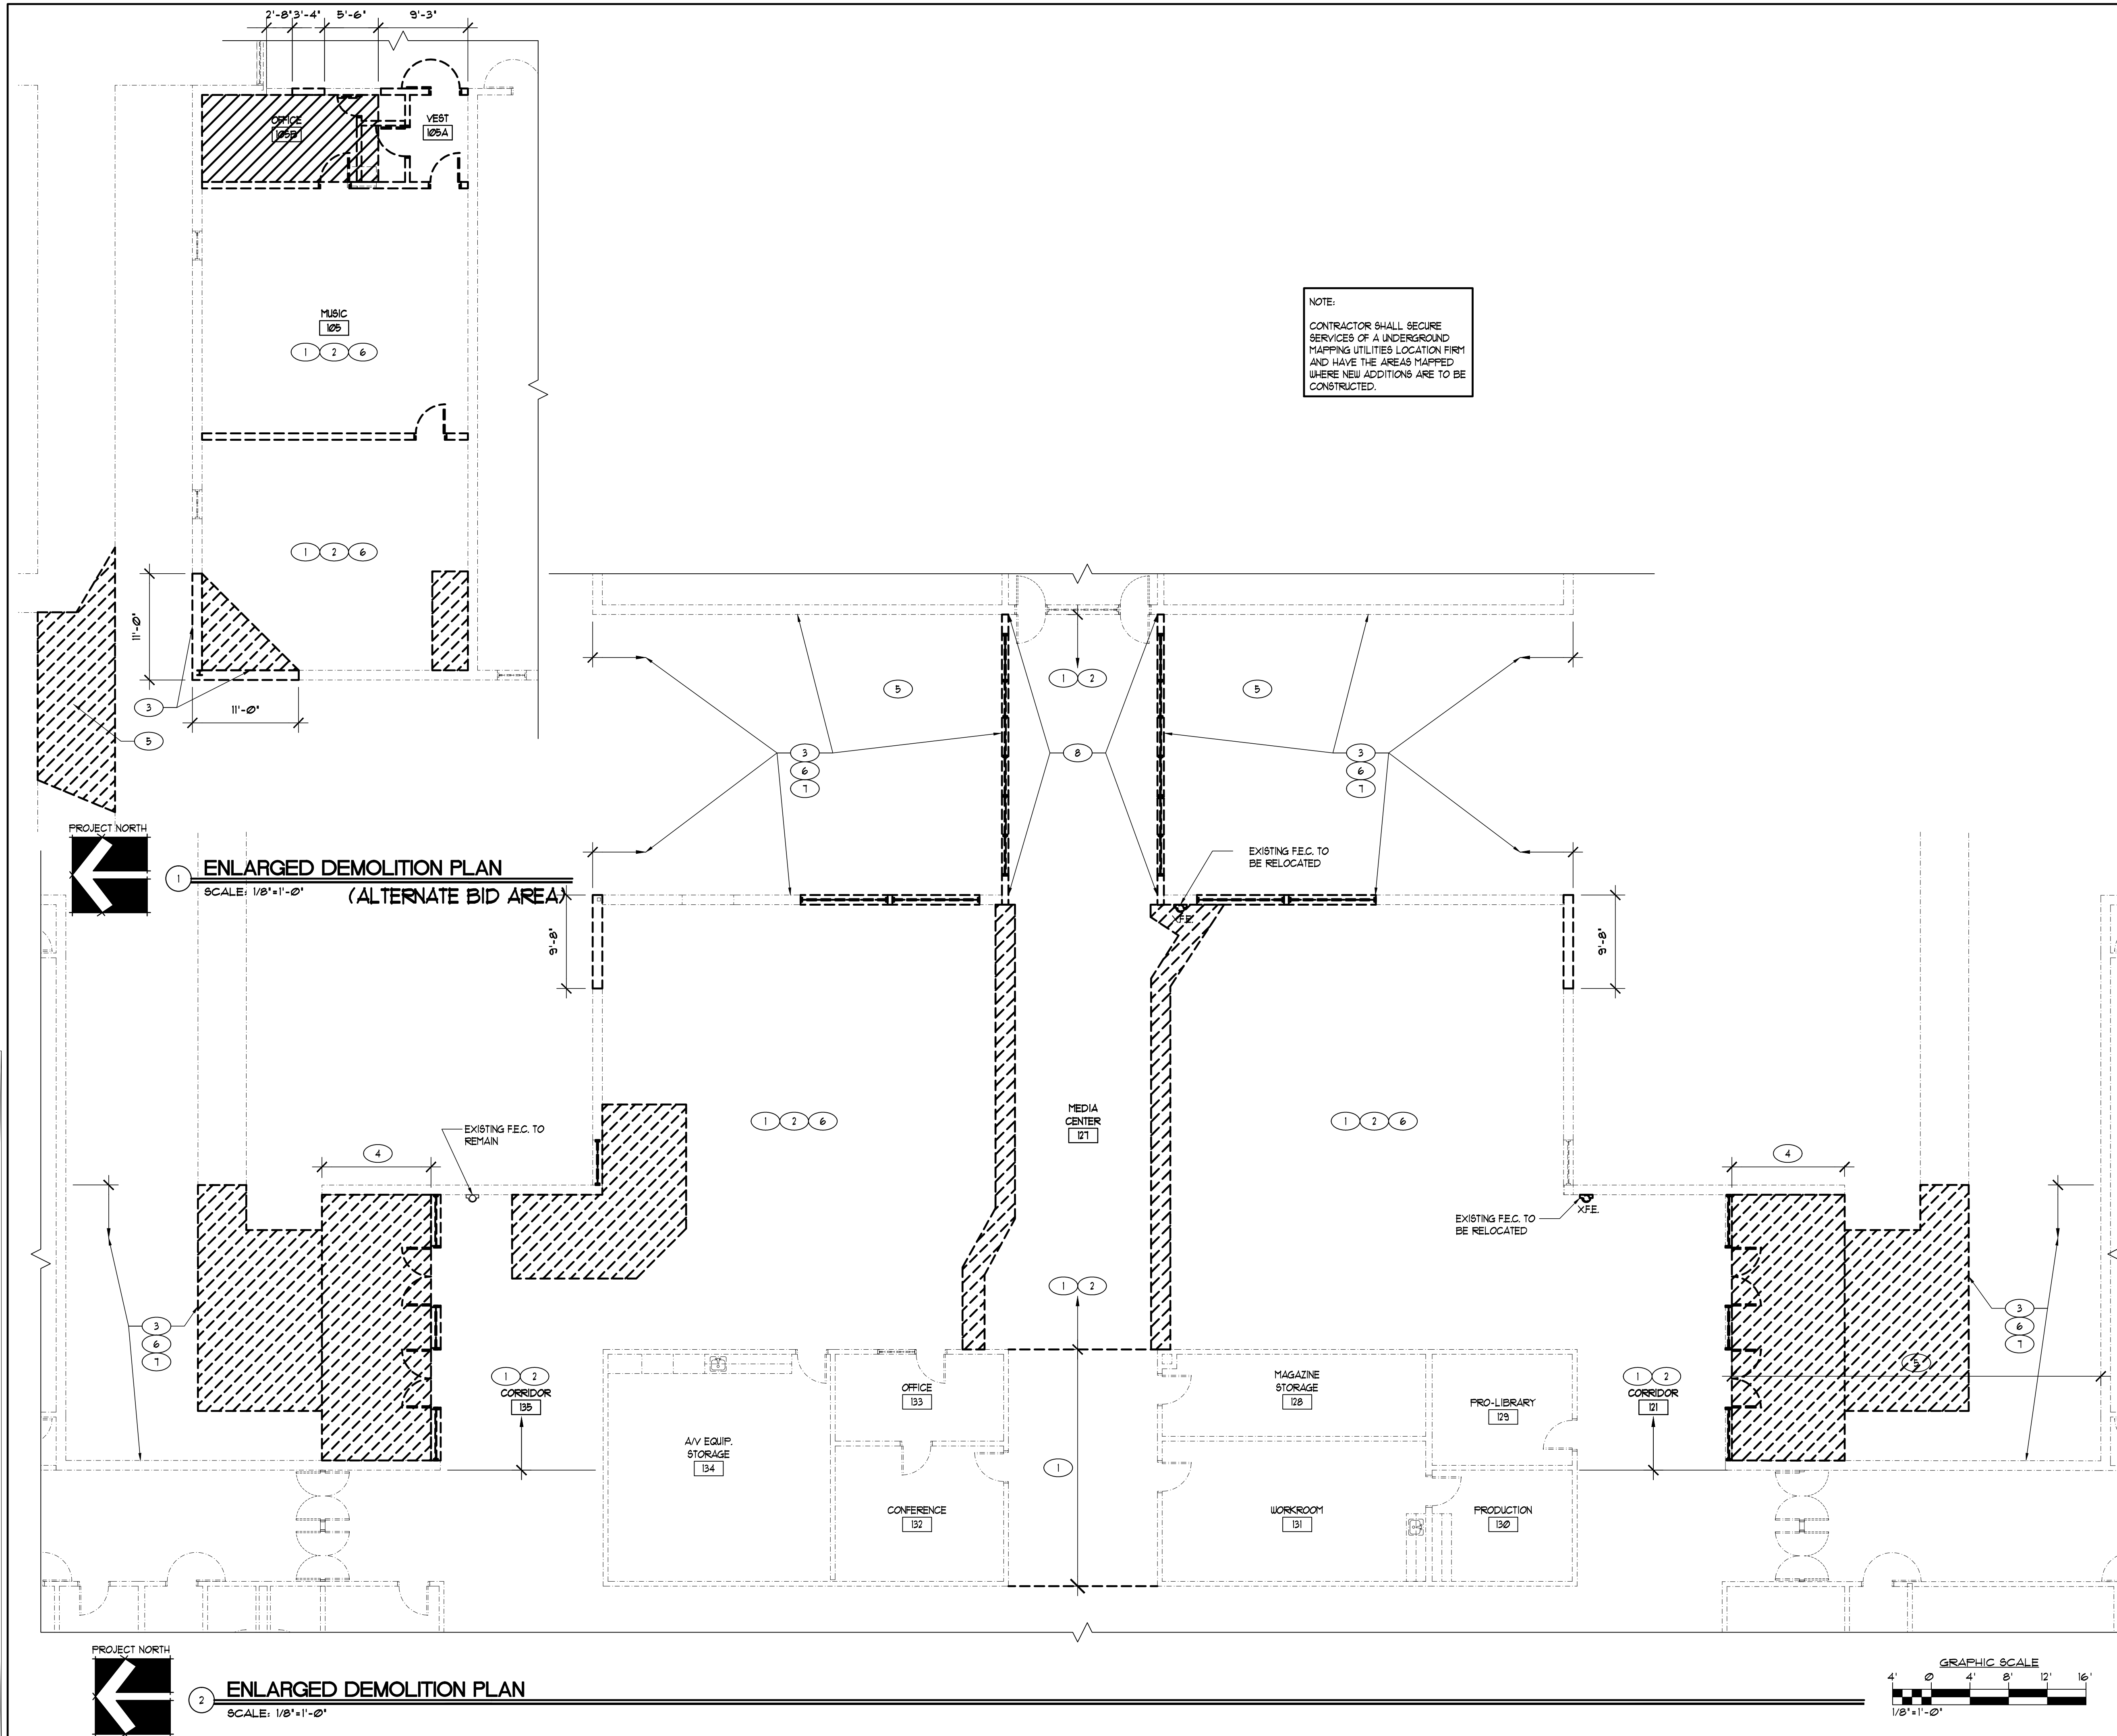

NOTE:  
CONTRACTOR SHALL SECURE  
SERVICES OF A UNDERGROUND  
MAPPING UTILITIES LOCATION FIRM  
AND HAVE THE AREAS MAPPED  
WHERE NEW ADDITIONS ARE TO BE  
CONSTRUCTED.

GENERAL NOTES

- CONTRACTOR TO COORDINATE WITH THE SCSSB-RM AND ARCHITECT PRIOR TO CONSTRUCTION AS TO SYSTEMS (FIRE, ELECT. AND MECH) THAT WILL BE AFFECTED AND ENSURE THAT DATA INTEGRITY AND POWER WILL BE MAINTAINED CONTINUOUSLY THROUGHOUT DEMOLITION AND CONSTRUCTION.
- ALL CONSTRUCTION REQUIRING THE DISRUPTION OF THE NORMAL WORKING ENVIRONMENT WILL BE SUBJECT TO APPROVAL AND COORDINATION WITH SCSSB-RM.
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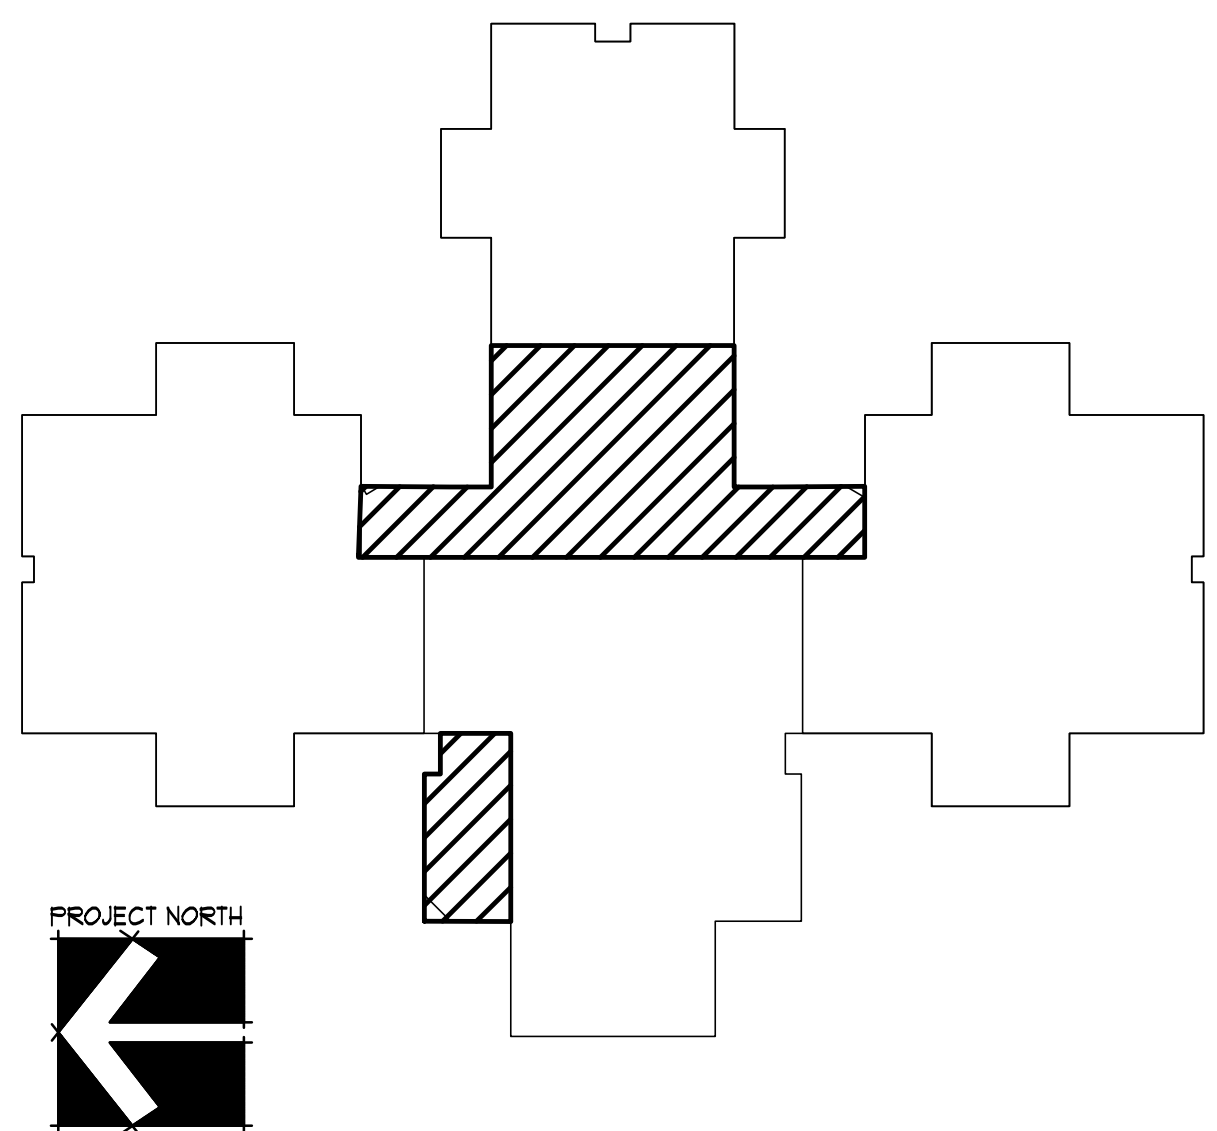
DEMOLITION LEGEND

- DENOTES EXISTING FEATURES TO REMAIN.
- - - - DENOTES EXISTING FEATURES TO BE DEMOLISHED OR RELOCATED.
- DENOTES EXISTING SLAB AREA TO BE REMOVED.

SPECIFIC DEMOLITION NOTES

- REMOVE ALL FLOORING AND WALL BASE.
- REMOVE EXISTING SUSPENDED CEILING.
- CAREFULLY REMOVE (CUT IF NECESSARY) PRECAST CONCRETE FASCIA PANELS ON OUTSIDE WALL TO ACCOMMODATE NEW WORK LIMITS. SOME EXISTING FASCIA PANELS ARE TO BE RELOCATED TO THE NEW CONSTRUCTIONS AREAS.
- REMOVE SOFFIT AND FRAMING.
- REMOVE STOOPS, WALKS, PLANTS, ETC. TO PREPARE AREA FOR NEW SLAB AND FOUNDATIONS.
- CLEAN AND PREP ROOM WALLS FOR NEW INTERIOR PAINT.
- CAREFULLY EXCAVATE AREAS FOR NEW ADDITION(S) TO LOCATE SANITARY, DOMESTIC WATER AND RAINWATER PIPING AND CONFIRM LOCATIONS.
- REMOVE ROOF ABOVE THIS AREA.

KEY PLAN



REVISIONS AND UPDATES

DATE	DESCRIPTION
02/14/14	CONSTRUCTION DOCUMENTS FOR BID/PERMIT

SUWANNEE COUNTY SCHOOL BOARD  
SUWANNEE PRIMARY SCHOOL  
ADDITIONS AND REMODELING  
1625 WALKER AVE. SW  
LIVE OAK, FLORIDA

ENLARGED DEMOLITION PLAN

drawn 02/18/14 CNK checked 02/16/14 JCZ approved JCZ

JOHN C. ZWICK, R.A.  
FL. REG. AR0009521



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800 FLORIDA AVENUE SUITE 202 COCOA, FLORIDA 32922 TELEPHONE (321) 631-8039

Job no. 20051

A-0.1



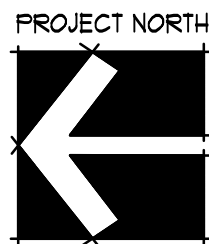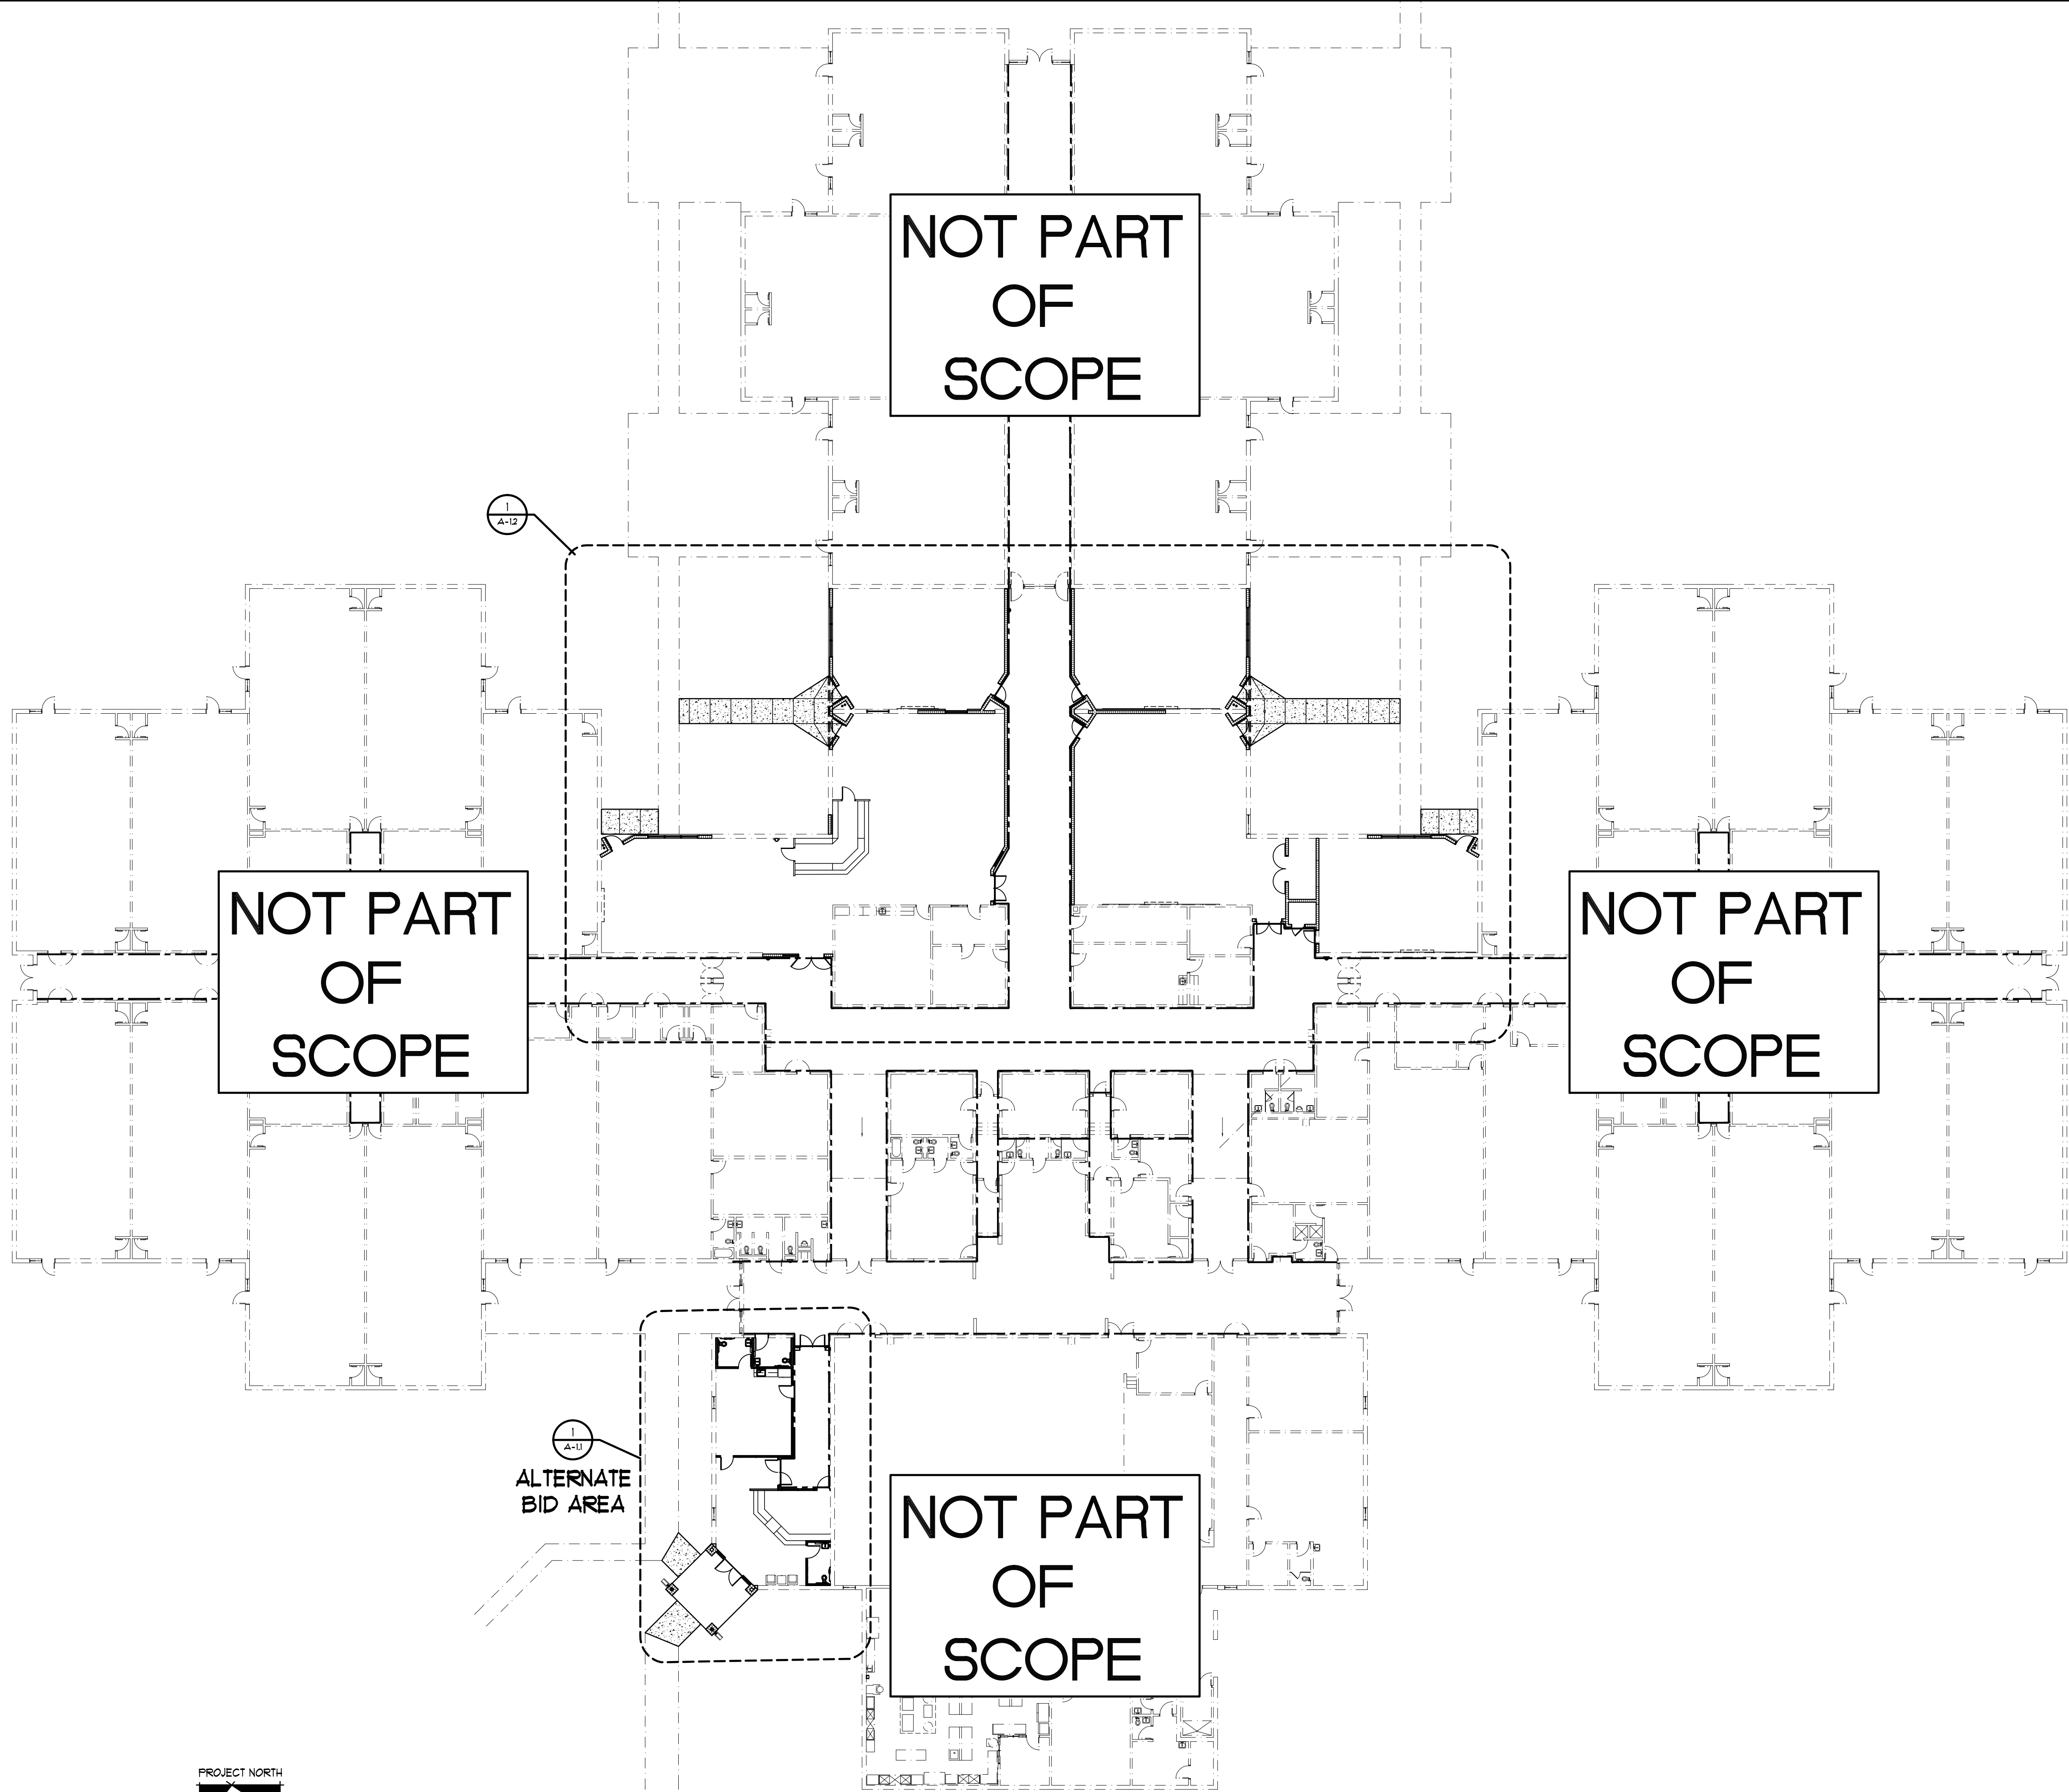

1 MASTER FLOOR PLAN  
SCALE: 1" = 20'

### GENERAL NOTES


1. CONTRACTOR TO COORDINATE WITH THE SCSS-RM AND ARCHITECT PRIOR TO CONSTRUCTION AS TO SYSTEMS (FIRE, ELECT. AND MECH) THAT WILL BE AFFECTED AND ENSURE THAT DATA INTEGRITY AND POWER WILL BE MAINTAINED CONTINUOUSLY THROUGHOUT DEMOLITION AND CONSTRUCTION.
2. ALL CONSTRUCTION REQUIRING THE DISRUPTION OF THE NORMAL WORKING ENVIRONMENT WILL BE SUBJECT TO APPROVAL AND COORDINATION WITH SCSS-RM.
3. TEMPORARY CONSTRUCTION BARRIERS WILL BE SET UP PRIOR TO CONSTRUCTION TO PROVIDE A DUST FREE SEAL OF THE SCSS OCCUPIED AREAS.
4. REPLACE ANY MISSING, DAMAGED, OR DIRTY CEILING TILES OR REPLACE ENTIRE CEILING IN ROOM.
5. REPAINT ALL PREVIOUS PAINTED WALLS IN RENOVATED AREAS.
6. PATCH, REPAIR & PAINT ALL ADJACENT AREAS DAMAGED BY DEMOLITION (TYPICAL).
7. ALL PLANS OF EXISTING CONDITIONS ARE BASED UPON THE ORIGINAL DESIGN DRAWINGS DATED 1914 BY ZEB LACKEY AND ASSOCIATES ARCHITECTS. EXISTING FEATURES MAY DIFFER, ESPECIALLY OUTSIDE OF THE AREAS OF MAJOR WORK.
8. ALL DIMENSIONS FROM EXISTING WALLS TO NEW FEATURES ARE FROM THE EXISTING FINISH FACE UNLESS NOTED OTHERWISE.
9. SEE ENGINEERING DRAWINGS FOR ADDITIONAL DEMOLITION REQUIREMENTS.

### REVISIONS AND UPDATES

02/14/14		CONSTRUCTION DOCUMENTS FOR BID/PERMIT

SUWANNEE COUNTY SCHOOL BOARD  
SUWANNEE PRIMARY SCHOOL  
ADDITIONS AND REMODELING  
1625 WALKER AVE., SW LIVE OAK, FLORIDA  
NEW MASTER FLOOR PLAN

drawn 02/18/14 CNK checked 02/16/14 JCZ approved JCZ

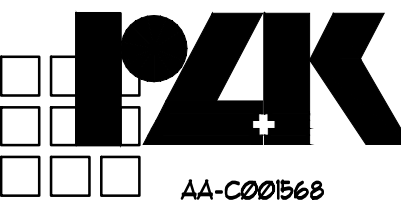


JOHN C. ZWICK, R.A.  
FL. REG. AR20009521

Job no. 200251

A-1.0

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ROOM NAME AND FINISH KEY LEGEND

ROOM NAME

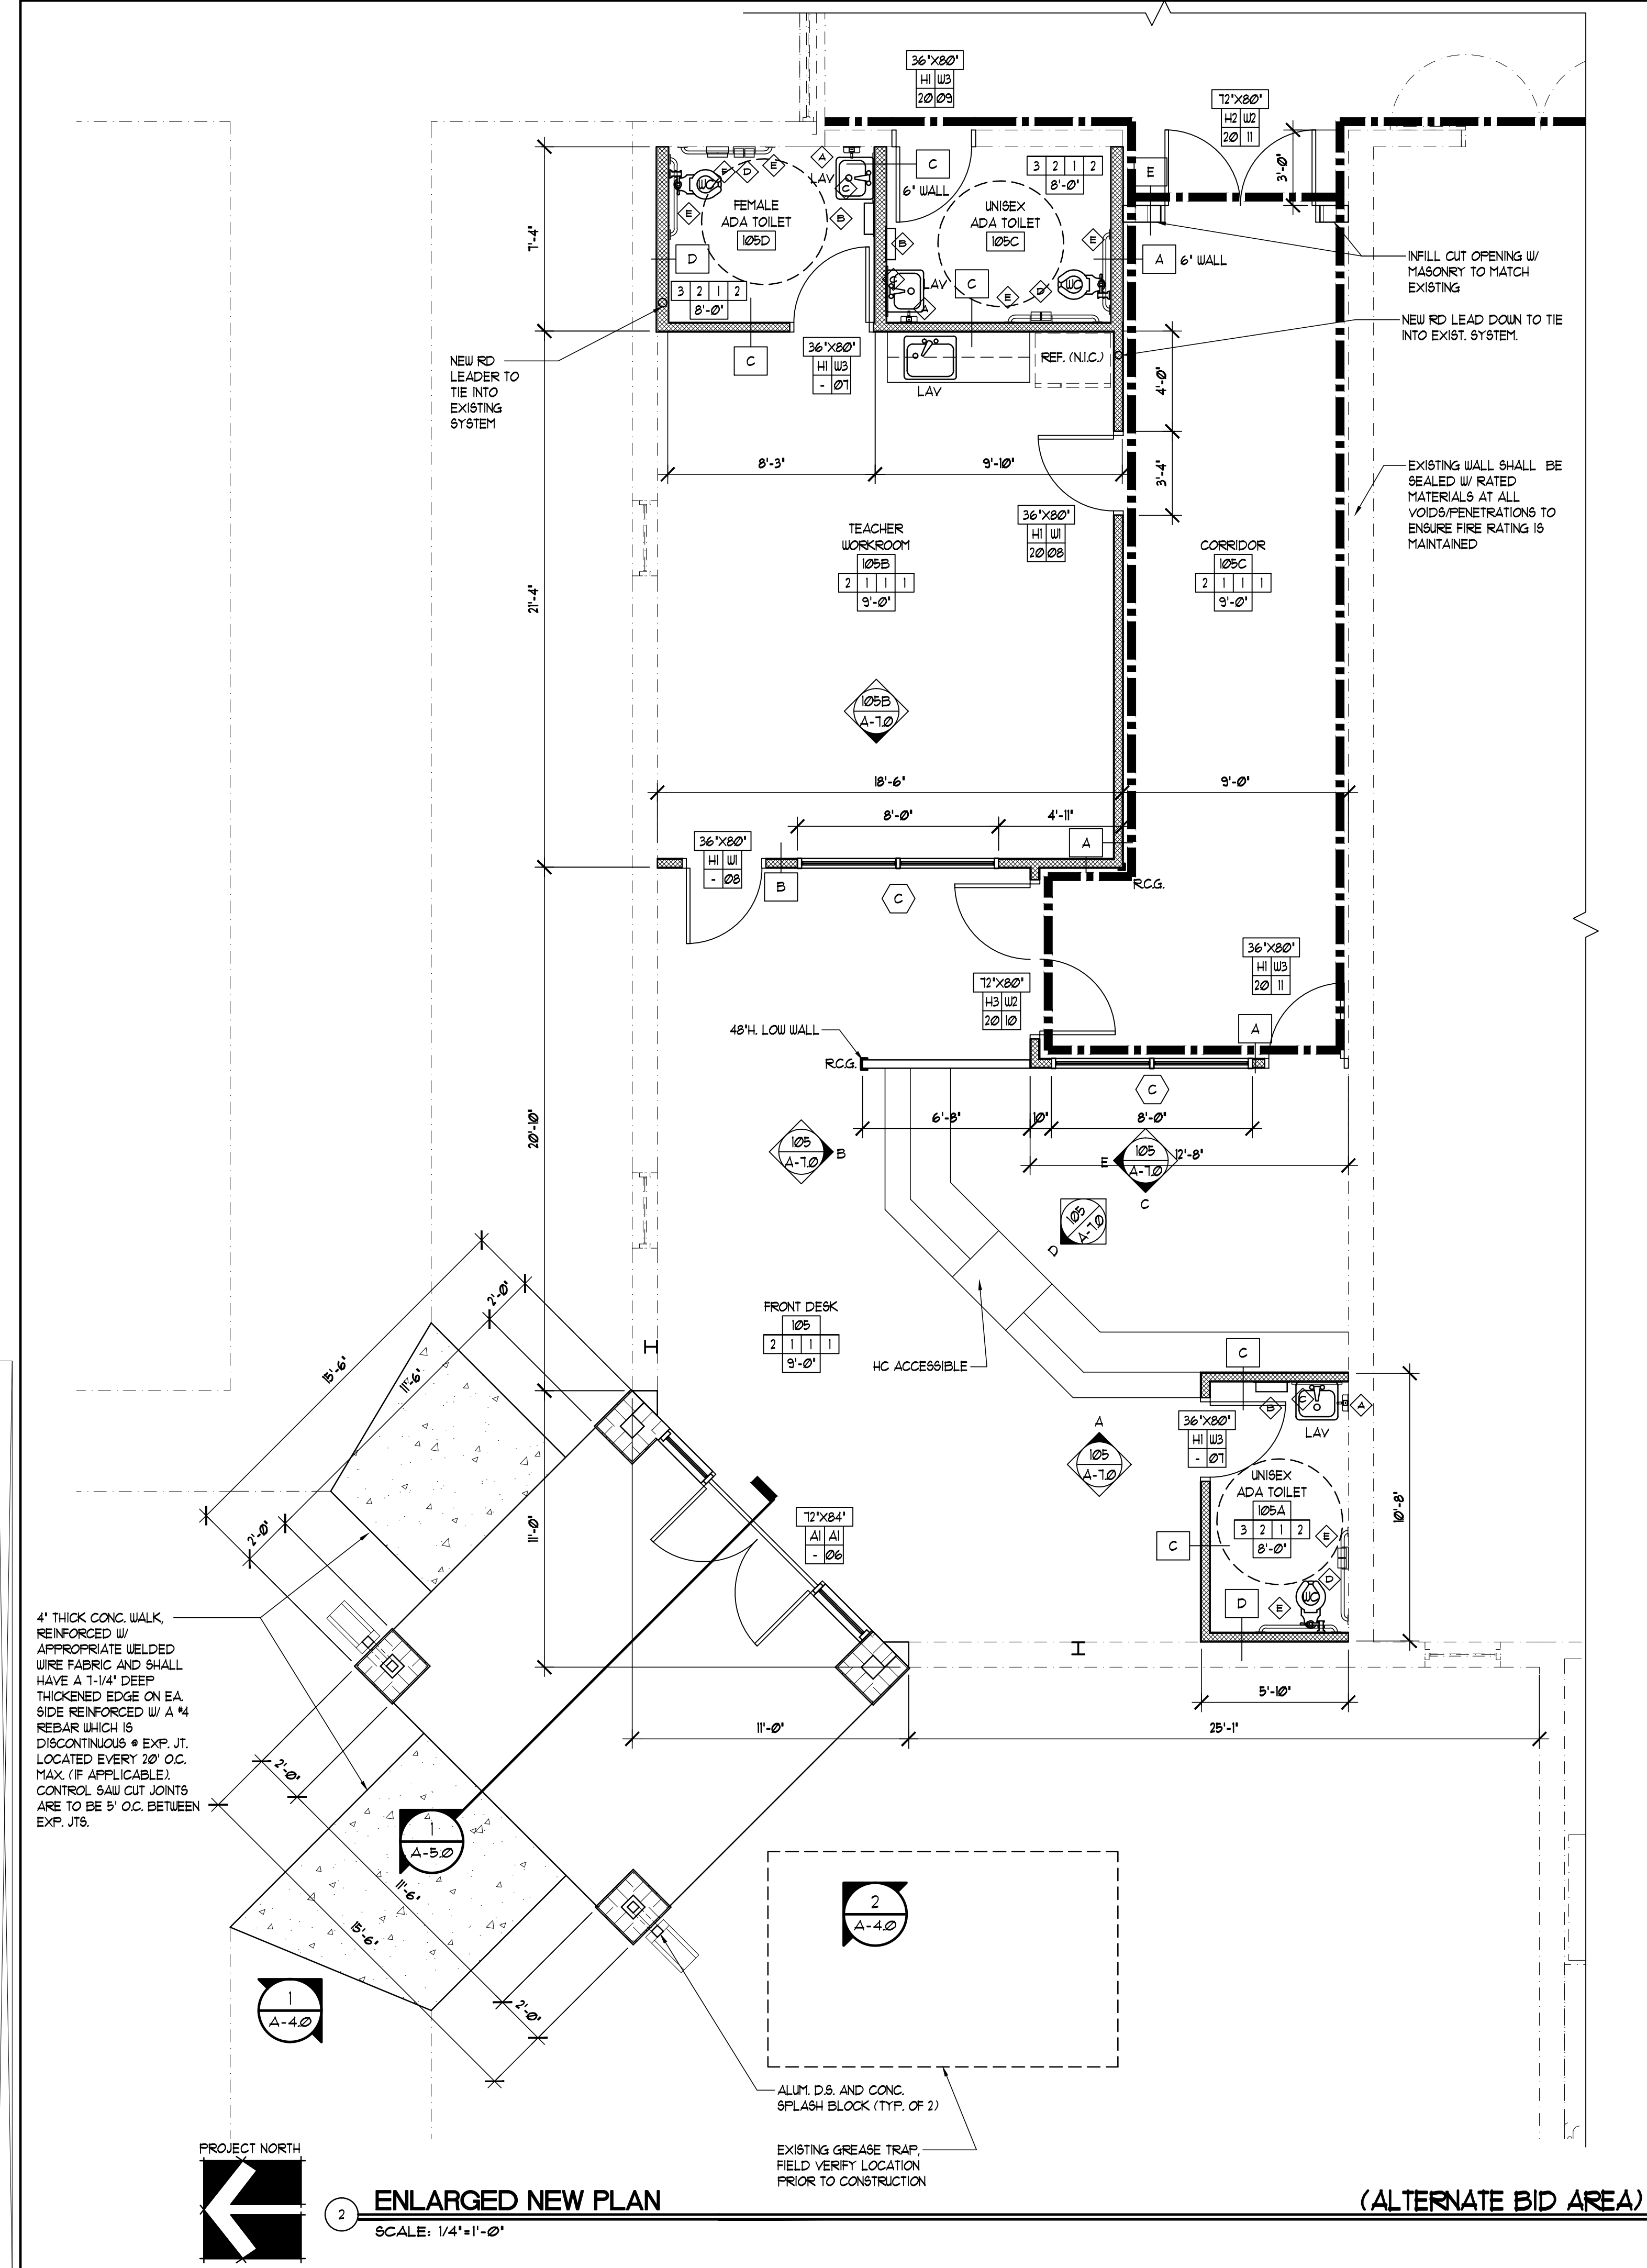FLOOR

BASE FINISH

FLOOR:  
1. CARPET  
2. VCT  
3. CERAMIC TILE  
4. EPOXY PAINTED CONCRETE

BASE:  
1. VINYL  
2. CERAMIC TILE

CEILING:  
1. ACOUSTIC TILE AND GRID  
2. PAINTED (DRYWALL)  
3. PAINTED (EXPOSED STRUCTURE)

WALL FINISH

CEILING FINISH

CEILING HEIGHT  
(ES = EXPOSED STRUCTURE)

DOOR TYPE LEGEND

DOOR SIZE

FRAME MAT./TYPE

FIRE RATING

GENERAL DOOR NOTES:  
1. SEE SHEET A-8.0 FOR ADDITIONAL INFORMATION

36"x80"  
HI | W3  
20 | 10

DOOR MAT./TYPE

HARDWARE SET

WALL LEGEND

EXISTING CONDITION

NOMINAL 4" OR 6" PARTITION WALL W/ ACOUSTICAL INSULATION AND 5/8" GYP. BOARD ON BOTH SIDES

1 HR FIRE RATED ASSEMBLY

FIRE EXTINGUISHER WALL BRACKET

FIRE EXTINGUISHER IN CABINET

EXISTING FIRE EXTINGUISHER IN CABINET

RECESSED CORNER GUARD

H.I.W.

HIGH IMPACT WALL COVERING

GENERAL NOTES

1. CONTRACTOR TO COORDINATE WITH THE SCSS-RM AND ARCHITECT PRIOR TO CONSTRUCTION AS TO SYSTEMS (FIRE, ELECT. AND MECH) THAT WILL BE AFFECTED AND ENSURE THAT DATA INTEGRITY AND POWER WILL BE MAINTAINED CONTINUOUSLY THROUGHOUT DEMOLITION AND CONSTRUCTION.

2. ALL CONSTRUCTION REQUIRING THE DISRUPTION OF THE NORMAL WORKING ENVIRONMENT WILL BE SUBJECT TO APPROVAL AND COORDINATION WITH SCSS-RM.

3. TEMPORARY CONSTRUCTION BARRIERS WILL BE SET UP PRIOR TO CONSTRUCTION TO PROVIDE A DUST FREE SEAL OF THE SCSS OCCUPIED AREAS.

4. REPLACE ANY MISSING, DAMAGED, OR DIRTY CEILING TILES OR REPLACE ENTIRE CEILING IN ROOM.

5. REPAINT ALL PREVIOUS PAINTED WALLS IN RENOVATED AREAS.

6. PATCH, REPAIR & PAINT ALL ADJACENT AREAS DAMAGED BY DEMOLITION (TYPICAL).

7. ALL PLANS OF EXISTING CONDITIONS ARE BASED UPON THE ORIGINAL DESIGN DRAWINGS DATED 1914 BY ZEB LACKEY AND ASSOCIATES ARCHITECTS. EXISTING FEATURES MAY DIFFER, ESPECIALLY OUTSIDE OF THE AREAS OF MAJOR WORK.

8. ALL DIMENSIONS FROM EXISTING WALLS TO NEW FEATURES ARE FROM THE EXISTING FINISH FACE UNLESS NOTED OTHERWISE.

9. SEE ENGINEERING DRAWINGS FOR ADDITIONAL DEMOLITION REQUIREMENTS.

ACCESSORY LEGEND

SYMBOL	ACCESSORY DESCRIPTION	NOTES
	SOAP DISPENSER	BY OWNER
	PAPER TOWEL DISPENSER	BY OWNER
	24" X 36" MIRROR	BY CONTRACTOR
	TOILET PAPER DISPENSER	BY CONTRACTOR
	ADA GRAB BAR	BY CONTRACTOR
	SANITARY NAPKIN DISPOSAL	BY CONTRACTOR
MB-1	MARKER BOARD	10'W X 4'H
MB-2	MARKER BOARD	12'W X 4'H
TB-1	TACK BOARD	4'W X 4'H
TB-2	TACK BOARD	3'W X 4'H
PS	PROJECTOR SCREEN	10'W X 10'H

NOTE:  
1. OWNER PROVIDED ITEMS TO BE INSTALLED BY CONTRACTOR.  
2. ALL SINKS IN TOILET ROOMS TO HAVE SOAP AND PAPER TOWEL DISPENSER, PROVIDED BY OWNER, CONTRACTOR INSTALLED.  
3. P.T. PLYWOOD BEHIND ALL WALL MOUNTED FIXTURES, PARTITIONS, ETC. FOR SUPPORT.

KEY PLAN

PROJECT NORTH

REVISIONS AND UPDATES

NO.	DATE	DESCRIPTION
1	02/14/14	CONSTRUCTION DOCUMENTS FOR BID/PERMIT

SUWANNEE COUNTY SCHOOL BOARD  
SUWANNEE PRIMARY SCHOOL  
ADDITIONS AND REMODELING  
1625 WALKER AVE., SW  
LIVE OAK, FLORIDA

ENLARGED NEW PLAN

drawn 02/18/14 CNK

checked 02/16/14 JCZ

approved JCZ

AA-C000568

JOHN C. ZWICK, R.A.  
FL. REG. AR0009521

Job no. 20031


ARCHITECTS RZK, INC.  
800 FLORIDA AVENUE SUITE 202 COCOA, FLORIDA 32922

TELEPHONE (321) 631-8030

A-1.1

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### DOOR TYPE LEGEND

DOOR SIZE: 36"x80"  
FRAME MAT./TYPE: HI | HI | - | 01  
FIRE RATING: - | 1  
DOOR MAT./TYPE: - | 1  
HARDWARE SET

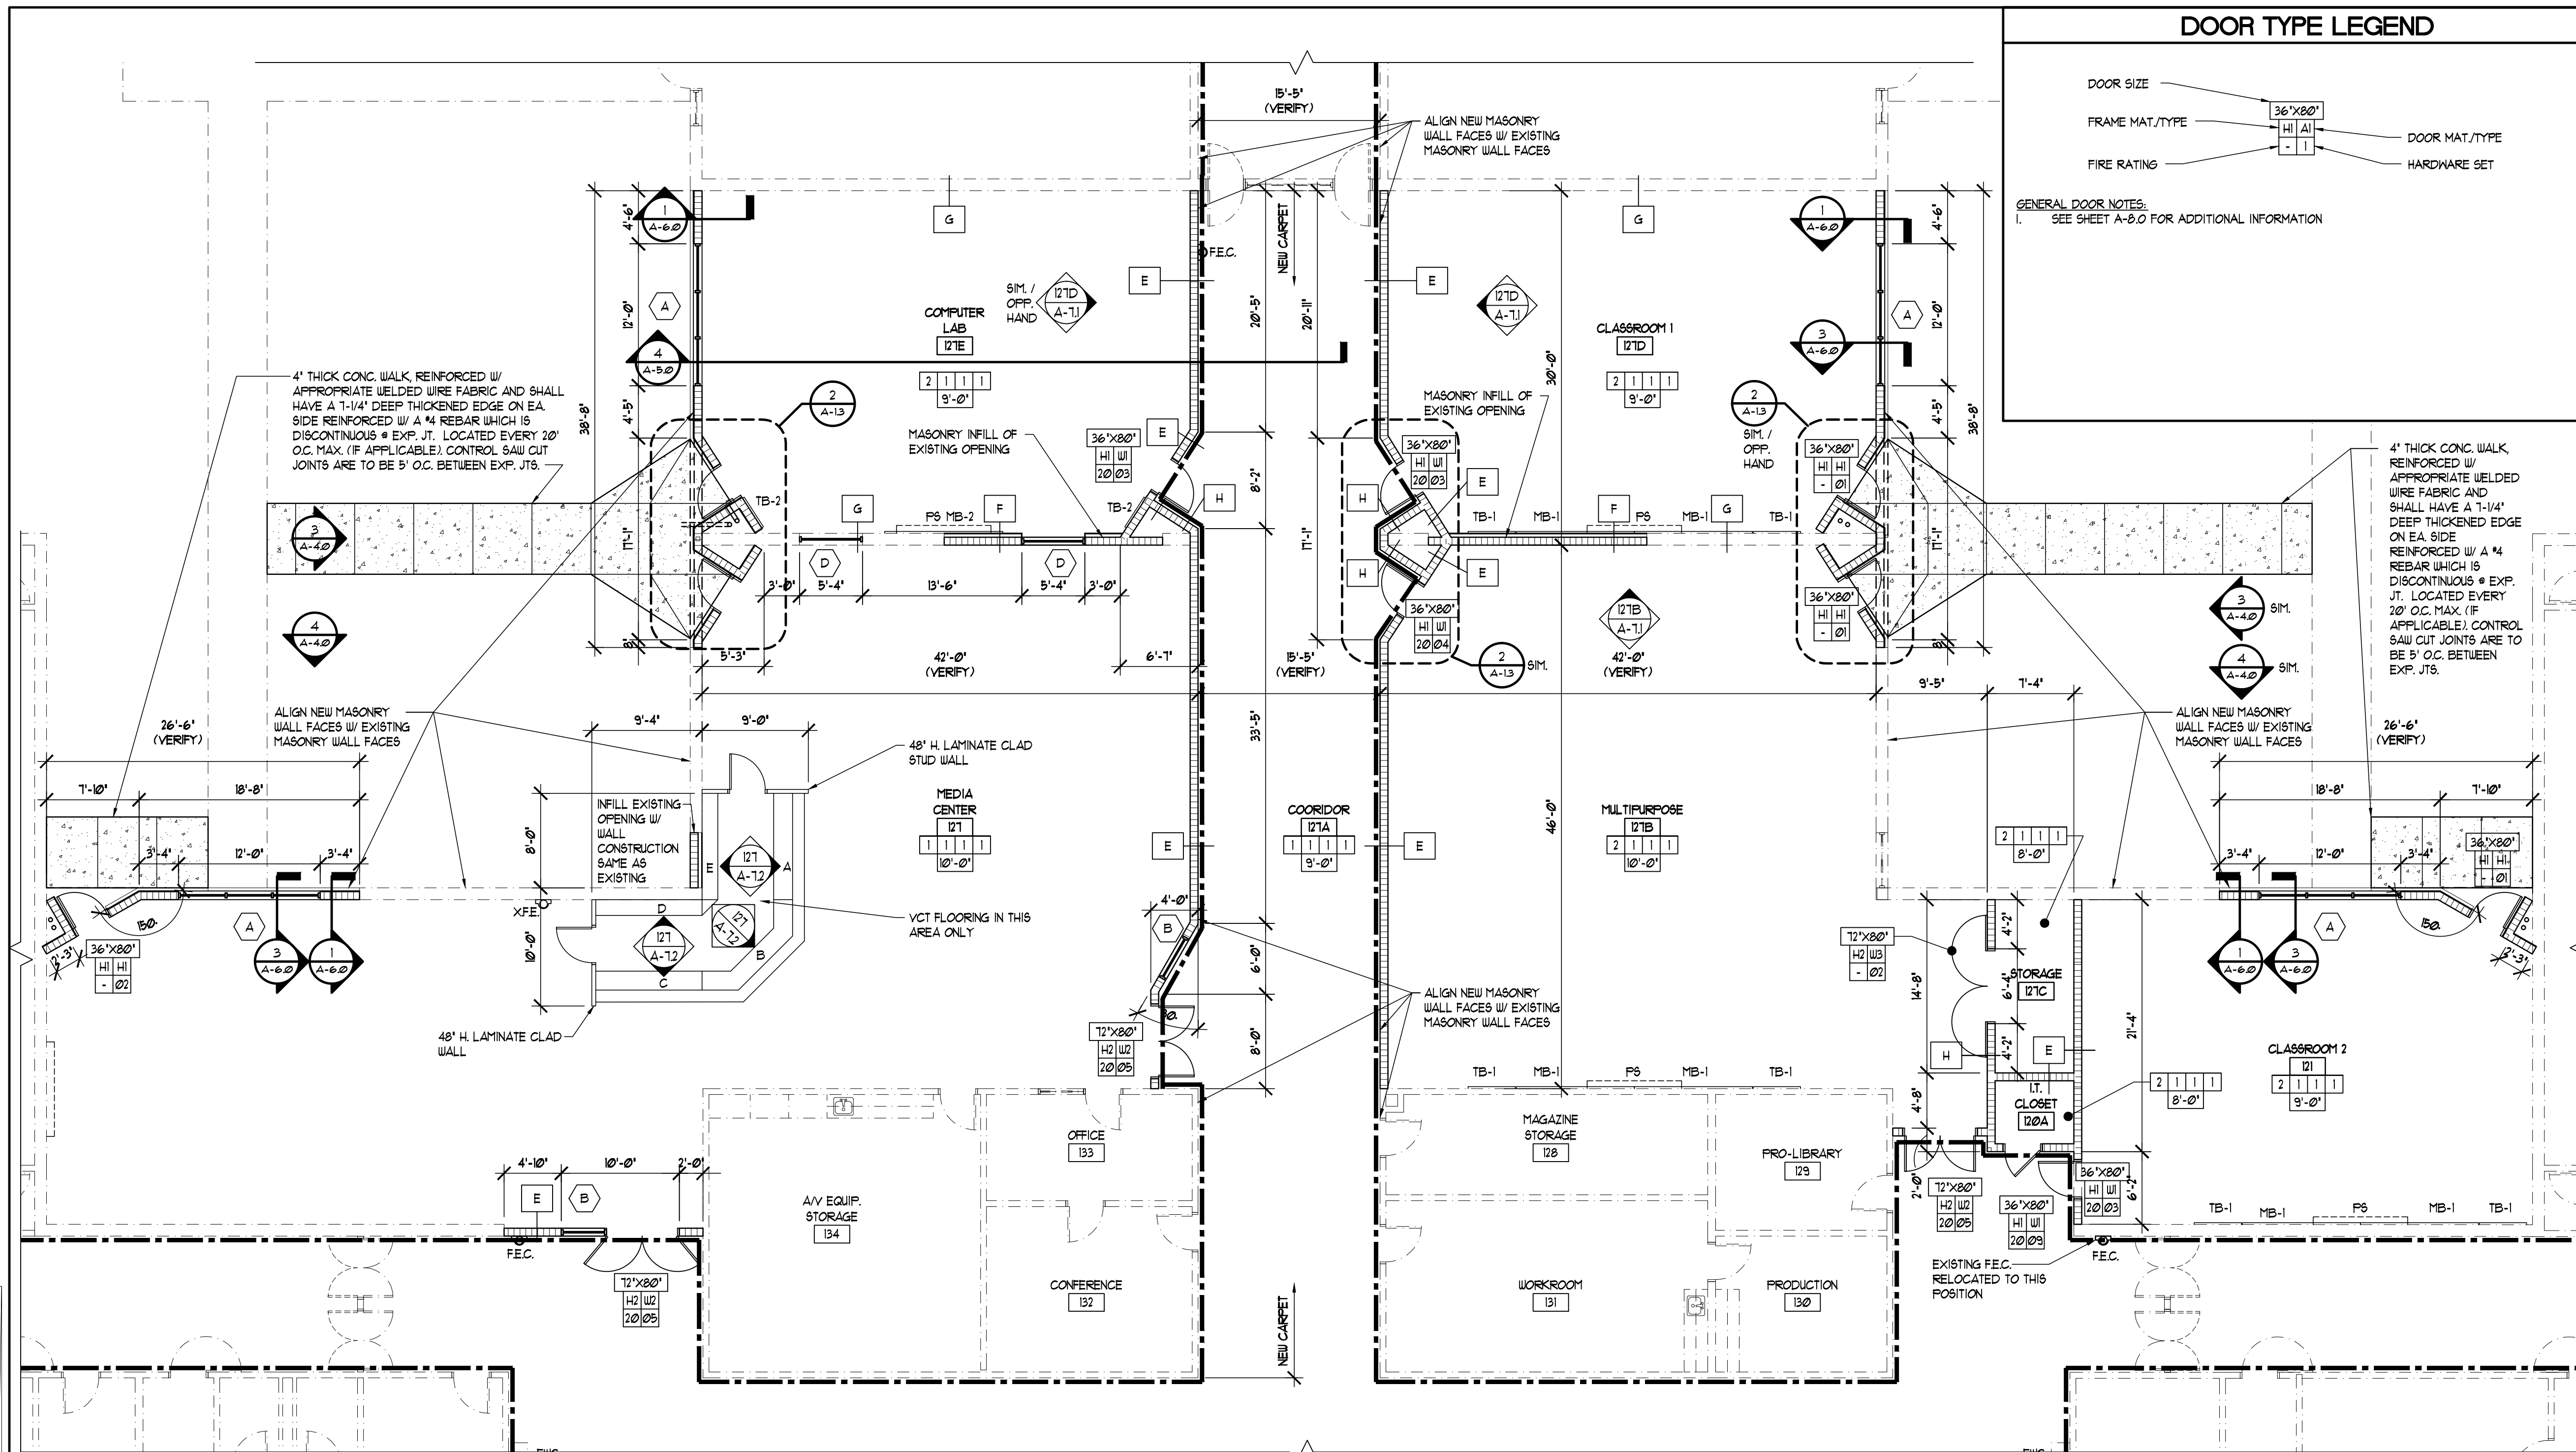GENERAL DOOR NOTES:  
1. SEE SHEET A-2.0 FOR ADDITIONAL INFORMATION

### GENERAL NOTES

- CONTRACTOR TO COORDINATE WITH THE SCSSB-PM AND ARCHITECT PRIOR TO CONSTRUCTION AS TO SYSTEMS (FIRE, ELEC. AND MECH) THAT WILL BE AFFECTED AND ENSURE THAT DATA INTEGRITY AND POWER WILL BE MAINTAINED CONTINUOUSLY THROUGHOUT DEMOLITION AND CONSTRUCTION.
- ALL CONSTRUCTION REQUIRING THE DISRUPTION OF THE NORMAL WORKING ENVIRONMENT WILL BE SUBJECT TO APPROVAL AND COORDINATION WITH SCSSB-PM.
- TEMPORARY CONSTRUCTION BARRIERS WILL BE SET UP PRIOR TO CONSTRUCTION TO PROVIDE A DUST FREE SEAL OF THE SCSSB OCCUPIED AREAS.
- REPLACE ANY MISSING, DAMAGED, OR DIRTY CEILING TILES OR REPLACE ENTIRE CEILING IN ROOM.
- REPAINT ALL PREVIOUS PAINTED WALLS IN RENOVATED AREAS.
- PATCH, REPAIR & PAINT ALL ADJACENT AREAS DAMAGED BY DEMOLITION (TYPICAL).
- ALL PLANS OF EXISTING CONDITIONS ARE BASED UPON THE ORIGINAL DESIGN DRAWINGS DATED 1914 BY ZEB LACKEY AND ASSOCIATES ARCHITECTS. EXISTING FEATURES MAY DIFFER, ESPECIALLY OUTSIDE OF THE AREAS OF MAJOR WORK.
- ALL DIMENSIONS FROM EXISTING WALLS TO NEW FEATURES ARE FROM THE EXISTING FINISH FACE UNLESS NOTED OTHERWISE.
- SEE ENGINEERING DRAWINGS FOR ADDITIONAL DEMOLITION REQUIREMENTS.

### ROOM NAME AND FINISH KEY LEGEND

ROOM NAME: CORRIDOR  
FLOOR: 100  
BASE FINISH: 100  
WALL FINISH: 100  
CEILING FINISH: 100  
CEILING HEIGHT (ES = EXPOSED STRUCTURE): 9'-0"

FLOOR:  
1. CARPET  
2. VCT  
3. CERAMIC TILE  
4. EPOXY PAINTED CONCRETE

WALLS:  
1. PAINTED (DRYWALL OR EXISTING PATCHED AND REPAIRED)  
2. EPOXY PAINTED (DRYWALL OR EXISTING PATCHED AND REPAIRED)

BASE:  
1. VINYL  
2. CERAMIC TILE

CEILING:  
1. ACOUSTIC TILE AND GRID  
2. PAINTED (DRYWALL)  
3. PAINTED (EXPOSED STRUCTURE)

### KEY PLAN

### REVISIONS AND UPDATES

NO.	DATE	DESCRIPTION
1	02/14/14	CONSTRUCTION DOCUMENTS FOR BID/PERMIT

PROJECT NORTH

### ENLARGED NEW PLAN

SCALE: 1/8"=1'-0"

PROJECT NORTH

### ENLARGED PLAN

SCALE: 1/4"=1'-0"

PROJECT NORTH

### ACCESSORY LEGEND

SYMBOL	ACCESSORY DESCRIPTION	NOTES
◇	SOAP DISPENSER	BY OWNER
◇	PAPER TOWEL DISPENSER	BY OWNER
◇	24" X 36" MIRROR	BY CONTRACTOR
◇	TOILET PAPER DISPENSER	BY CONTRACTOR
◇	ADA GRAB BAR	BY CONTRACTOR
◇	SANITARY NAPKIN DISPOSAL	BY CONTRACTOR
MB-1	MARKER BOARD	10'W X 4'H
TB-1	TACK BOARD	4'W X 4'H
TB-2	TACK BOARD	3'W X 4'H
FS	PROJECTOR SCREEN	10'W X 10'H

NOTE:  
1. OWNER PROVIDED ITEMS TO BE INSTALLED BY CONTRACTOR.  
2. ALL SINKS IN TOILET ROOMS TO HAVE SOAP AND PAPER TOWEL DISPENSER, PROVIDED BY OWNER, CONTRACTOR INSTALLED.  
3. P.T. PLYWOOD BEHIND ALL WALL MOUNTED FIXTURES, PARTITIONS, ETC. FOR SUPPORT.

### WALL LEGEND

EXISTING CONDITION  
NOMINAL 4" OR 6" PARTITION WALL W/ ACOUSTICAL INSULATION AND 5/8" GYP. BOARD ON BOTH SIDES

1 HR FIRE RATED ASSEMBLY  
F.E. FIRE EXTINGUISHER WALL BRACKET  
R.F.E. FIRE EXTINGUISHER IN CABINET  
X.F.E. EXISTING FIRE EXTINGUISHER IN CABINET  
R.C.G. RECESSED CORNER GUARD  
H.W. HIGH IMPACT WALL COVERING

GRAPHIC SCALE  
4' 0' 4' 8' 12' 16'  
1/8"=1'-0"

### ARCHITECTS RZK, INC.

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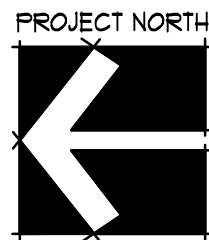
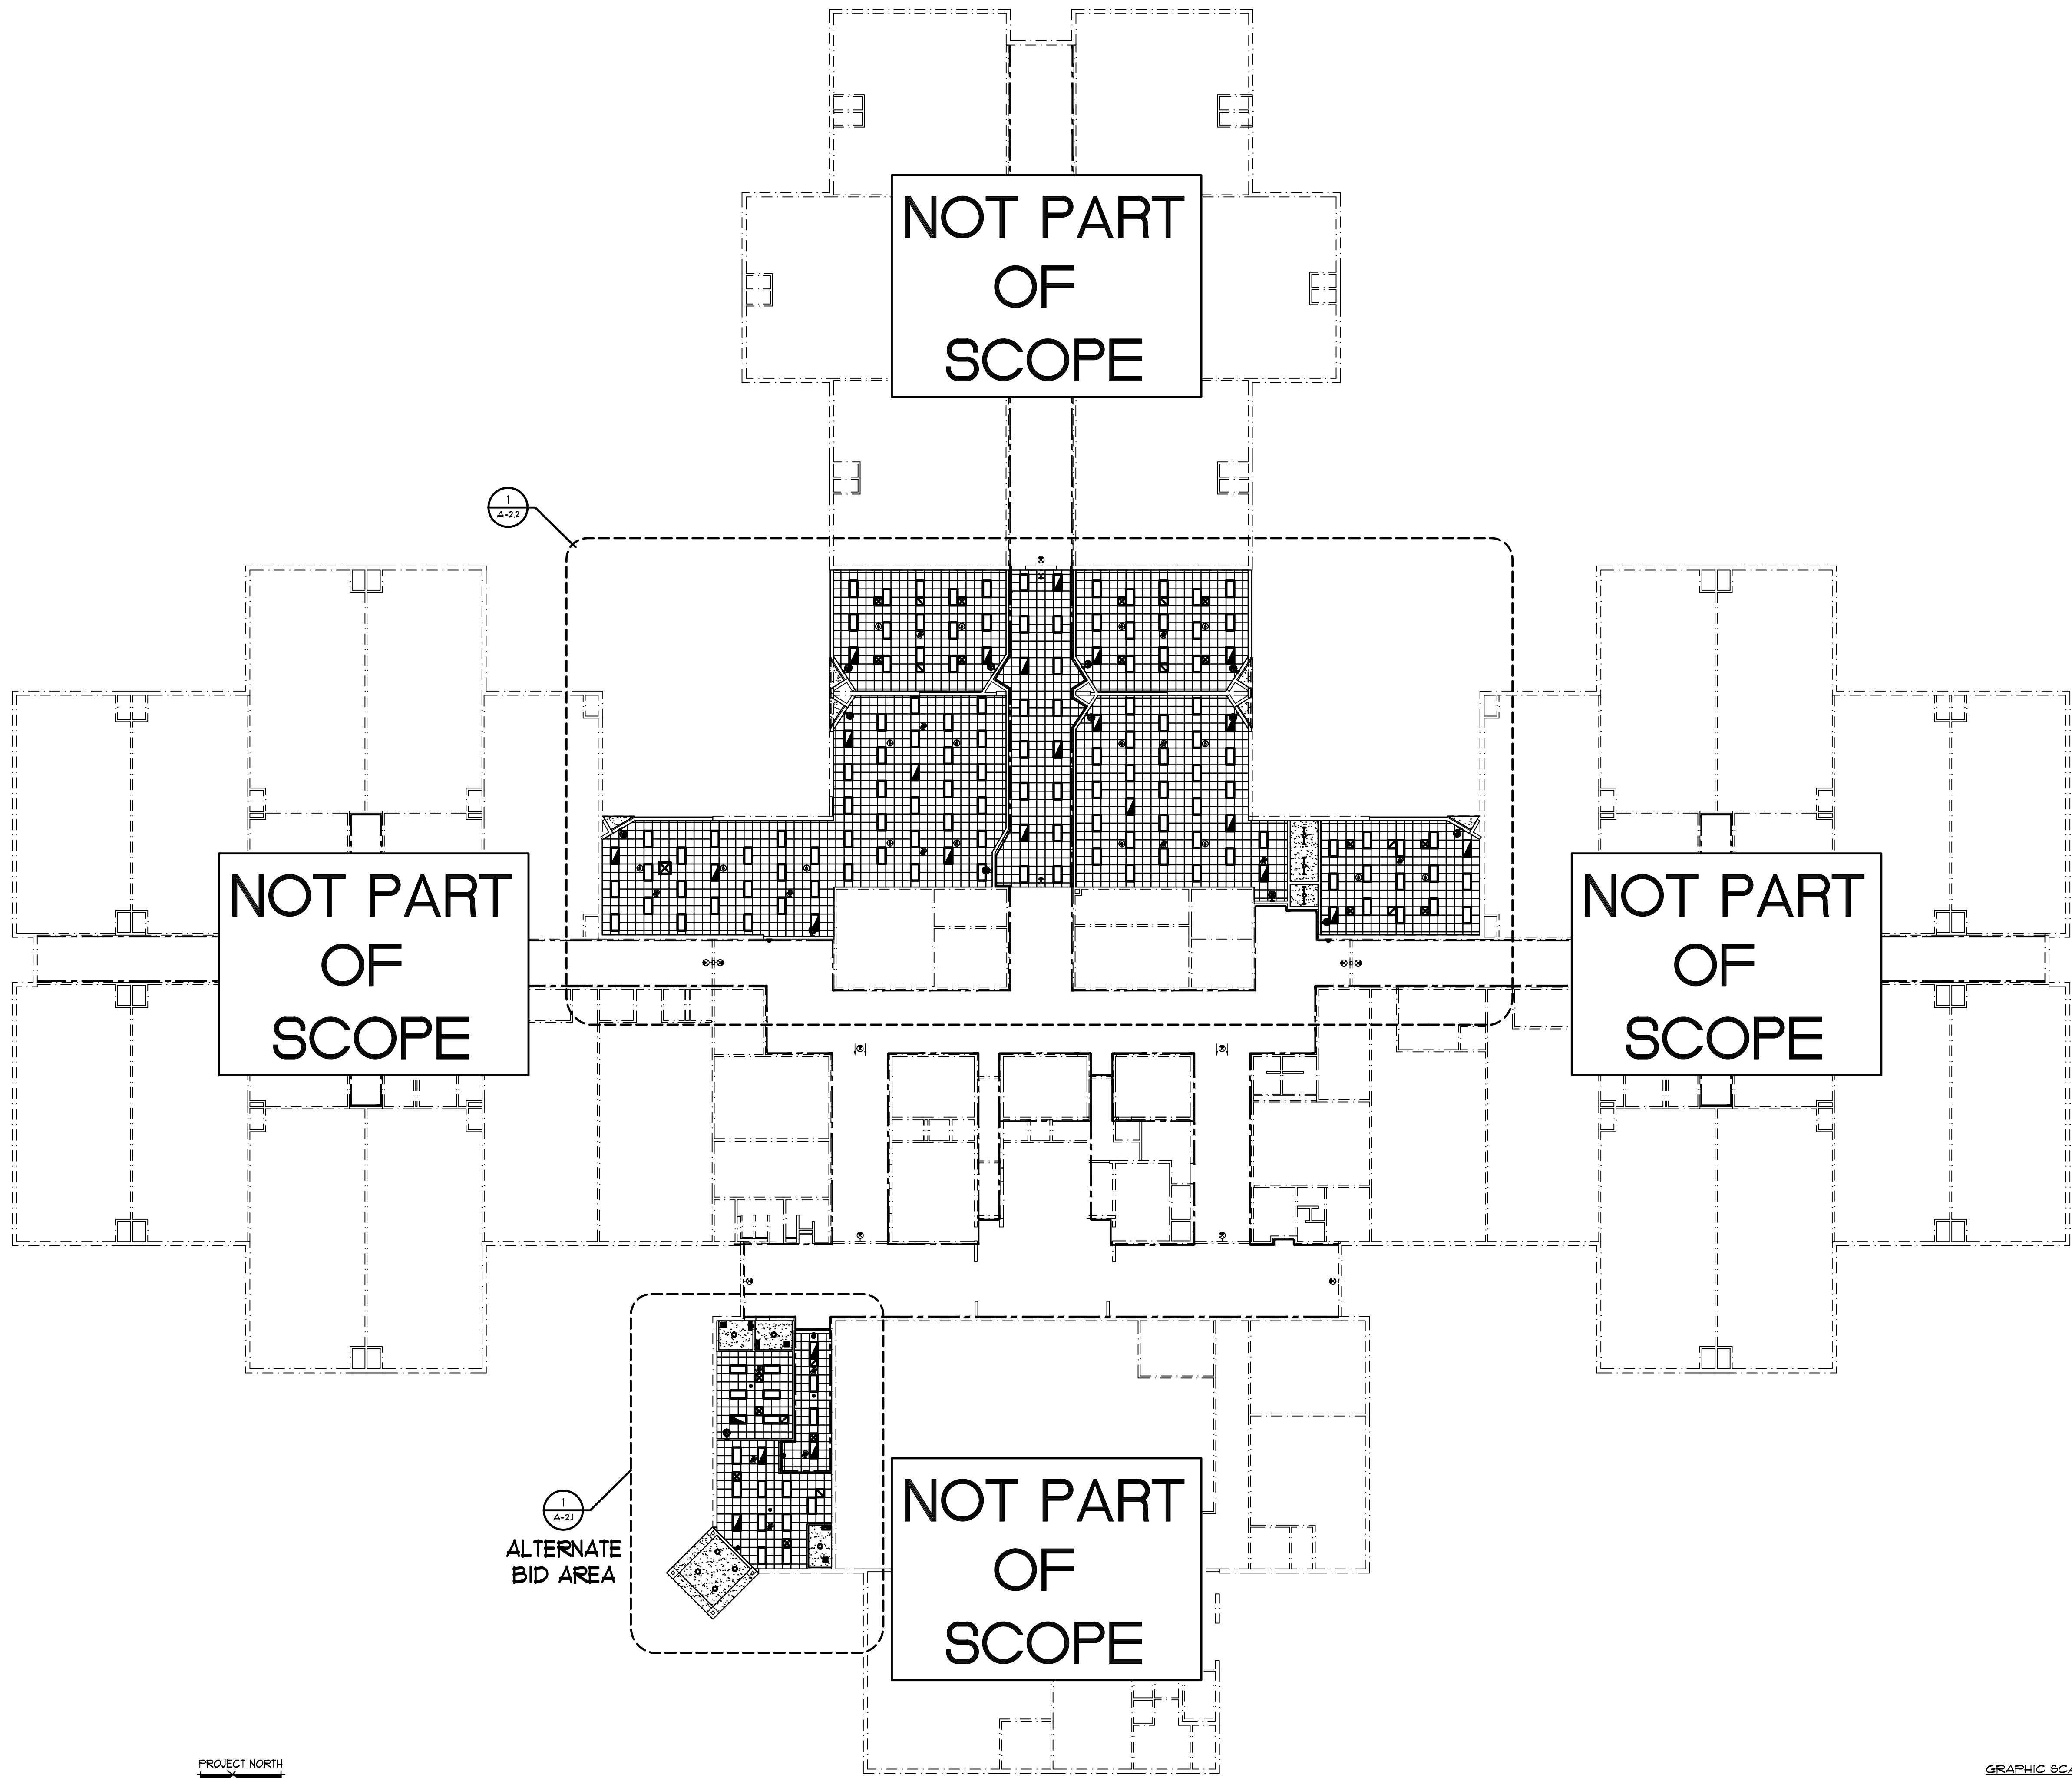
JOHN C. ZWICK, R.A.  
FL. REG. AR0009521

AA-C000568


job no. 20031

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1 **OVERALL REFLECTED FLOOR PLAN**  
SCALE: 1" = 20'



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### REFLECTED CEILING PLAN NOTES

- ALL DETAILS AND SECTIONS SHOWN ON THE DRAWINGS ARE INTENDED TO BE TYPICAL AND SHALL BE CONSTRUED TO APPLY TO ANY SIMILAR SITUATION ELSEWHERE ON THE PROJECT EXCEPT WHERE A DIFFERENT DETAIL IS SHOWN, REFER TO FLOOR PLANS, ELEVATIONS, SECTIONS, AND SPEC. BOOK FOR ADDITIONAL DETAIL REFERENCES.
- ARCHITECTURAL DRAWINGS TAKE PRECEDENCE OVER MECHANICAL AND ELECTRICAL FOR LOCATION OF LIGHTS, GRILLES, DIFFUSERS, CEILING GRIDS, AND SIMILAR ITEMS. IF A DISCREPANCY EXISTS WITH QUANTITIES, NOTIFY ARCHITECT IMMEDIATELY. FOLLOW ARCHITECTURAL PLANS FOR LOCATION OF MECHANICAL DIFFUSERS AND RETURN AIR GRILLES. GRILLES AND DIFFUSERS INDICATED ON MECHANICAL DRAWINGS BUT NOT SHOWN ON ARCHITECTURAL ARE TO BE COORDINATED BETWEEN ARCHITECTURAL AND MECHANICAL DRAWINGS BY ARCHITECT DURING CONSTRUCTION.
- REFER TO REFLECTED CEILING PLANS FOR FIRE RATED WALL LOCATIONS.
- EVERY EFFORT MUST BE MADE TO GIVE CEILING A CLEAN AND WELL ORGANIZED APPEARANCE.
- ANY VARIATION IN PLANS MUST BE APPROVED BY ARCHITECT PRIOR TO WORK.
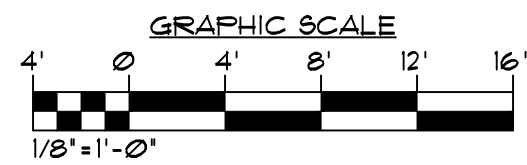
### REFLECTED CEILING LEGEND


- SUPPLY AIR
- RETURN AIR
- EXHAUST FAN
- DIAGONAL SHADING DENOTES EMERGENCY LIGHT FIXTURE
- 2X4 FLUORESCENT RECESSED LIGHT FIXTURE
- BARE FLUORESCENT LIGHT FIXTURE
- WALL MOUNTED LIGHT FIXTURE
- EXIT LIGHT FIXTURE: CEILING MOUNTED / WALL MOUNTED
- WALL MOUNT LIGHT FIXTURE
- 2X2 SUSPENDED ACOUSTICAL CEILING
- 2X4 SUSPENDED ACOUSTICAL CEILING
- GYPSUM BOARD CEILING
- STUCCO CEILING
- 1 HR FIRE RATED WALL/PARTITION
- OCCUPANCY SENSOR
- SMOKE DETECTOR
- HEAT DETECTOR
- SPEAKER
- EXISTING
- NEW

### REVISIONS AND UPDATES

02/14/14		CONSTRUCTION DOCUMENTS FOR BID/PERMIT

SUWANNEE COUNTY SCHOOL BOARD  
SUWANNEE PRIMARY SCHOOL  
ADDITIONS AND REMODELING  
1625 WALKER AVE. SW LIVE OAK, FLORIDA  
NEW REFLECTED CEILING PLAN

drawn 02/18/14 CNK checked 02/16/14 JCZ approved JCZ

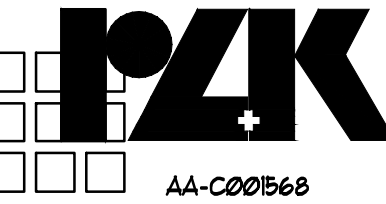

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FL. REG. AR0009521

Job no. 20051

A-2.0

ARCHITECTS RZK, INC.  
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REFLECTED CEILING PLAN NOTES

- ALL DETAILS AND SECTIONS SHOWN ON THE DRAWINGS ARE INTENDED TO BE TYPICAL AND SHALL BE CONSTRUED TO APPLY TO ANY SIMILAR SITUATION ELSEWHERE ON THE PROJECT EXCEPT WHERE A DIFFERENT DETAIL IS SHOWN, REFER TO FLOOR PLANS, ELEVATIONS, SECTIONS, AND SPEC. BOOK FOR ADDITIONAL DETAIL REFERENCES.
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- ANY VARIATION IN PLANS MUST BE APPROVED BY ARCHITECT PRIOR TO WORK.

REFLECTED CEILING LEGEND

- SUPPLY AIR
- RETURN AIR
- EXHAUST FAN
- DIAGONAL SHADING DENOTES EMERGENCY LIGHT FIXTURE
- 2X4 FLUORESCENT RECESSED LIGHT FIXTURE
- BARE FLUORESCENT LIGHT FIXTURE
- WALL MOUNTED LIGHT FIXTURE
- EXIT LIGHT FIXTURE: CEILING MOUNTED / WALL MOUNTED
- WALL MOUNT LIGHT FIXTURE
- 2X2 SUSPENDED ACOUSTICAL CEILING
- 2X4 SUSPENDED ACOUSTICAL CEILING
- GYPSUM BOARD CEILING
- STUCCO CEILING
- 1 HR FIRE RATED WALL/PARTITION
- OCCUPANCY SENSOR
- SMOKE DETECTOR
- HEAT DETECTOR
- SPEAKER
- EXISTING
- NEW

REVISIONS AND UPDATES



02/14/14		CONSTRUCTION DOCUMENTS FOR BID/PERMIT

SUWANNEE COUNTY SCHOOL BOARD  
SUWANNEE PRIMARY SCHOOL  
ADDITIONS AND REMODELING  
1625 WALKER AVE., SW LIVE OAK, FLORIDA  
NEW ENLARGED REFLECTED CEILING PLAN

drawn 02/18/14 CNK checked 02/16/14 JCZ approved JCZ


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JOHN C. ZWICK, R.A.  
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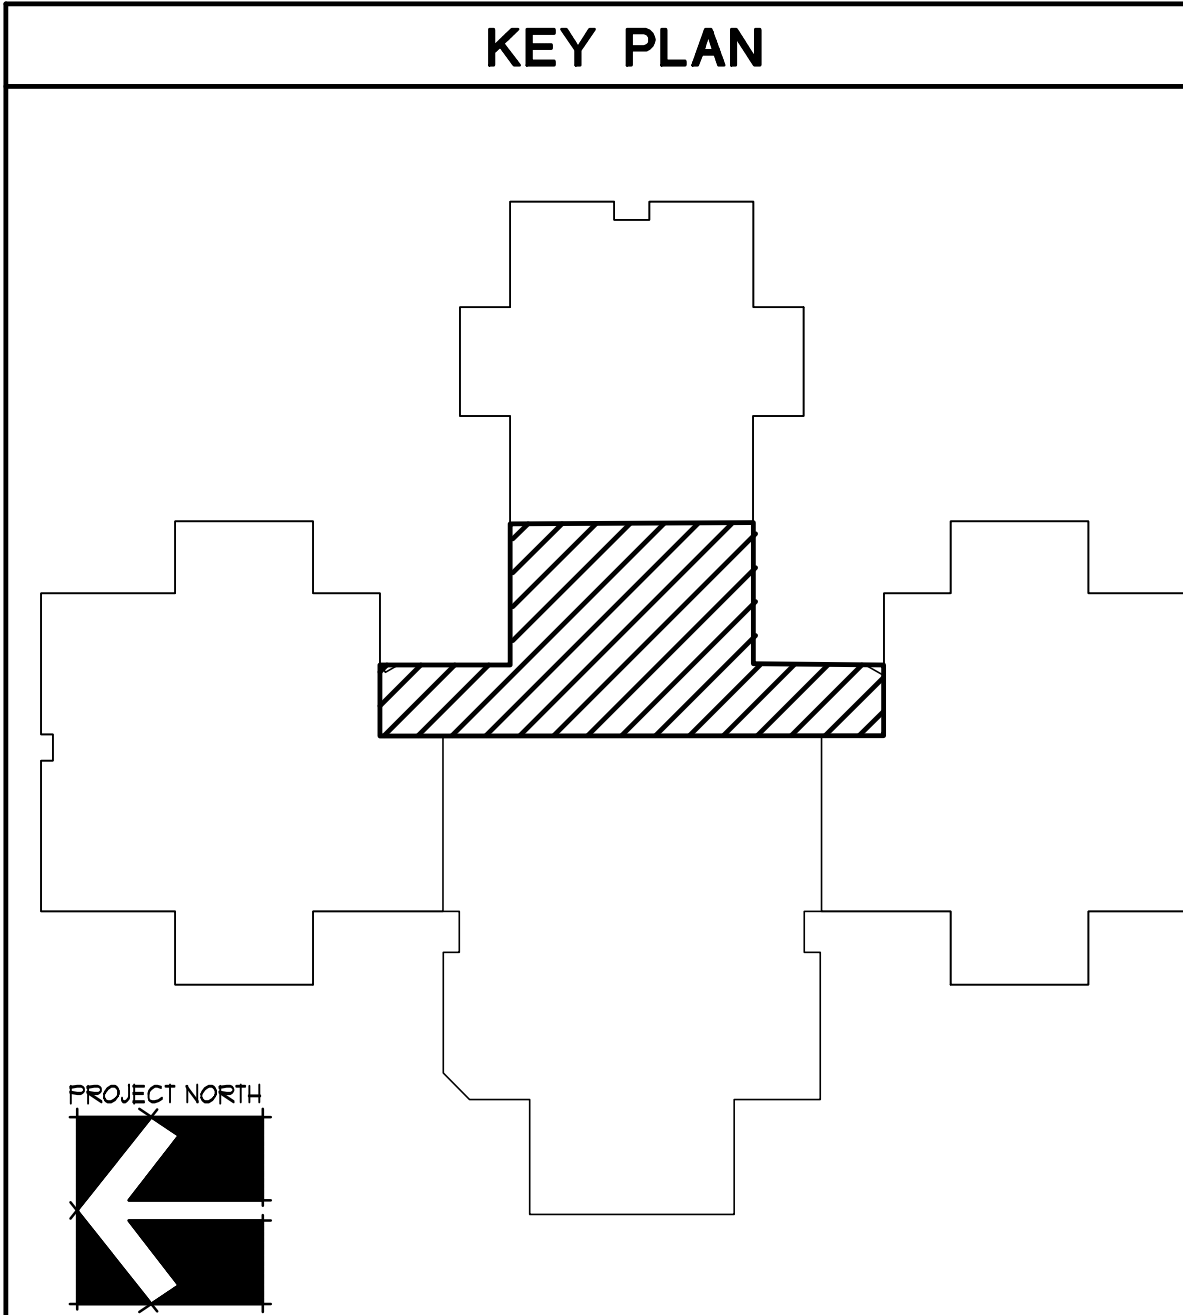
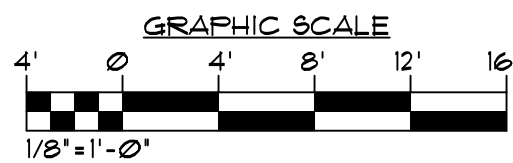


PROJECT NORTH  
ENLARGED NEW PLAN  
SCALE: 1/4"=1'-0"  
(ALTERNATE BID AREA)

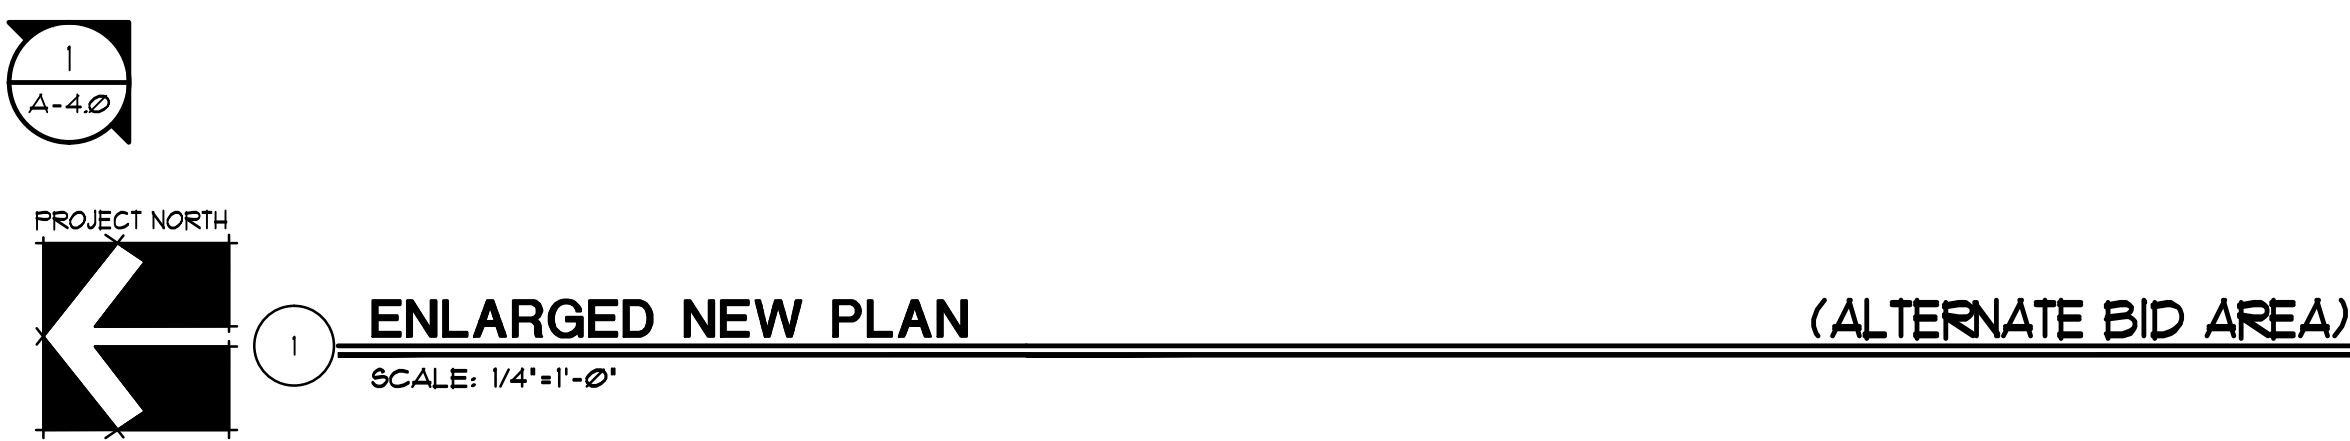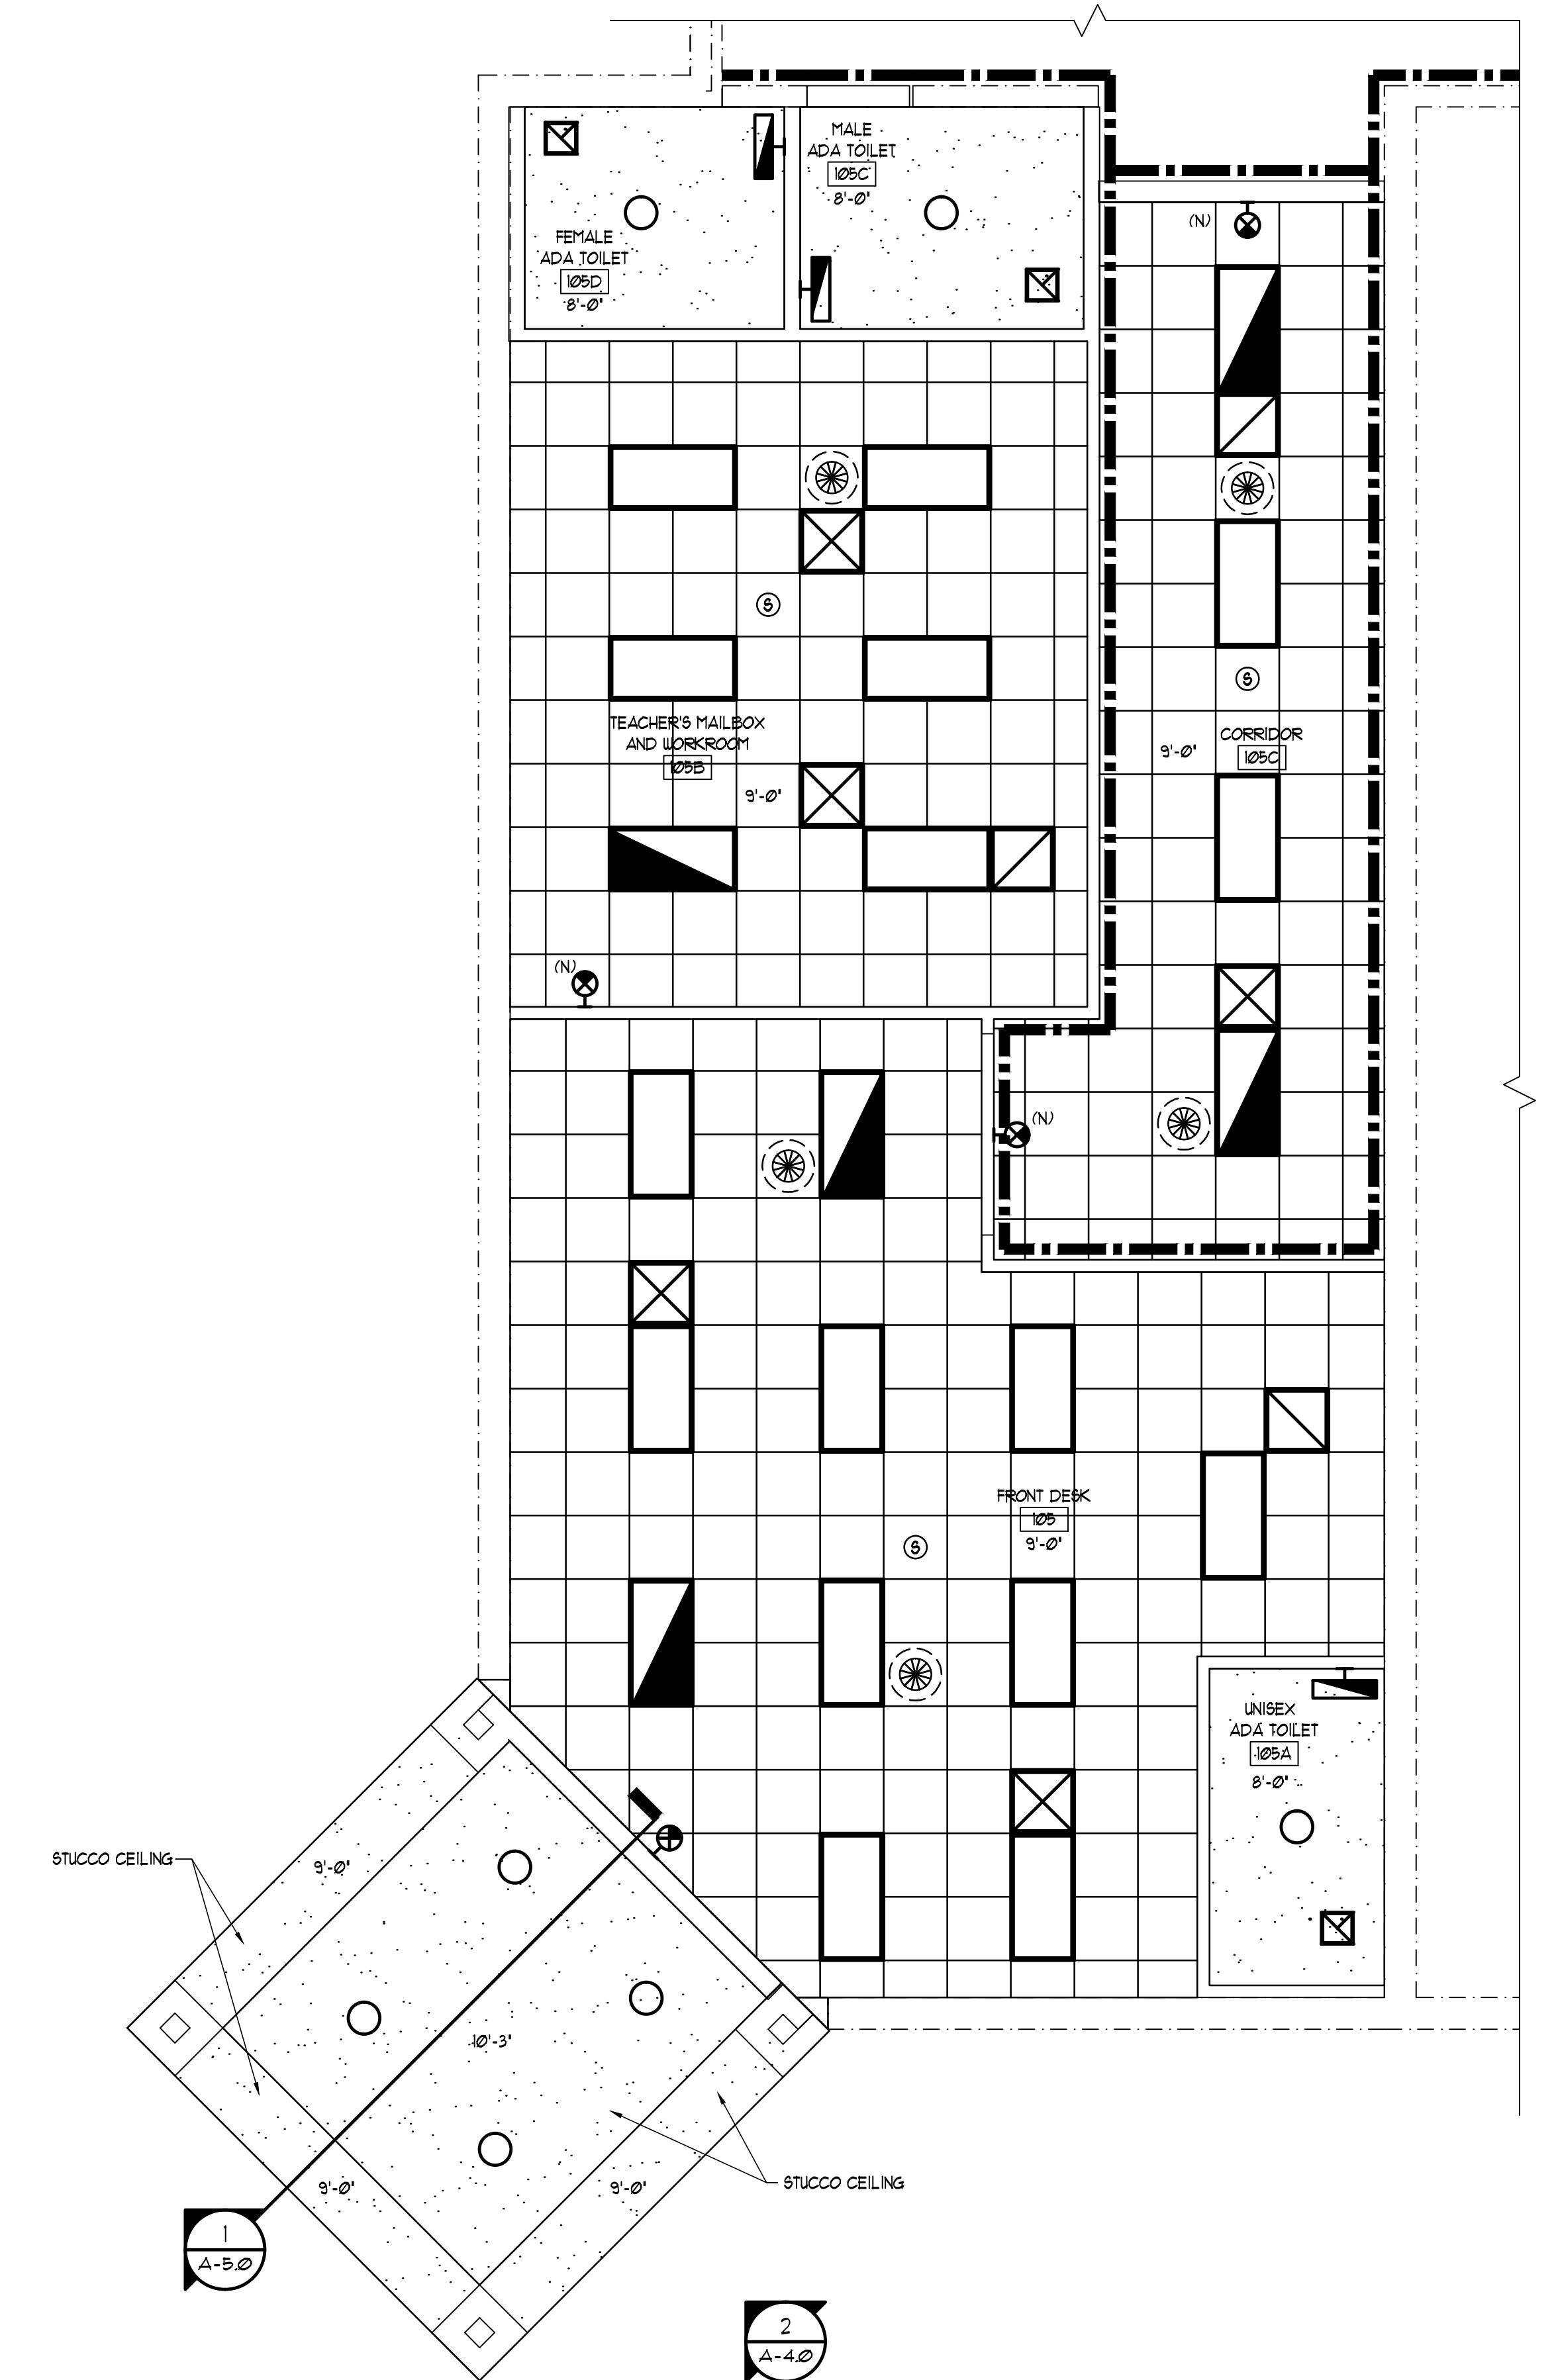



PROJECT NORTH  
  
1 ENLARGED NEW PLAN  
SCALE: 1/8"=1'-0"

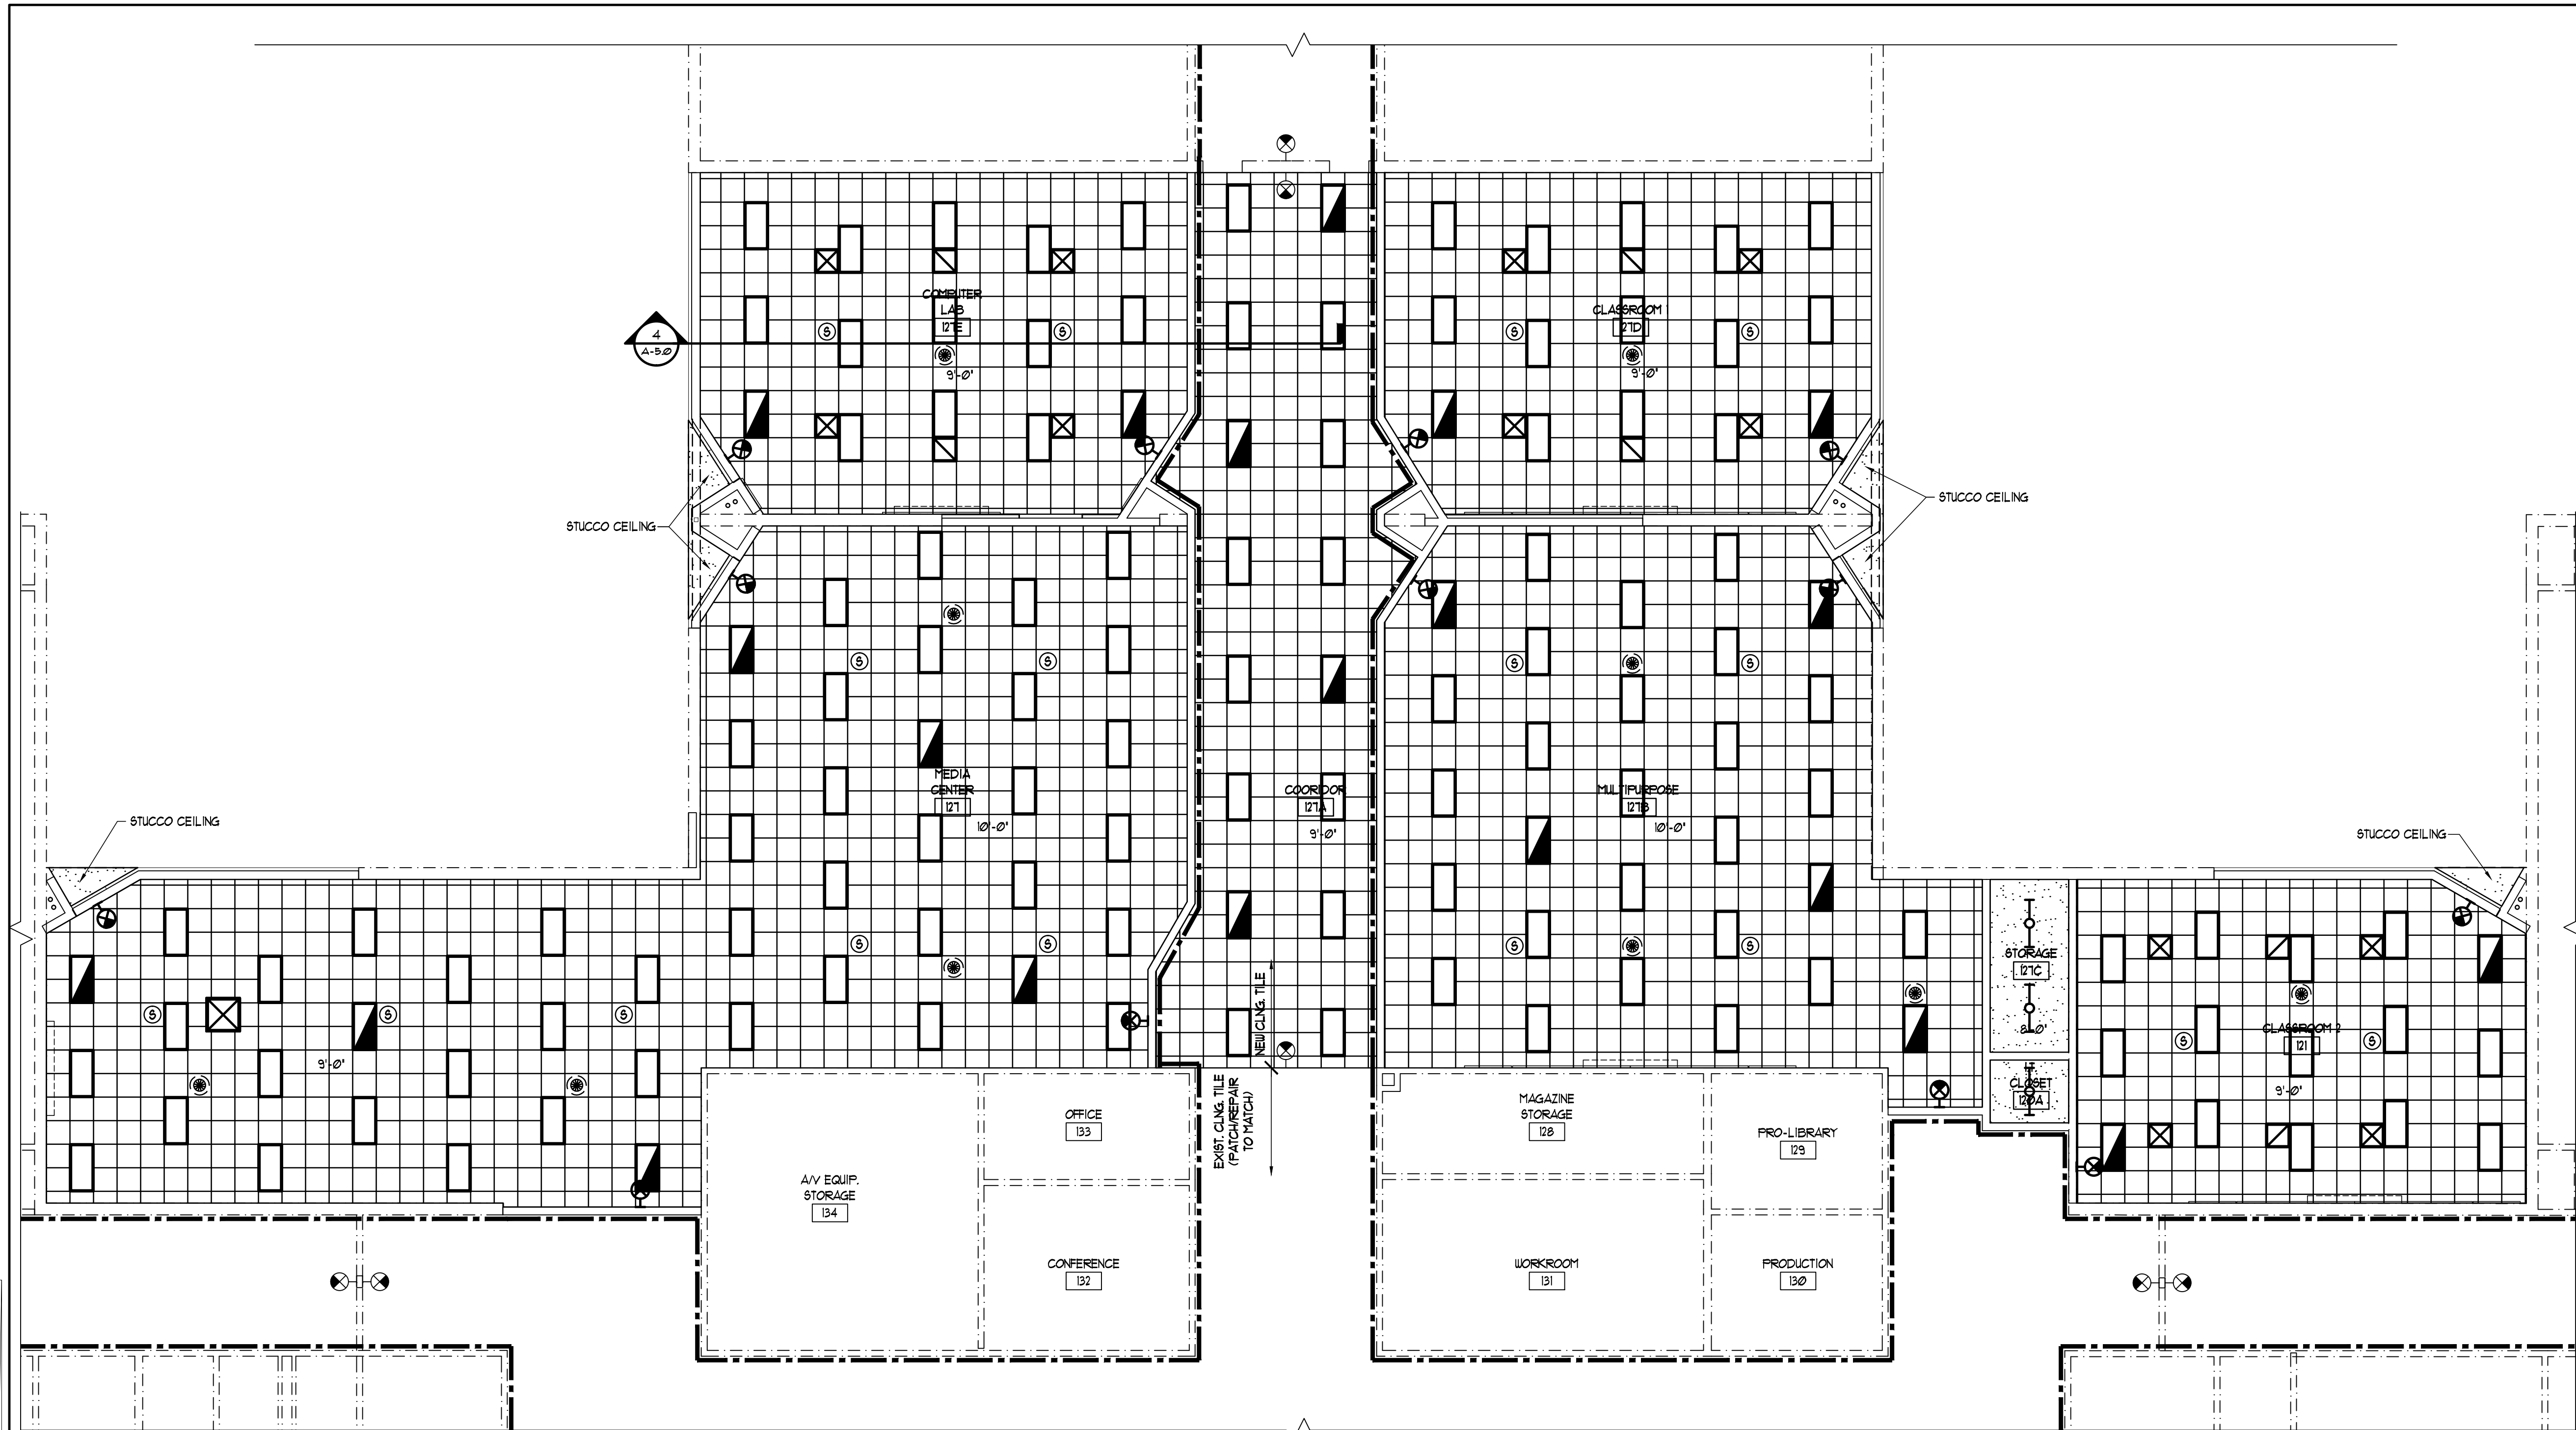

### REFLECTED CEILING PLAN NOTES

- ALL DETAILS AND SECTIONS SHOWN ON THE DRAWINGS ARE INTENDED TO BE TYPICAL AND SHALL BE CONSTRUED TO APPLY TO ANY SIMILAR SITUATION ELSEWHERE ON THE PROJECT EXCEPT WHERE A DIFFERENT DETAIL IS SHOWN, REFER TO FLOOR PLANS, ELEVATIONS, SECTIONS, AND SPEC. BOOK FOR ADDITIONAL DETAIL REFERENCES.
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- REFER TO REFLECTED CEILING PLANS FOR FIRE RATED WALL LOCATIONS.
- EVERY EFFORT MUST BE MADE TO GIVE CEILING A CLEAN AND WELL ORGANIZED APPEARANCE.
- ANY VARIATION IN PLANS MUST BE APPROVED BY ARCHITECT PRIOR TO WORK.

### REFLECTED CEILING LEGEND

- SUPPLY AIR
- RETURN AIR
- EXHAUST FAN
- DIAGONAL SHADING DENOTES EMERGENCY LIGHT FIXTURE
- 2X4 FLUORESCENT RECESSED LIGHT FIXTURE
- BARE FLUORESCENT LIGHT FIXTURE
- WALL MOUNTED LIGHT FIXTURE
- EXIT LIGHT FIXTURE: CEILING MOUNTED / WALL MOUNTED
- WALL MOUNT LIGHT FIXTURE
- 2X2 SUSPENDED ACOUSTICAL CEILING
- 2X4 SUSPENDED ACOUSTICAL CEILING
- GYPSUM BOARD CEILING
- STUCCO CEILING
- 1 HR FIRE RATED WALL/PARTITION
- OCCUPANCY SENSOR
- SMOKE DETECTOR
- HEAT DETECTOR
- SPEAKER
- EXISTING
- NEW

### REVISIONS AND UPDATES


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SUWANNEE COUNTY SCHOOL BOARD  
SUWANNEE PRIMARY SCHOOL  
ADDITIONS AND REMODELING  
1625 WALKER AVE. SW LIVE OAK, FLORIDA  
NEW ENLARGED REFLECTED CEILING PLAN

drawn 02/18/14 CNK checked 02/16/14 JCZ approved JCZ

AA-C00568  
JOHN C. ZWICK, R.A.  
FL. REG. AR0009521  
Job no. 20031  
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800 FLORIDA AVENUE SUITE 202 COCOA, FLORIDA 32922 TELEPHONE (321) 631-8039



ROOF PLAN NOTES

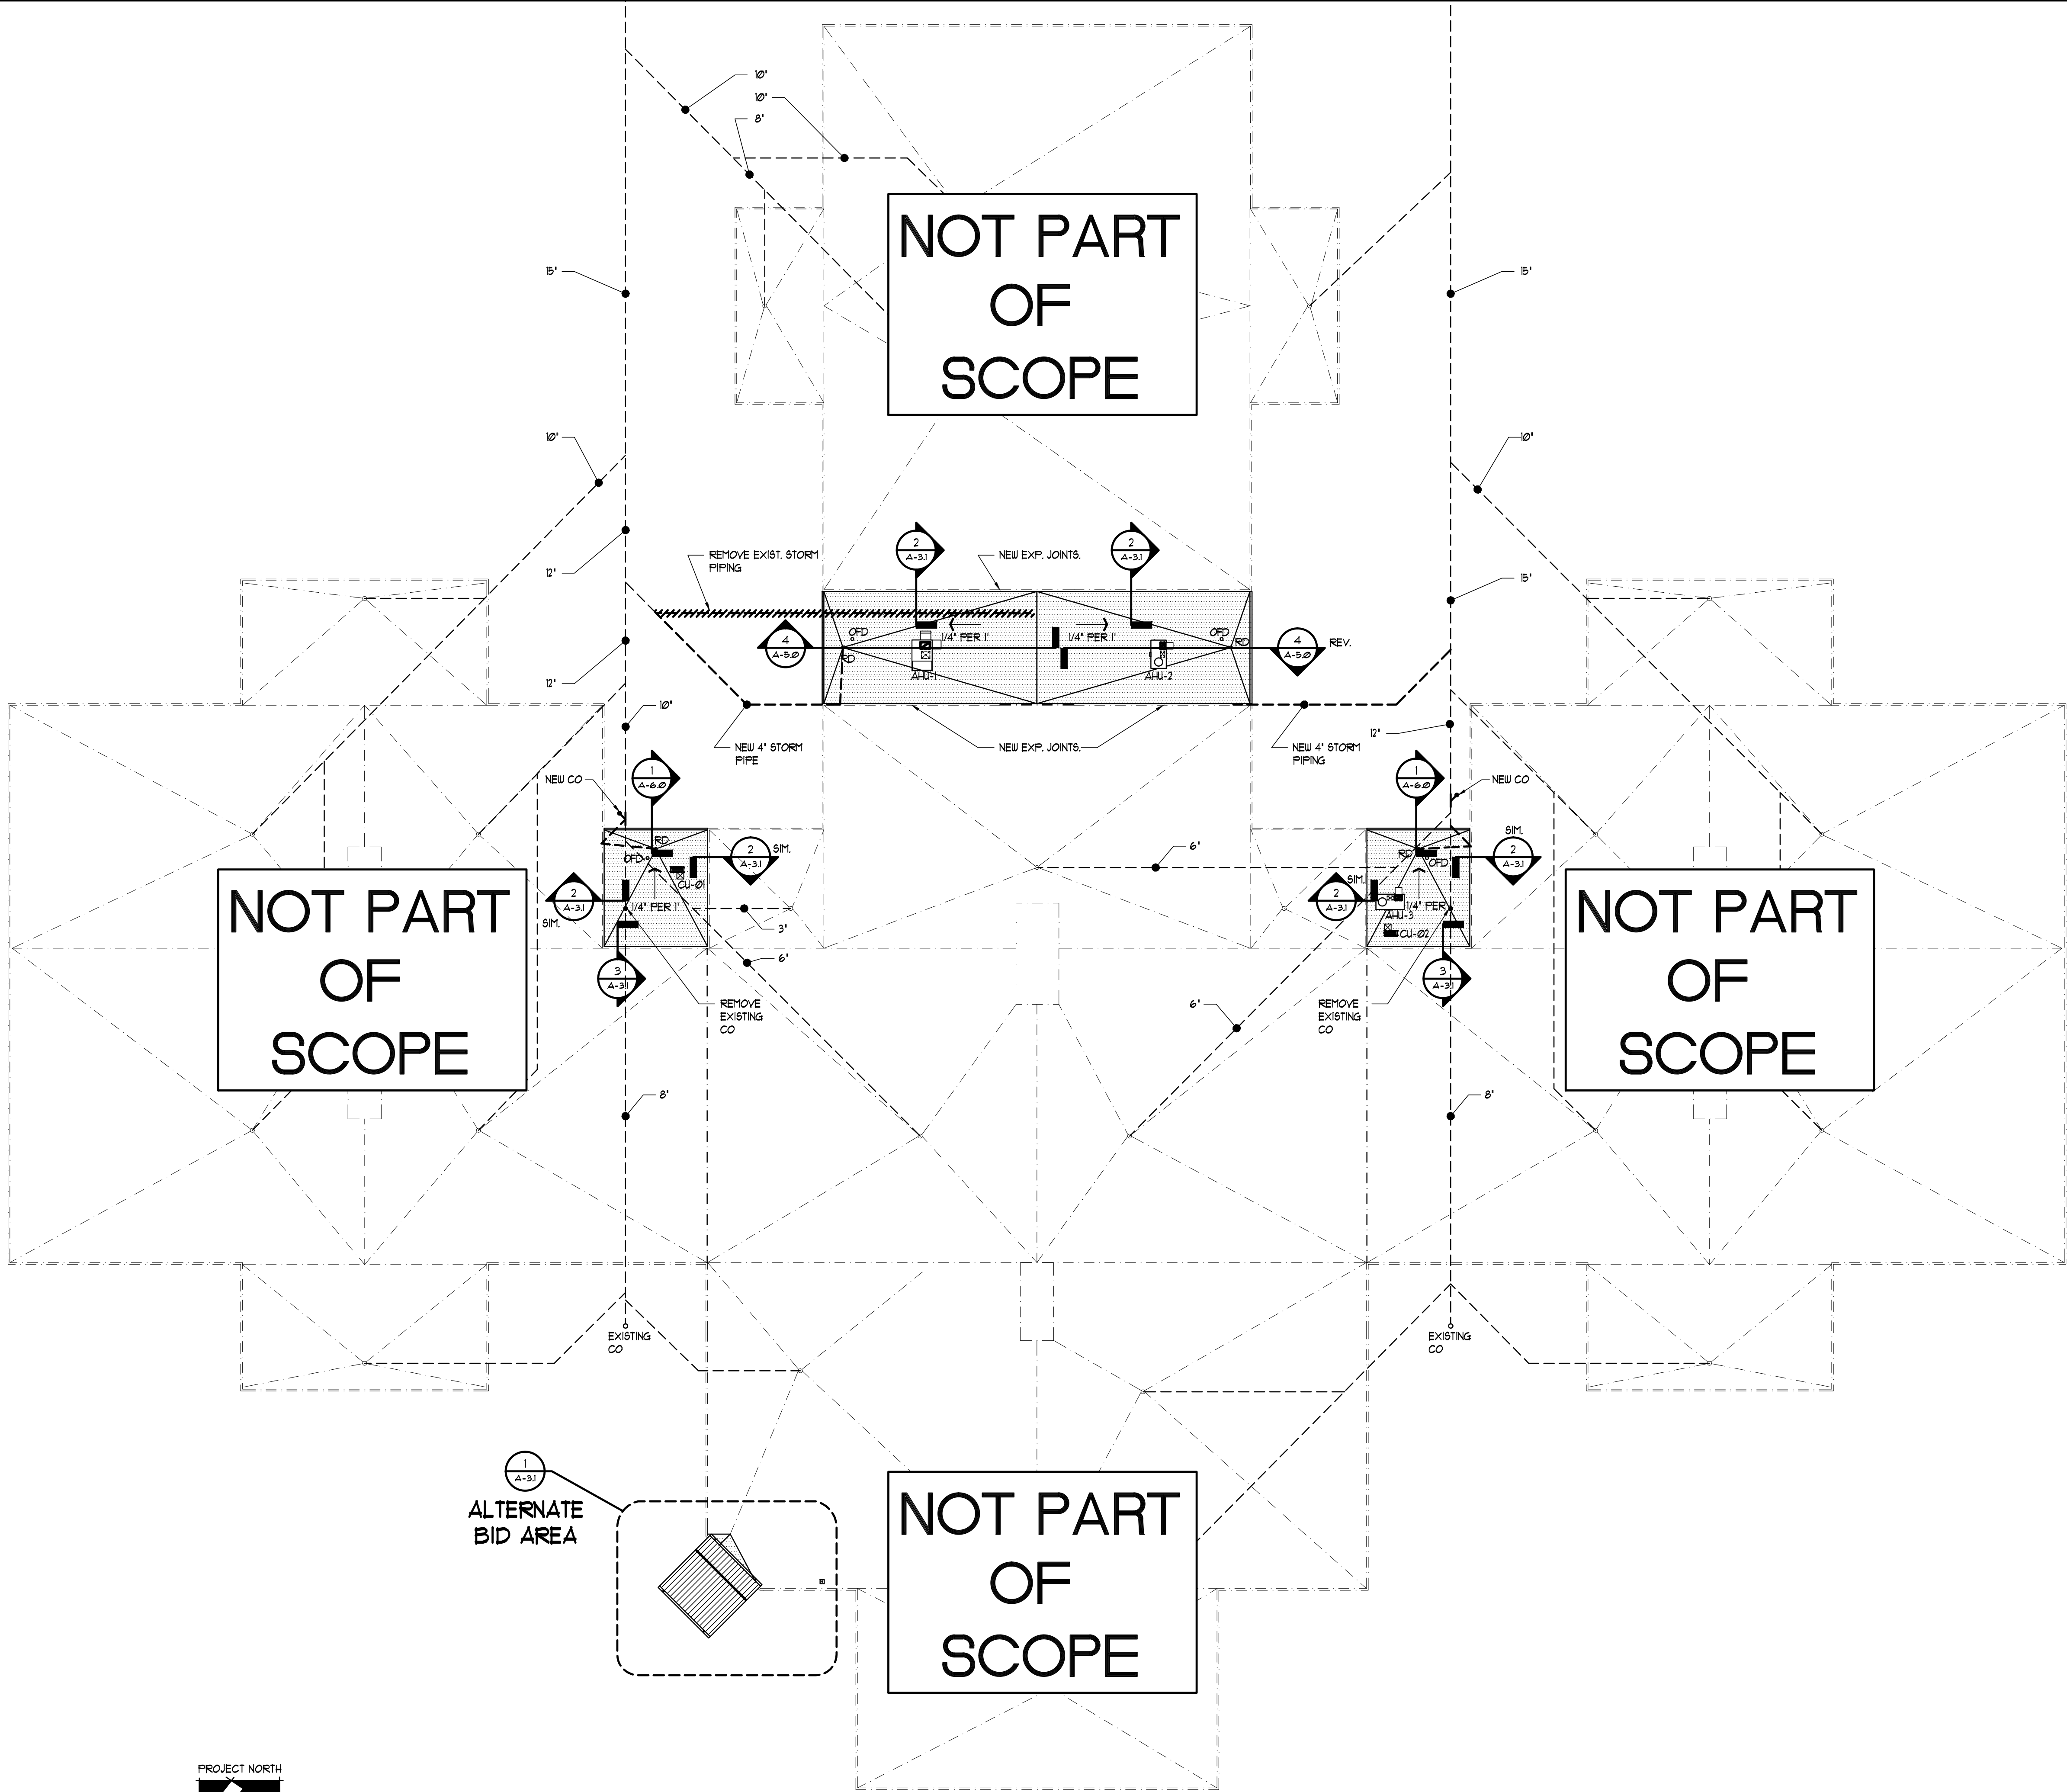1. REFER TO DIVISION 1 THERMAL & MOISTURE IN THE SPECIFICATIONS FOR ROOF FINISHES ETC.
2. REFER TO THE ROOF DETAIL SHEETS FOR ADDITIONAL INFORMATION.
3. ALL DETAILS AND SECTIONS SHOWN ON THE DRAWINGS ARE INTENDED TO BE TYPICAL AND SHALL BE CONSIDERED TO APPLY TO ANY SIMILAR SITUATION ELSEWHERE ON THE PROJECT, EXCEPT WHERE A DIFFERENT DETAIL IS SHOWN.
4. REFER TO PLUMBING, MECHANICAL, AND ELECTRICAL DRAWINGS AND SPECIFICATIONS FOR LOCATIONS OF VENTS, EQUIP., OR OTHER ROOF PENETRATIONS.
5. THE GENERAL CONTRACTOR AND ROOFING SUB-CONTRACTOR MUST HAVE A COMPLETE UNDERSTANDING OF ALL APPLICABLE CODES, FM - LOSS PREVENTION DATA, 1995 FMRC APPROVAL GUIDE AND MANUFACTURERS RECOMMENDATIONS.
6. PAINT ALL FLASHING, COPING, ETC. TO MATCH ADJACENT WALL COLOR.
7. THE 'ON SITE' ROOFING FOREMAN MUST ATTEND THE PRE-ROOFING CONFERENCE.
8. ROOF TOP EQUIPMENT REQUIRING SERVICE SHALL NOT BE LOCATED WITHIN 10'-0" OF EDGE OF ROOF.
9. CONTRACTOR TO PROVIDE INVENTORY OF RECOMMENDED ROOF, SOFFIT, PARAPET AND OTHER EXTERIOR IMPROVEMENTS NEEDED FOR 'LIKE NEW' CONDITION OF BUILDING SHELL. EXTERIOR IMPROVEMENTS SHALL BE PROVIDED AS A SEPARATE LINE ITEM(S) FOR ARCHITECT AND TENANT REVIEW.
10. ALL LARGE MECHANICAL EQUIPMENT TO BE MOUNTED ON MECHANICAL CURBS, SMALLER EQUIPMENT TO BE MOUNTED ON STANDS. SEE MECHANICAL DRAWINGS FOR ADDITIONAL INFORMATION.

ROOF LEGEND

RD	ROOF DRAIN
RS	ROOF SCUPPER
→	SLOPE OF ROOF
OFD	OVERFLOW DRAIN
VTR	VENT THRU ROOF
---	EXISTING ROOF
----	EXISTING STORM DRAIN PIPING TO BE REMOVED
----	EXISTING STORM DRAIN PIPING TO REMAIN
----	NEW STORM DRAIN PIPING
----	NEW ROOF
----	NEW PATCHED ROOFING TO MATCH EXISTING OR APPROVED SUBSTITUTION PROVIDED FOR ARCHITECT APPROVAL.
----	NEW METAL STANDING SEAM ROOF

REVISIONS AND UPDATES

02/14/14		CONSTRUCTION DOCUMENTS FOR BID/PERMIT



SUWANNEE COUNTY SCHOOL BOARD  
SUWANNEE PRIMARY SCHOOL  
ADDITIONS AND REMODELING  
1625 WALKER AVE., SW  
LIVE OAK, FLORIDA  
NEW ROOF PLAN AND DRAINAGE

drawn 02/18/14 CNK checked 02/16/14 JCZ approved JCZ


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800 FLORIDA AVENUE SUITE 202 COCOA, FLORIDA 32922  
TELEPHONE (321) 631-8039  
JOB NO. 20031  
A-3.0

PROJECT NORTH  
NEW ROOF PLAN  
SCALE: 1" = 20'




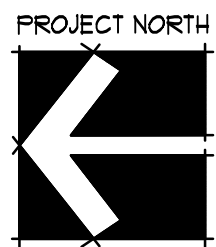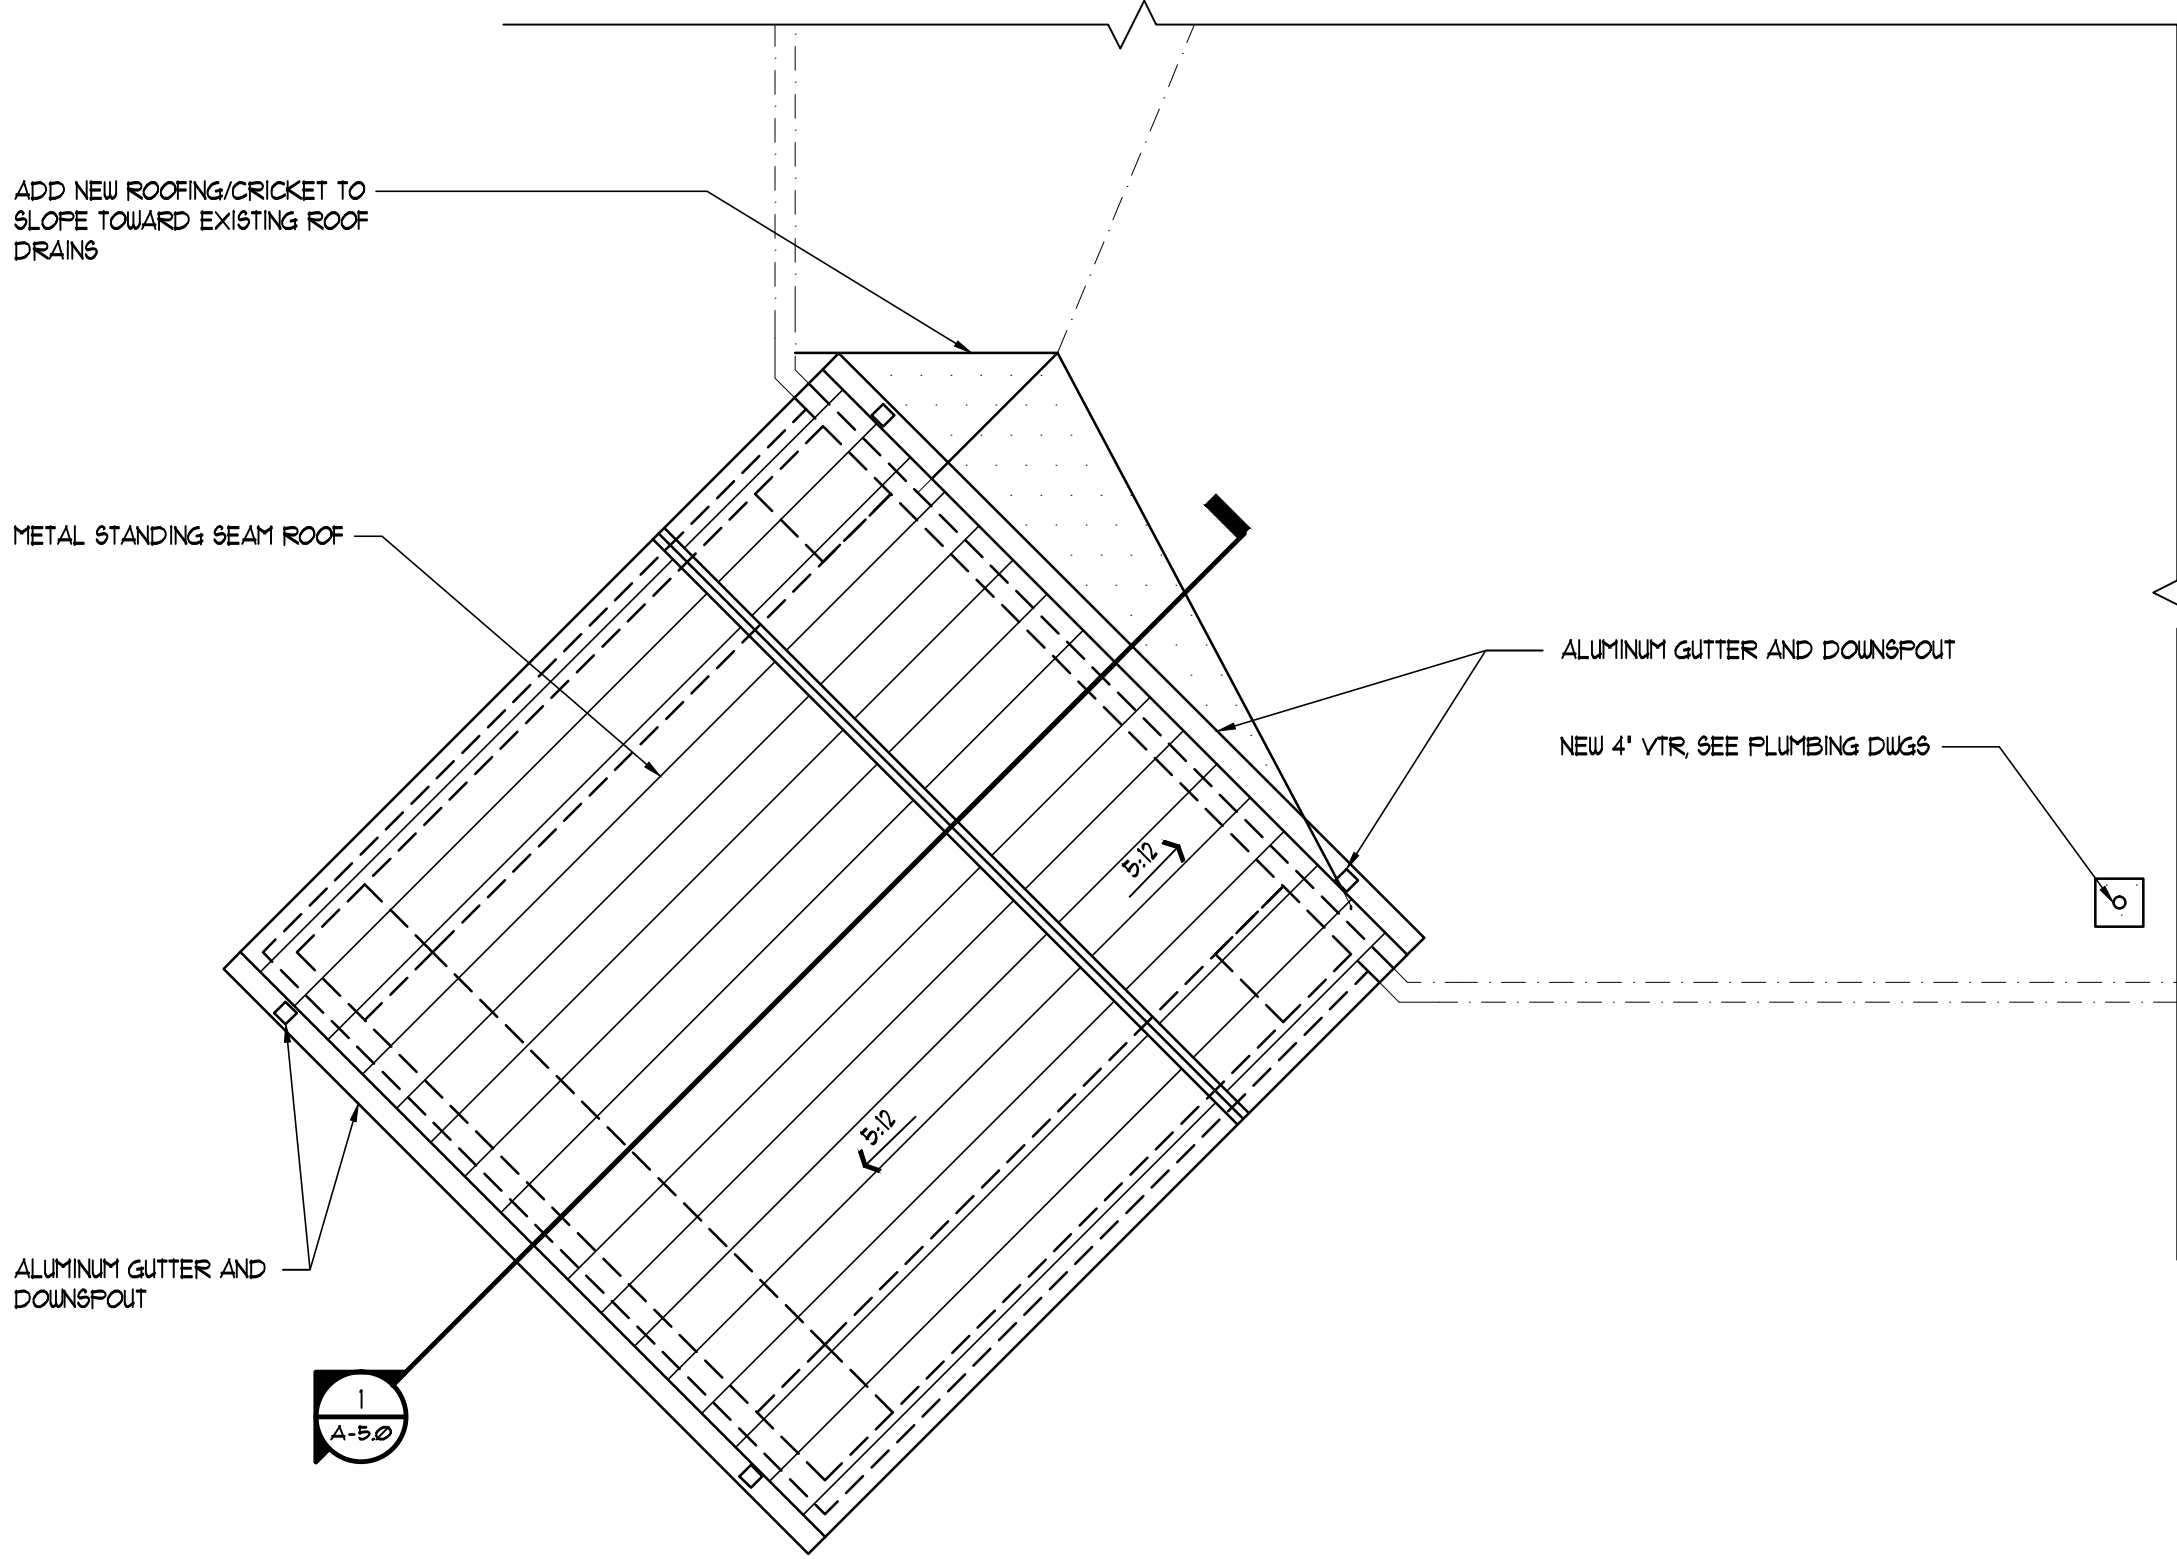

**1 ENLARGED ROOF PLAN (ALTERNATE BID AREA)**  
SCALE: 1/4" = 1'-0"

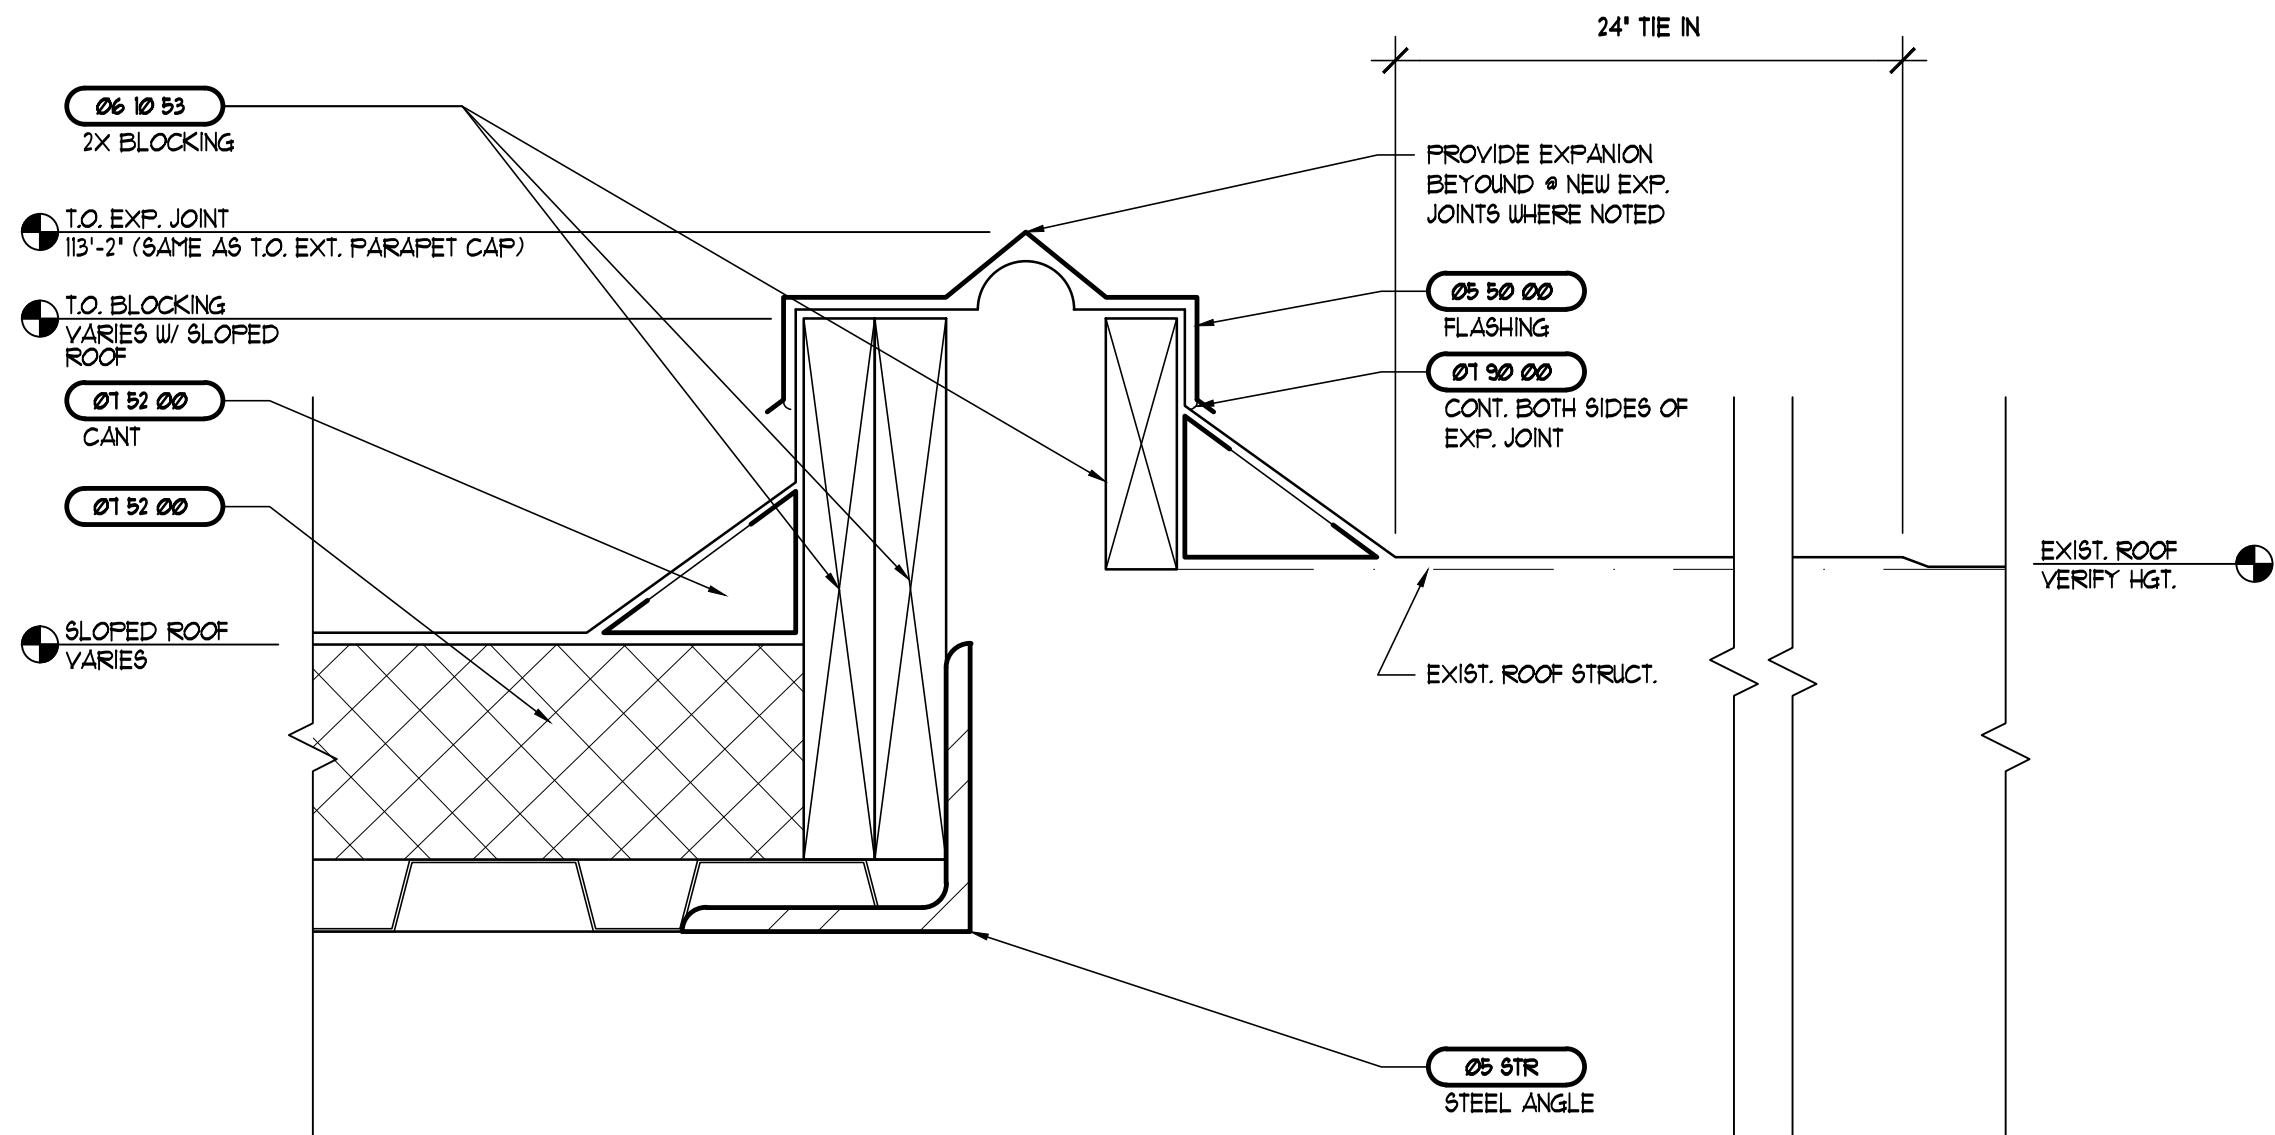

**2 TYP. CURB DETAIL • EXP. JOINT**  
SCALE: 3/4" = 1'-0"

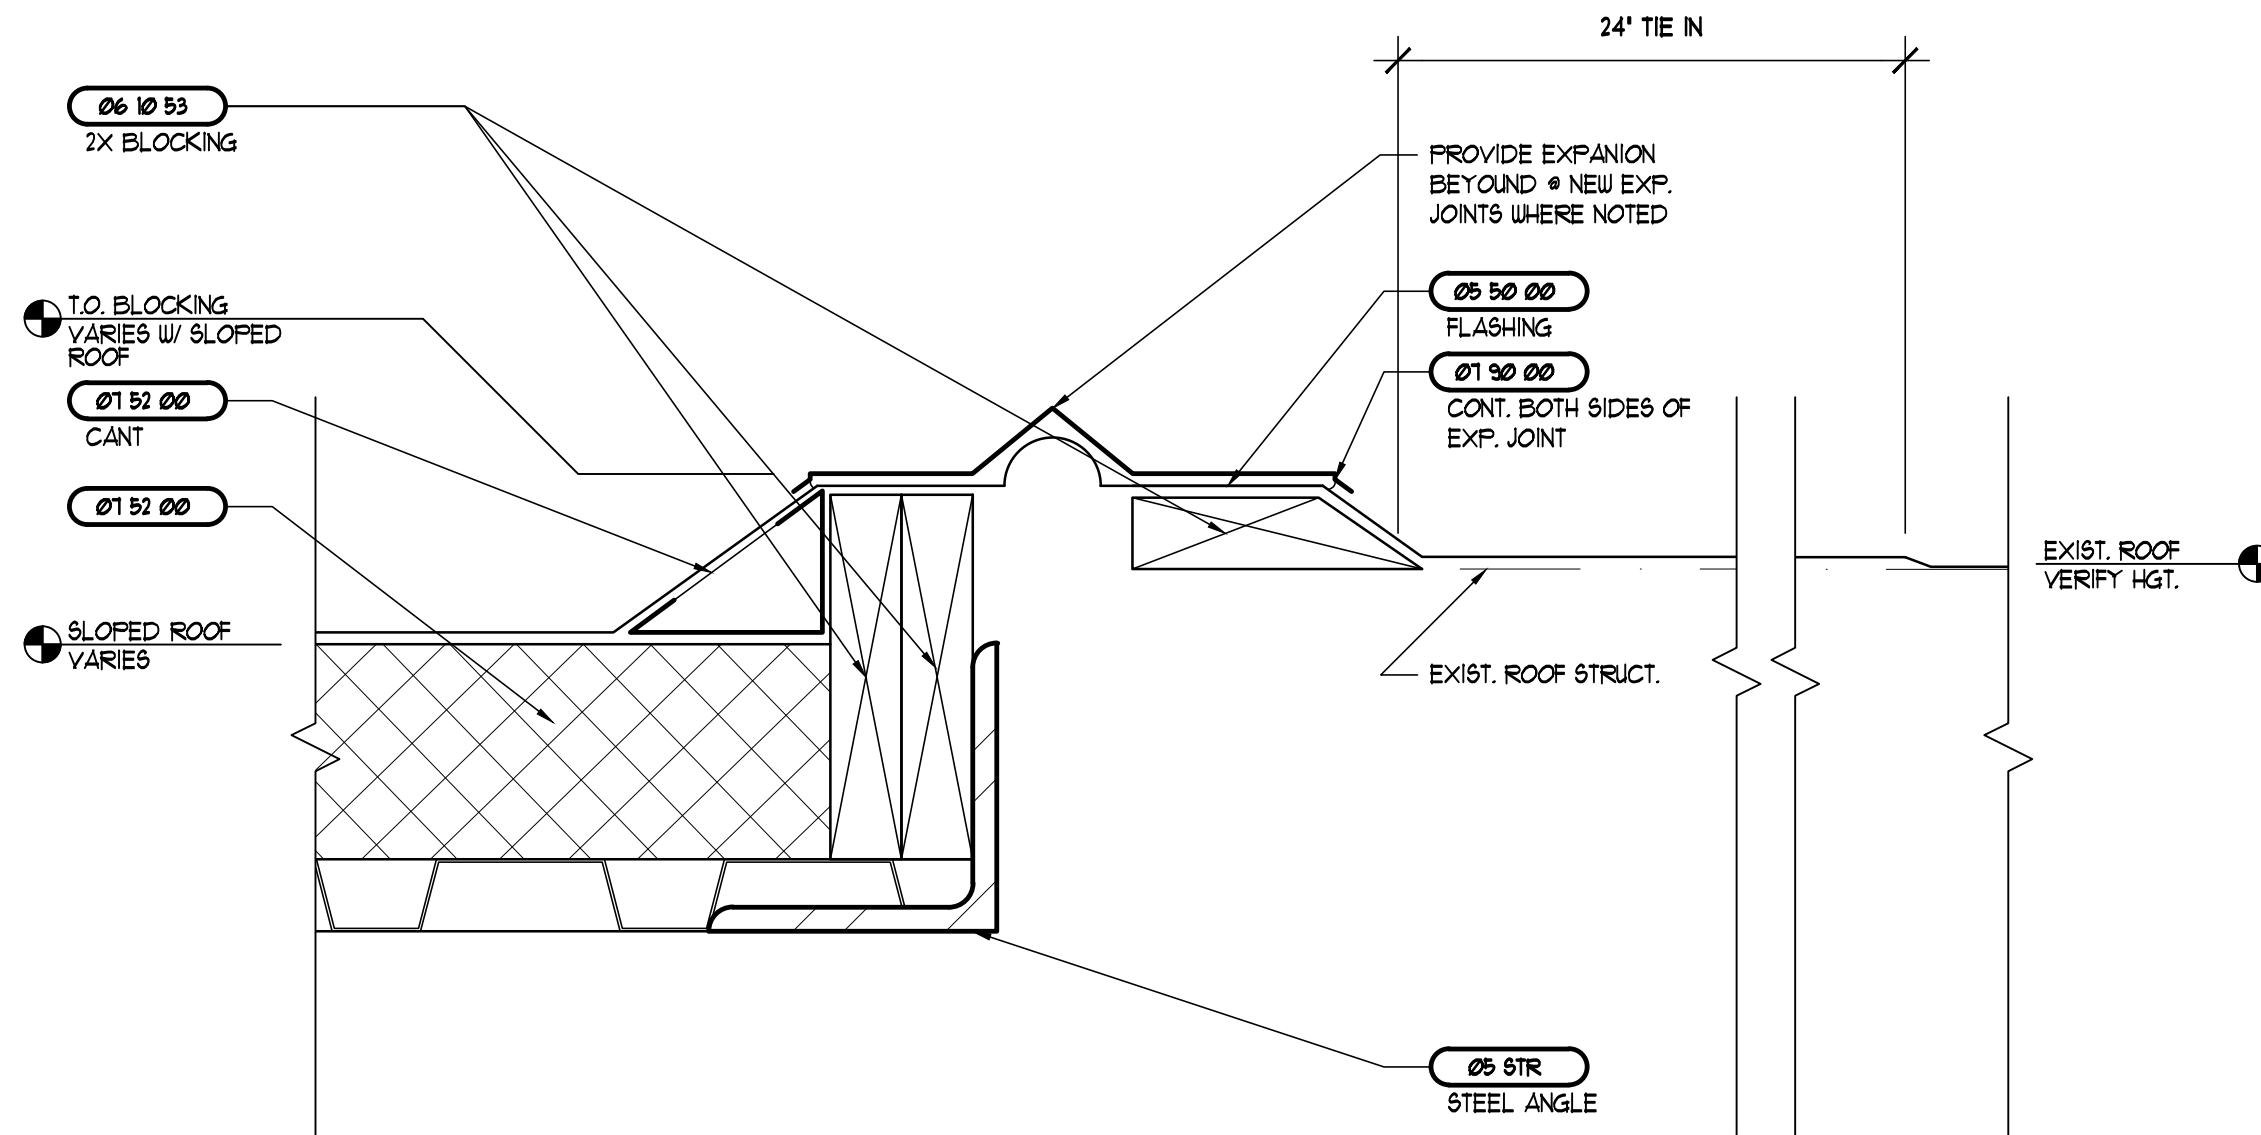

**3 TYP. CURB DETAIL**  
SCALE: 3/4" = 1'-0"

**MATERIALS LIST**

03 STR 03 40 16	SEE STRUCTURAL PRE-CAST CONCRETE SPLASH BLOCKS
04 STR 04 05 23 04 21 13	SEE STRUCTURAL MASONRY ACCESSORIES BRICK MASONRY AND ACCESSORIES
05 STR 05 40 00 05 50 00	SEE STRUCTURAL SPECIFICATIONS COLD-FORMED METAL FRAMING METAL FABRICATIONS
06 10 53 06 11 00 06 40 23 06 65 00	ROUGH CARPENTRY (BLOCKING, ETC.) ROUGH HARDWARE ARCHITECTURAL LAMINATE CASEWORK RECYCLED PLASTIC LUMBER
07 11 13 07 20 60 07 21 00 07 21 13 07 24 00 07 41 13 07 52 00 07 62 00 07 64 10 07 90 00	BITUMINOUS DAMPROOFING MASONRY FOAM FILL INSULATION THERMAL BATT INSULATION SEMI-RIGID WALL INSULATION (FOIL FACED) SUBSTRATE SHEATHING PREFORMED METAL ROOFING, SIDING, SOFFIT AND TRIM SBS MODIFIED BITUMINOUS ROOF SYSTEM PREFABRICATED PARAPET TOP AND COLLECTOR BOX FIRE RATED PENETRATIONS AND JOINTS JOINT SEALERS
08 10 00 08 11 00 08 20 00 08 21 00 08 40 31 08 52 10 08 71 00 08 80 00	HOLLOW METAL FRAMES HOLLOW METAL DOORS WOOD DOORS HARDBOARD FACED DOORS ALUMINUM ENTRANCE AND STOREFRONT SYSTEM ALUMINUM WINDOWS FINISH HARDWARE GLASS AND GLAZING
09 12 00 09 12 50 09 24 00 09 29 00 09 29 10 09 30 00 09 31 00 09 40 00 09 51 13 09 54 10 09 65 00 09 65 10 09 68 18 09 91 00	CEILING SUSPENSION SYSTEM INTERIOR NON-BEARING METAL FRAMING LATH AND STUCCO GYPSUM DRYWALL INTERIOR TILE BACKERBOARD CERAMIC TILE CULTURED MARBLE SOLID SURFACE COUNTERTOP ACOUSTICAL CEILING PANELS ACOUSTICAL INSULATION RESILIENT FLOORING VINYL BASE VINYL CUSHION CARPET TILES PAINTING
10 11 00 10 11 13 10 14 00 10 26 13 10 28 00 10 44 00 10 61 00	MARKERBOARDS TACKABLE WALL PANELS IDENTIFYING DEVICES HIGH IMPACT WALL COVERING TOILET AND BATH ACCESSORIES FIRE EXTINGUISHERS AND CABINETS SHELVING
11 52 13	MANUAL PROJECTION SCREENS
22 PLUMB	SEE PLUMBING SPECIFICATIONS
23 MECH	SEE MECHANICAL SPECIFICATIONS
26 ELECT	SEE ELECTRICAL SPECIFICATIONS

**ROOF PLAN NOTES**

- REFER TO DIVISION 1 THERMAL & MOISTURE IN THE SPECIFICATIONS FOR ROOF FINISHES ETC.
- REFER TO THE ROOF DETAIL SHEETS FOR ADDITIONAL INFORMATION.
- ALL DETAILS AND SECTIONS SHOWN ON THE DRAWINGS ARE INTENDED TO BE TYPICAL AND SHALL BE CONSIDERED TO APPLY TO ANY SIMILAR SITUATION ELSEWHERE ON THE PROJECT, EXCEPT WHERE A DIFFERENT DETAIL IS SHOWN.
- REFER TO PLUMBING, MECHANICAL, AND ELECTRICAL DRAWINGS AND SPECIFICATIONS FOR LOCATIONS OF VENTS, EQUIPT, OR OTHER ROOF PENETRATIONS.
- THE GENERAL CONTRACTOR AND ROOFING SUB-CONTRACTOR MUST HAVE A COMPLETE UNDERSTANDING OF ALL APPLICABLE CODES, FM - LOSS PREVENTION DATA, 1995 FMRC APPROVAL GUIDE AND MANUFACTURERS RECOMMENDATIONS.
- PAINT ALL FLASHING, COPING, ETC. TO MATCH ADJACENT WALL COLOR.
- THE 'ON SITE' ROOFING FOREMAN MUST ATTEND THE PRE-ROOFING CONFERENCE.
- ROOF TOP EQUIPMENT REQUIRING SERVICE SHALL NOT BE LOCATED WITHIN 10'-0" OF EDGE OF ROOF.
- CONTRACTOR TO PROVIDE INVENTORY OF RECOMMENDED ROOF, SOFFIT, PARAPET AND OTHER EXTERIOR IMPROVEMENTS NEEDED FOR 'LIKE NEW' CONDITION OF BUILDING SHELL. EXTERIOR IMPROVEMENTS SHALL BE PROVIDED AS A SEPARATE LINE ITEM(S) FOR ARCHITECT AND TENANT REVIEW.
- ALL LARGE MECHANICAL EQUIPMENT TO BE MOUNTED ON MECHANICAL CURBS, SMALLER EQUIPMENT TO BE MOUNTED ON STANDS. SEE MECHANICAL DRAWINGS FOR ADDITIONAL INFORMATION.

**ROOF LEGEND**


RD	ROOF DRAIN
RS	ROOF SCUPPER
→	SLOPE OF ROOF
OFD	OVERFLOW DRAIN
VTR	VENT THRU ROOF
---	EXISTING ROOF
////	EXISTING STORM DRAIN PIPING TO BE REMOVED
----	EXISTING STORM DRAIN PIPING TO REMAIN
----	NEW STORM DRAIN PIPING
----	NEW ROOF
[Pattern]	NEW PATCHED ROOFING TO MATCH EXISTING OR APPROVED SUBSTITUTION PROVIDED FOR ARCHITECT APPROVAL.
[Pattern]	NEW METAL STANDING SEAM ROOF

**REVISIONS AND UPDATES**

02/14/14		CONSTRUCTION DOCUMENTS FOR BID/PERMIT

SUWANNEE COUNTY SCHOOL BOARD  
SUWANNEE PRIMARY SCHOOL  
ADDITIONS AND REMODELING  
1625 WALKER AVE. SW LIVE OAK, FLORIDA  
ENLARGED ROOF PLAN AND DETAILS


drawn 02/18/14 CNK checked 02/16/14 JCZ approved JCZ

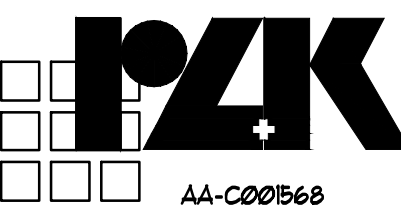

JOHN C. ZWICK, R.A.  
FL. REG. AR0009521


Job no. 20031  
**A-3.1**

**ARCHITECTS RZK, INC.**  
800 FLORIDA AVENUE SUITE 202 COCOA, FLORIDA 32922 TELEPHONE (321) 631-8039

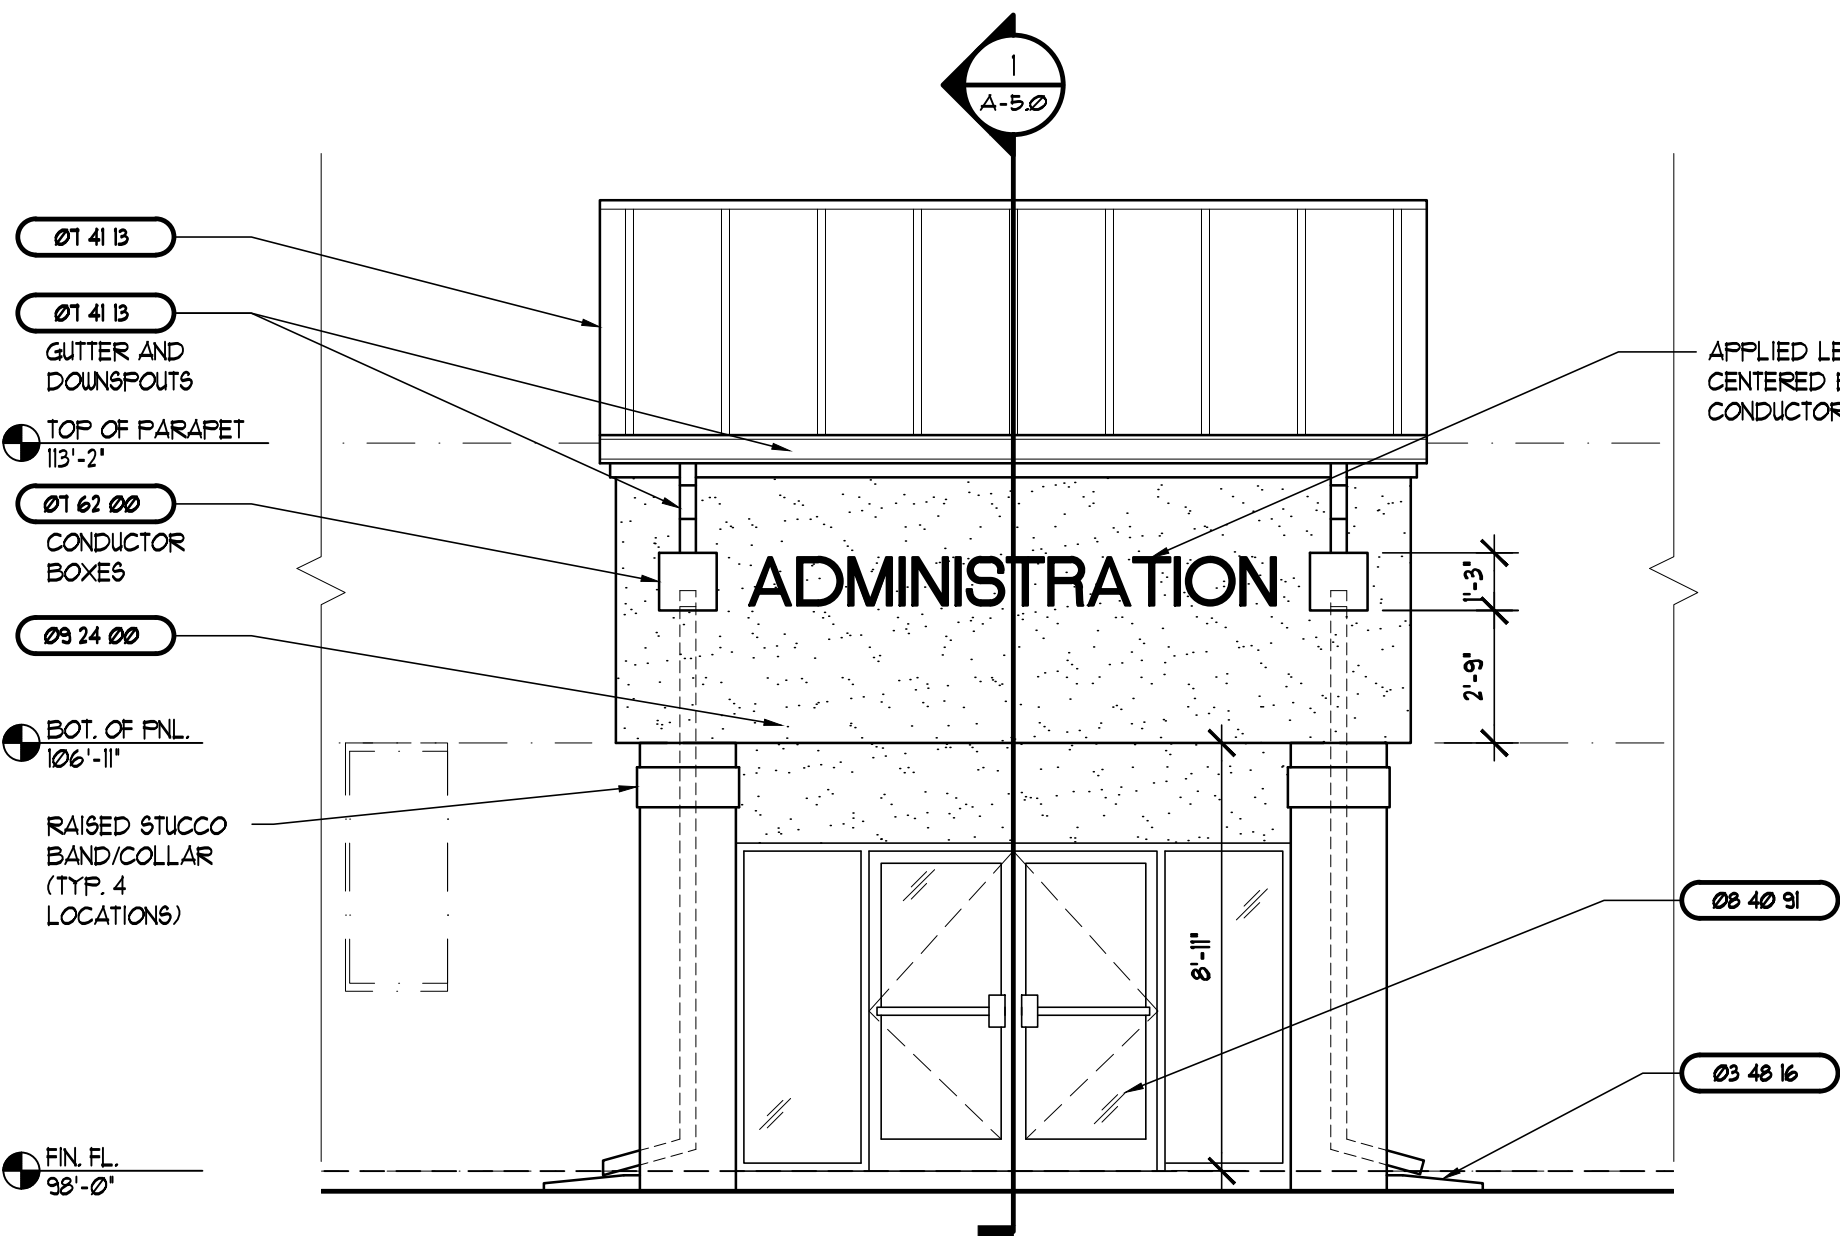


1 NEW ENTRY FRONT ELEVATION

SCALE: 1/4" = 1'-0"

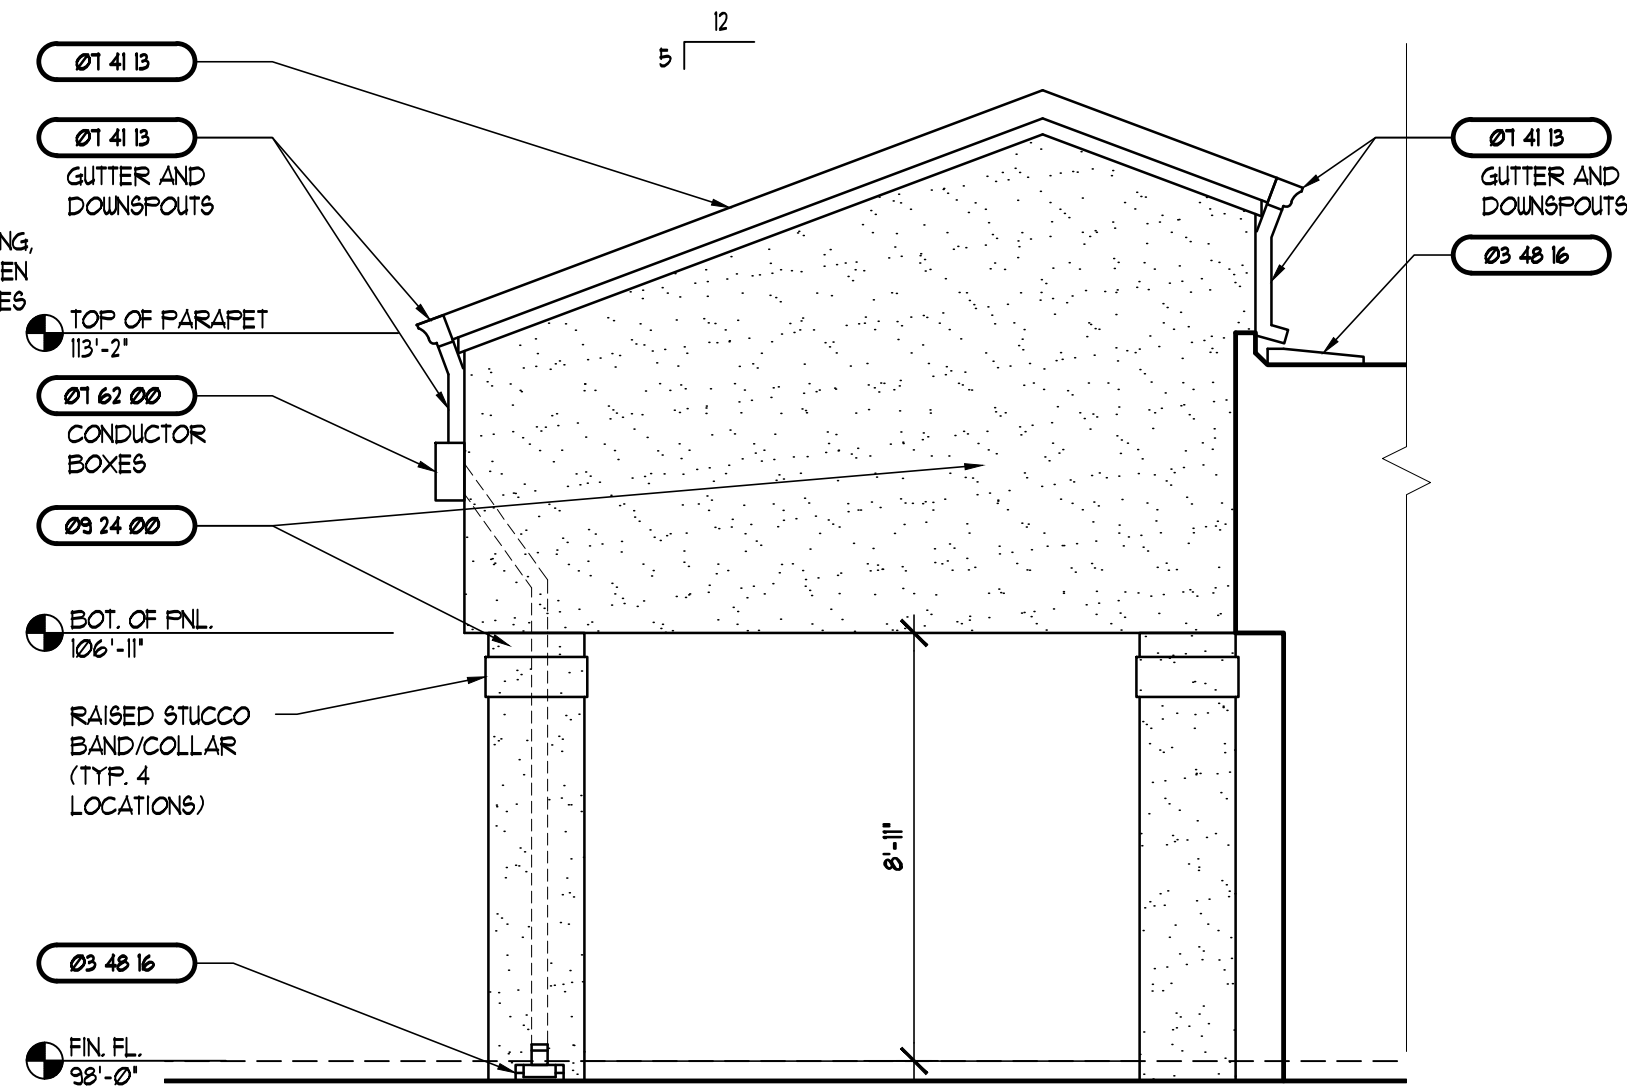


2 NEW ENTRY SIDE ELEVATION

SCALE: 1/4" = 1'-0"

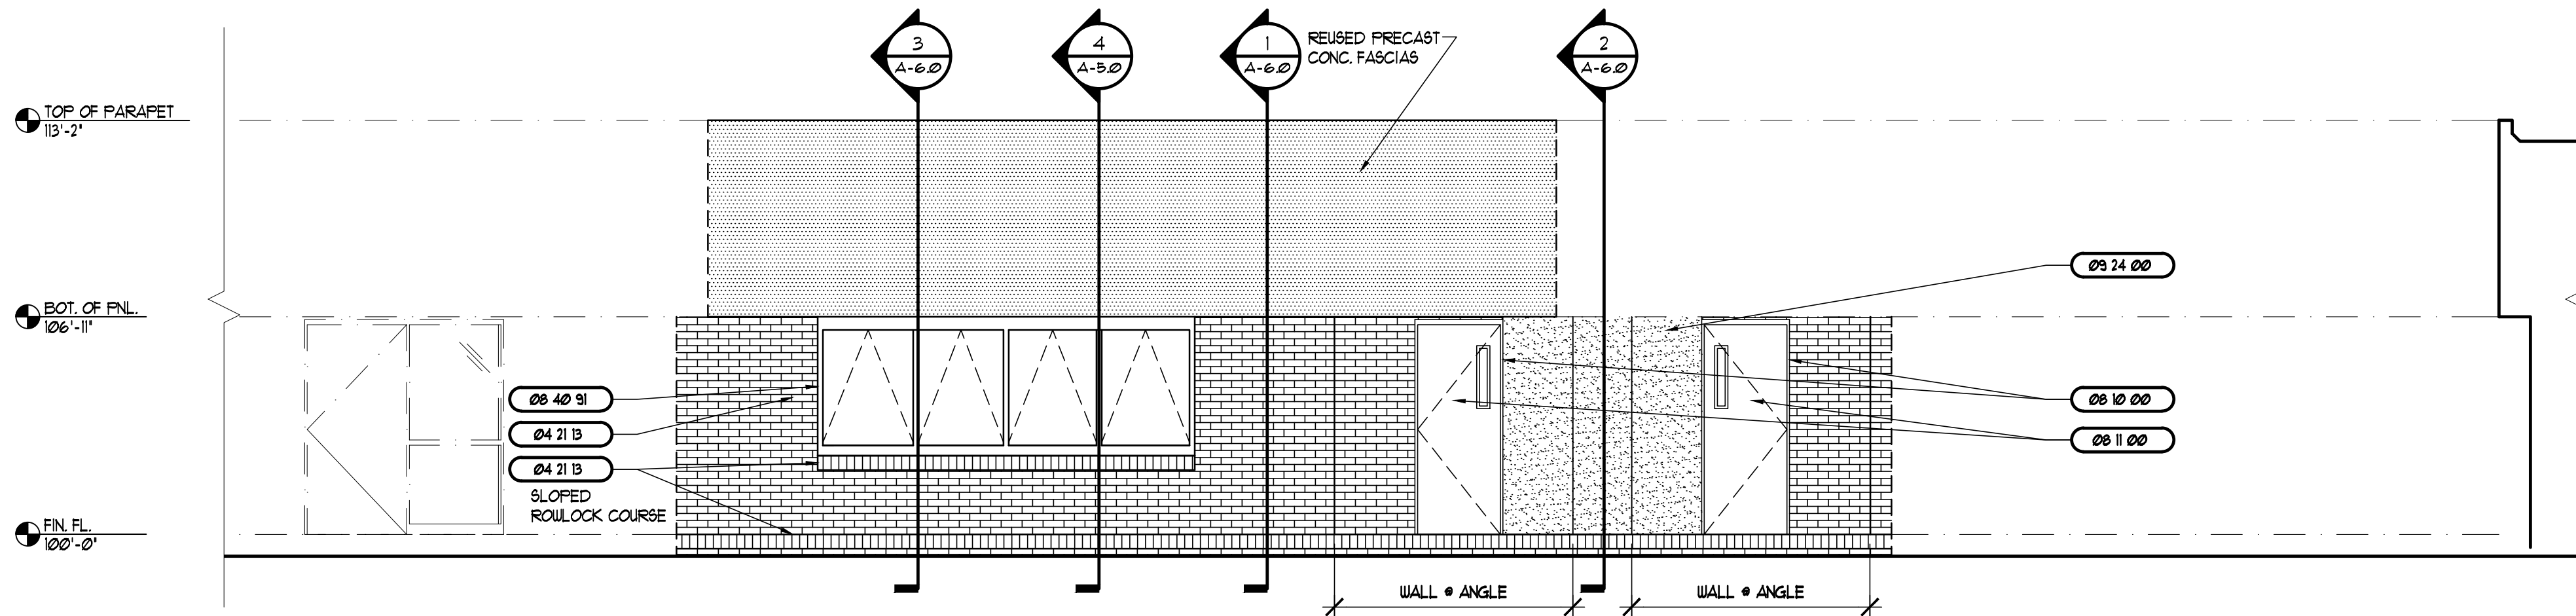

3 NEW CLASSROOM ELEVATION

SCALE: 1/4" = 1'-0"

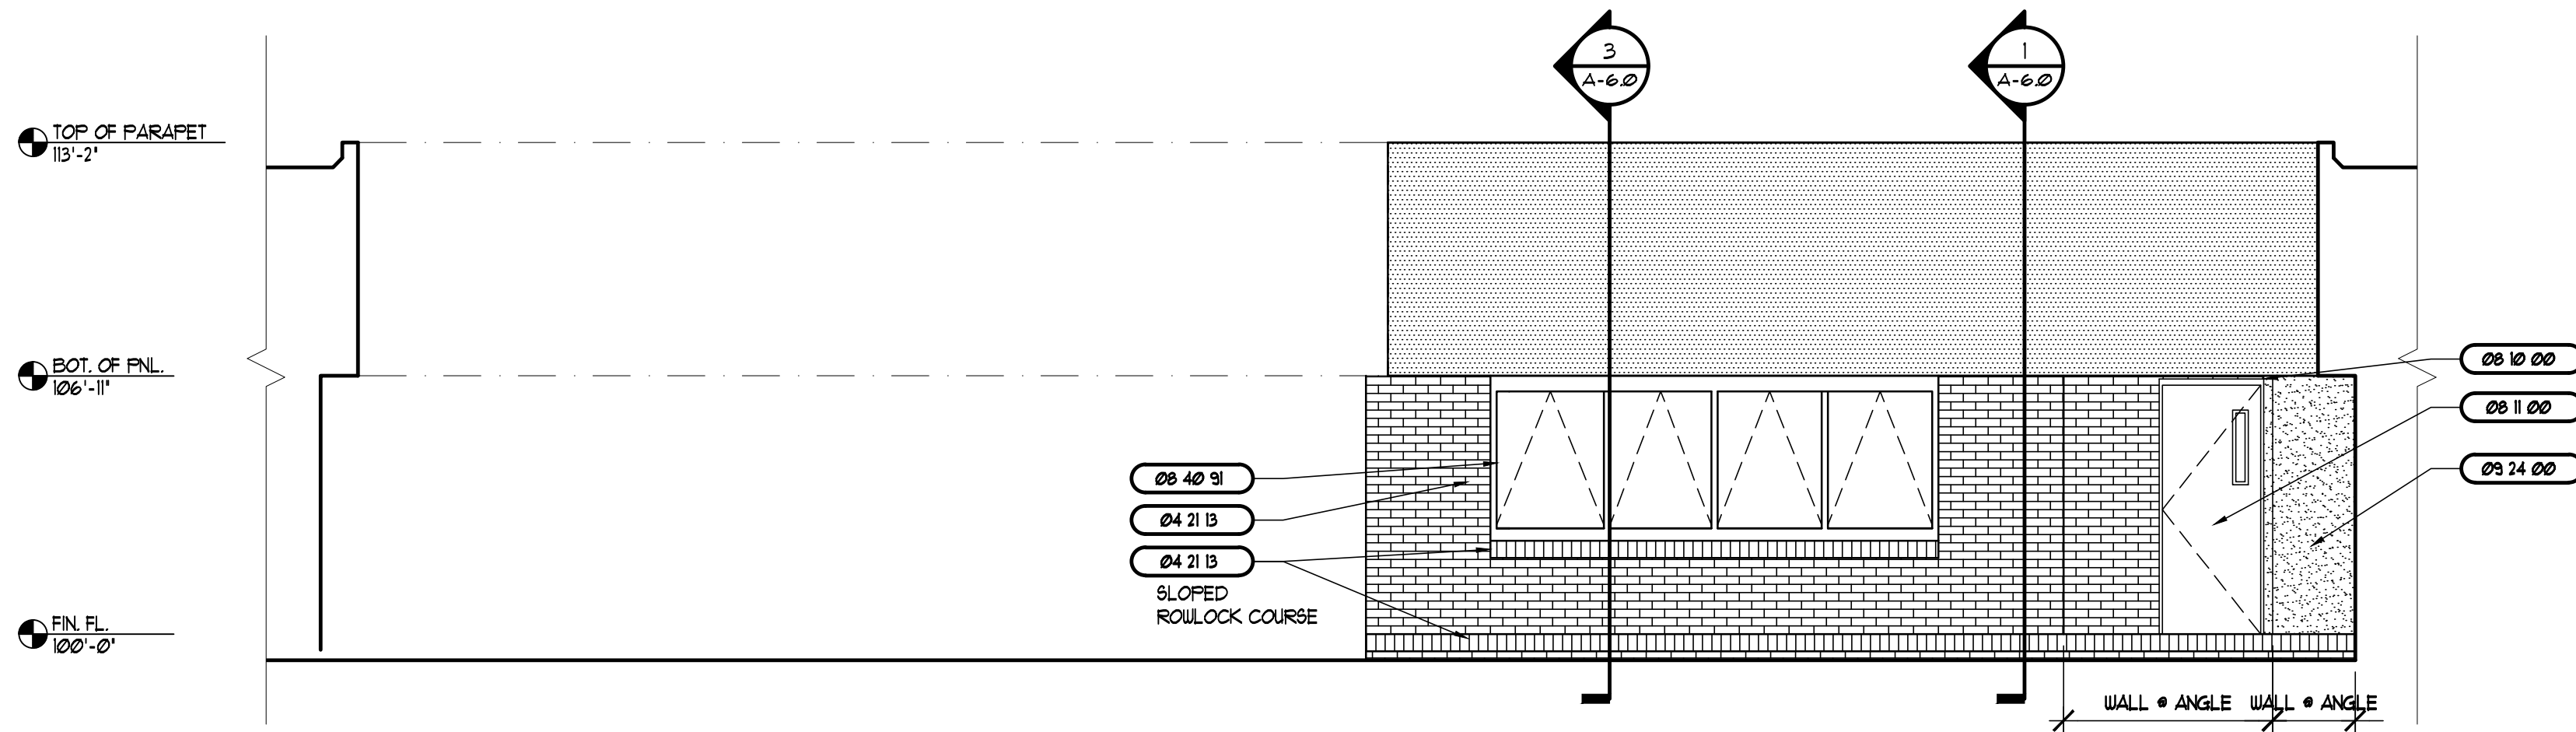

4 NEW MEDIA CENTER ELEVATION

SCALE: 1/4" = 1'-0"

## MATERIALS LIST

03 51R	SEE STRUCTURAL
03 49 16	PRE-CAST CONCRETE SPLASH BLOCKS
04 51R	SEE STRUCTURAL
04 05 23	MASONRY ACCESSORIES
04 21 13	BRICK MASONRY AND ACCESSORIES
05 51R	SEE STRUCTURAL SPECIFICATIONS
05 40 00	COLD-FORMED METAL FRAMING
05 50 00	METAL FABRICATIONS
06 10 53	ROUGH CARPENTRY (BLOCKING, ETC.)
06 11 00	ROUGH HARDWARE
06 40 23	ARCHITECTURAL LAMINATE CASEWORK
06 65 00	RECYCLED PLASTIC LUMBER
07 11 13	BITUMINOUS DAMPROOFING
07 20 60	MASONRY FOAM FILL INSULATION
07 21 00	THERMAL BATT INSULATION
07 21 13	SEMI-RIGID WALL INSULATION (FOIL FACED)
07 24 00	SUBSTRATE SHEATHING
07 41 13	PREFORMED METAL ROOFING, SIDING, SOFFIT AND TRIM
07 52 00	SEBS MODIFIED BITUMINOUS ROOF SYSTEM
07 62 00	PREFABRICATED PARAPET TOP AND COLLECTOR BOX
07 84 10	FIRE RATED PENETRATIONS AND JOINTS
07 90 00	JOINT SEALERS
08 10 00	HOLLOW METAL FRAMES
08 11 00	HOLLOW METAL DOORS
08 20 00	WOOD DOORS
08 21 00	HARDBOARD FACED DOORS
08 40 31	ALUMINUM ENTRANCE AND STOREFRONT SYSTEM
08 52 10	ALUMINUM WINDOWS
08 71 00	FINISH HARDWARE
08 80 00	GLASS AND GLAZING
09 12 00	CEILING SUSPENSION SYSTEM
09 12 50	INTERIOR NON-BEARING METAL FRAMING
09 24 00	LATH AND STUCCO
09 29 00	GYPHUM DRYWALL
09 29 10	INTERIOR TILE BACKERBOARD
09 30 00	CERAMIC TILE
09 31 00	CULTURED MARBLE
09 40 00	SOLID SURFACE COUNTERTOP
09 51 13	ACOUSTICAL CEILING PANELS
09 54 10	ACOUSTICAL INSULATION
09 65 00	RESILIENT FLOORING
09 65 10	VINYL BASE
09 68 13	VINYL CUSHION CARPET TILES
09 91 00	PAINTING
10 11 00	MARKERBOARDS
10 11 13	TACKABLE WALL PANELS
10 14 00	IDENTIFYING DEVICES
10 26 13	HIGH IMPACT WALL COVERING
10 28 00	TOILET AND BATH ACCESSORIES
10 44 00	FIRE EXTINGUISHERS AND CABINETS
10 61 00	SHELVING
11 52 13	MANUAL PROJECTION SCREENS
22 PLUMB	SEE PLUMBING SPECIFICATIONS
23 MECH	SEE MECHANICAL SPECIFICATIONS
26 ELECT	SEE ELECTRICAL SPECIFICATIONS

## REVISIONS AND UPDATES


02/14/14		CONSTRUCTION DOCUMENTS FOR BID/PERMIT

SUWANNEE COUNTY SCHOOL BOARD		
SUWANNEE PRIMARY SCHOOL		
ADDITIONS AND REMODELING		
1625 WALKER AVE. SW		LIVE OAK, FLORIDA
EXTERIOR ELEVATIONS		




drawn 02/18/14	CHK	checked 02/16/14	JCZ	approved	JCZ
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RZK		JOHN C. ZWICK, R.A. FL. REG. AR0009521	Job no. 20031
AA-C000568			A-4.0

ARCHITECTS RZK, INC.  
800 FLORIDA AVENUE SUITE 202 COCOA, FLORIDA 32922 TELEPHONE (321) 631-8030



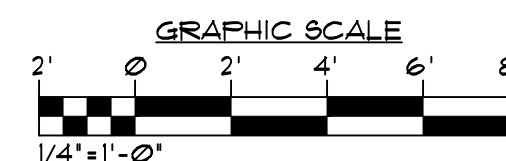

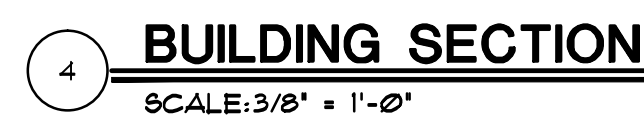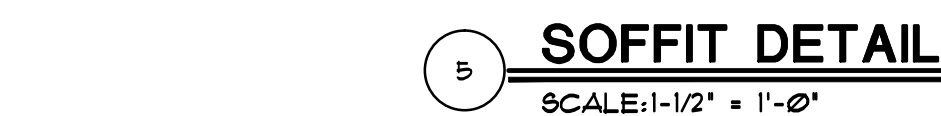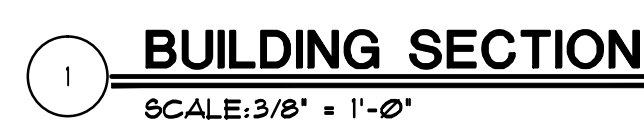

## MATERIALS LIST

03 5TR  
03 48 16  
04 5TR  
04 05 23  
04 21 13  
05 5TR  
05 40 00  
05 50 00  
06 10 53  
06 11 00  
06 40 23  
06 65 00  
07 11 13  
07 20 60  
07 21 00  
07 21 13  
07 24 00  
07 41 13  
07 52 00  
07 62 00  
07 64 10  
07 90 00  
08 10 00  
08 11 00  
08 20 00  
08 21 00  
08 22 31  
08 52 10  
08 71 00  
08 80 00  
09 12 00  
09 13 50  
09 24 00  
09 25 00  
09 29 10  
09 30 00  
09 31 00  
09 40 00  
09 51 13  
09 54 10  
09 65 00  
09 65 10  
09 68 13  
09 91 00  
10 11 00  
10 11 13  
10 14 00  
10 26 13  
10 28 00  
10 44 00  
10 67 00  
11 52 13  
22 PLUMB  
23 MECH  
26 ELECT

SEE STRUCTURAL  
FIRE-CAST CONCRETE SPLASH BLOCKS  
SEE STRUCTURAL  
MASONRY ACCESSORIES  
BRICK MASONRY AND ACCESSORIES  
SEE STRUCTURAL SPECIFICATIONS  
COLD-FORMED METAL FRAMING  
METAL FABRICATIONS  
ROUGH CARPENTRY (BRACKING, ETC.)  
ROUGH HARDWARE  
ARCHITECTURAL LAMINATE CASEWORK  
RECYCLED PLASTIC LUMBER  
BITUMINOUS DAMPROOFING  
MASONRY FOAM FILL INSULATION  
THERMAL BATT INSULATION  
SEMI-RIGID WALL INSULATION (FOIL FACED)  
SUBSTRATE SHEATHING  
PREFORMED METAL ROOFING, SIDING, SOFFIT AND TRIM  
SBS MODIFIED BITUMINOUS ROOF SYSTEM  
PREFABRICATED PARAPET TOP AND COLLECTOR BOX  
FIRE RATED PENETRATIONS AND JOINTS  
JOINT SEALERS  
HOLLOW METAL FRAMES  
HOLLOW METAL DOORS  
WOOD DOORS  
HARDBOARD FACED DOORS  
ALUMINUM ENTRANCE AND STOREFRONT SYSTEM  
ALUMINUM WINDOWS  
FINISH HARDWARE  
GLASS AND GLAZING  
CEILING SUSPENSION SYSTEM  
INTERIOR NON-BEARING METAL FRAMING  
LATH AND STUCCO  
GYPSUM DRYWALL  
INTERIOR TILE BACKERBOARD  
CERAMIC TILE  
CULTURED MARBLE  
SOLID SURFACE COUNTERTOP  
ACOUSTICAL CEILING PANELS  
ACOUSTICAL INSULATION  
RESILIENT FLOORING  
VINYL BASE  
VINYL CUSHION CARPET TILES  
PAINTING  
MARKERBOARD  
TACKABLE WALL PANELS  
IDENTIFYING DEVICES  
HIGH IMPACT WALL COVERING  
TOILET AND BATH ACCESSORIES  
FIRE EXTINGUISHERS AND CABINETS  
SHELVING  
MANUAL PROJECTION SCREENS  
SEE PLUMBING SPECIFICATIONS  
SEE MECHANICAL SPECIFICATIONS  
SEE ELECTRICAL SPECIFICATIONS

## REVISIONS AND UPDATES

02/14/14		CONSTRUCTION DOCUMENTS FOR BID/PERMIT

**SUWANNEE COUNTY SCHOOL BOARD  
SUWANNEE PRIMARY SCHOOL  
ADDITIONS AND REMODELING**

**1625 WALKER AVE., SW                      LIVE OAK, FLORIDA**

**BUILDING SECTIONS**

drawn 02/18/14	CNK	checked 02/16/14	JCZ	approved	JCZ
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☐ ☐ ☐ ☐ ☐

PAK

JOHN C. ZWICK, R.A.  
FL. REG. AR0009527

Job no. 201251




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AA-C00568

1 of 1

**ARCHITECTS RZK, INC.**  
600 FLORIDA AVENUE SUITE 202 COCOA, FLORIDA 32922 TELEPHONE (321) 631-8033


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1 WALL SECTION  
SCALE: 1" = 1'-0"

2 WALL SECTION  
SCALE: 1" = 1'-0"

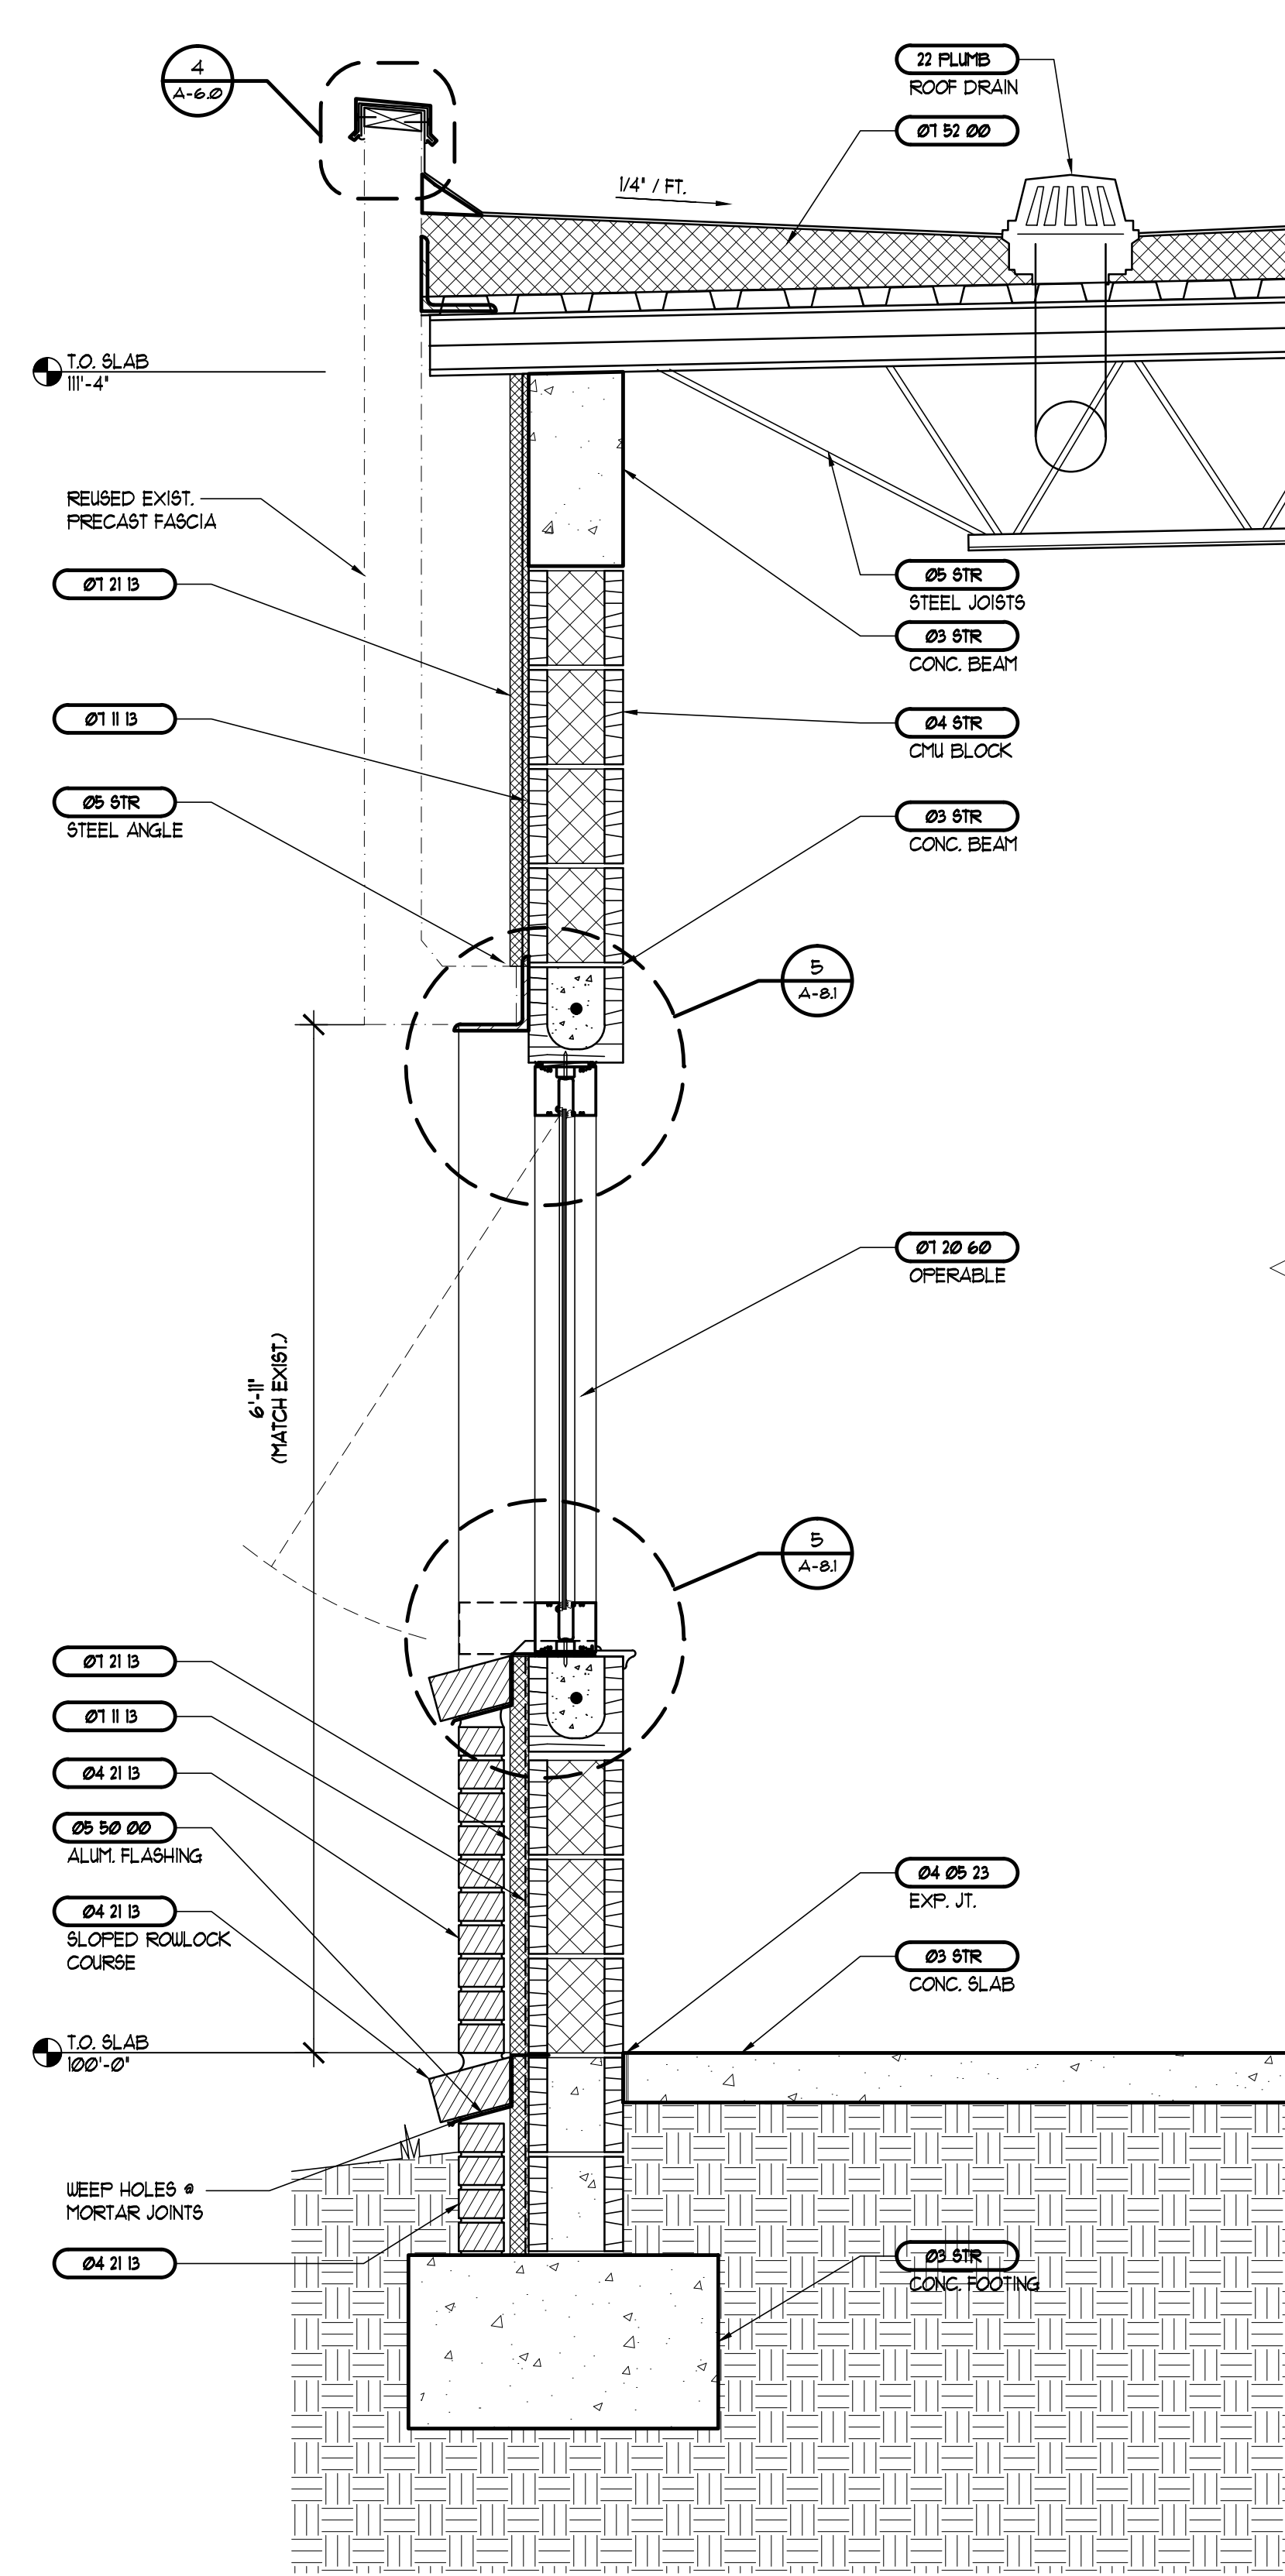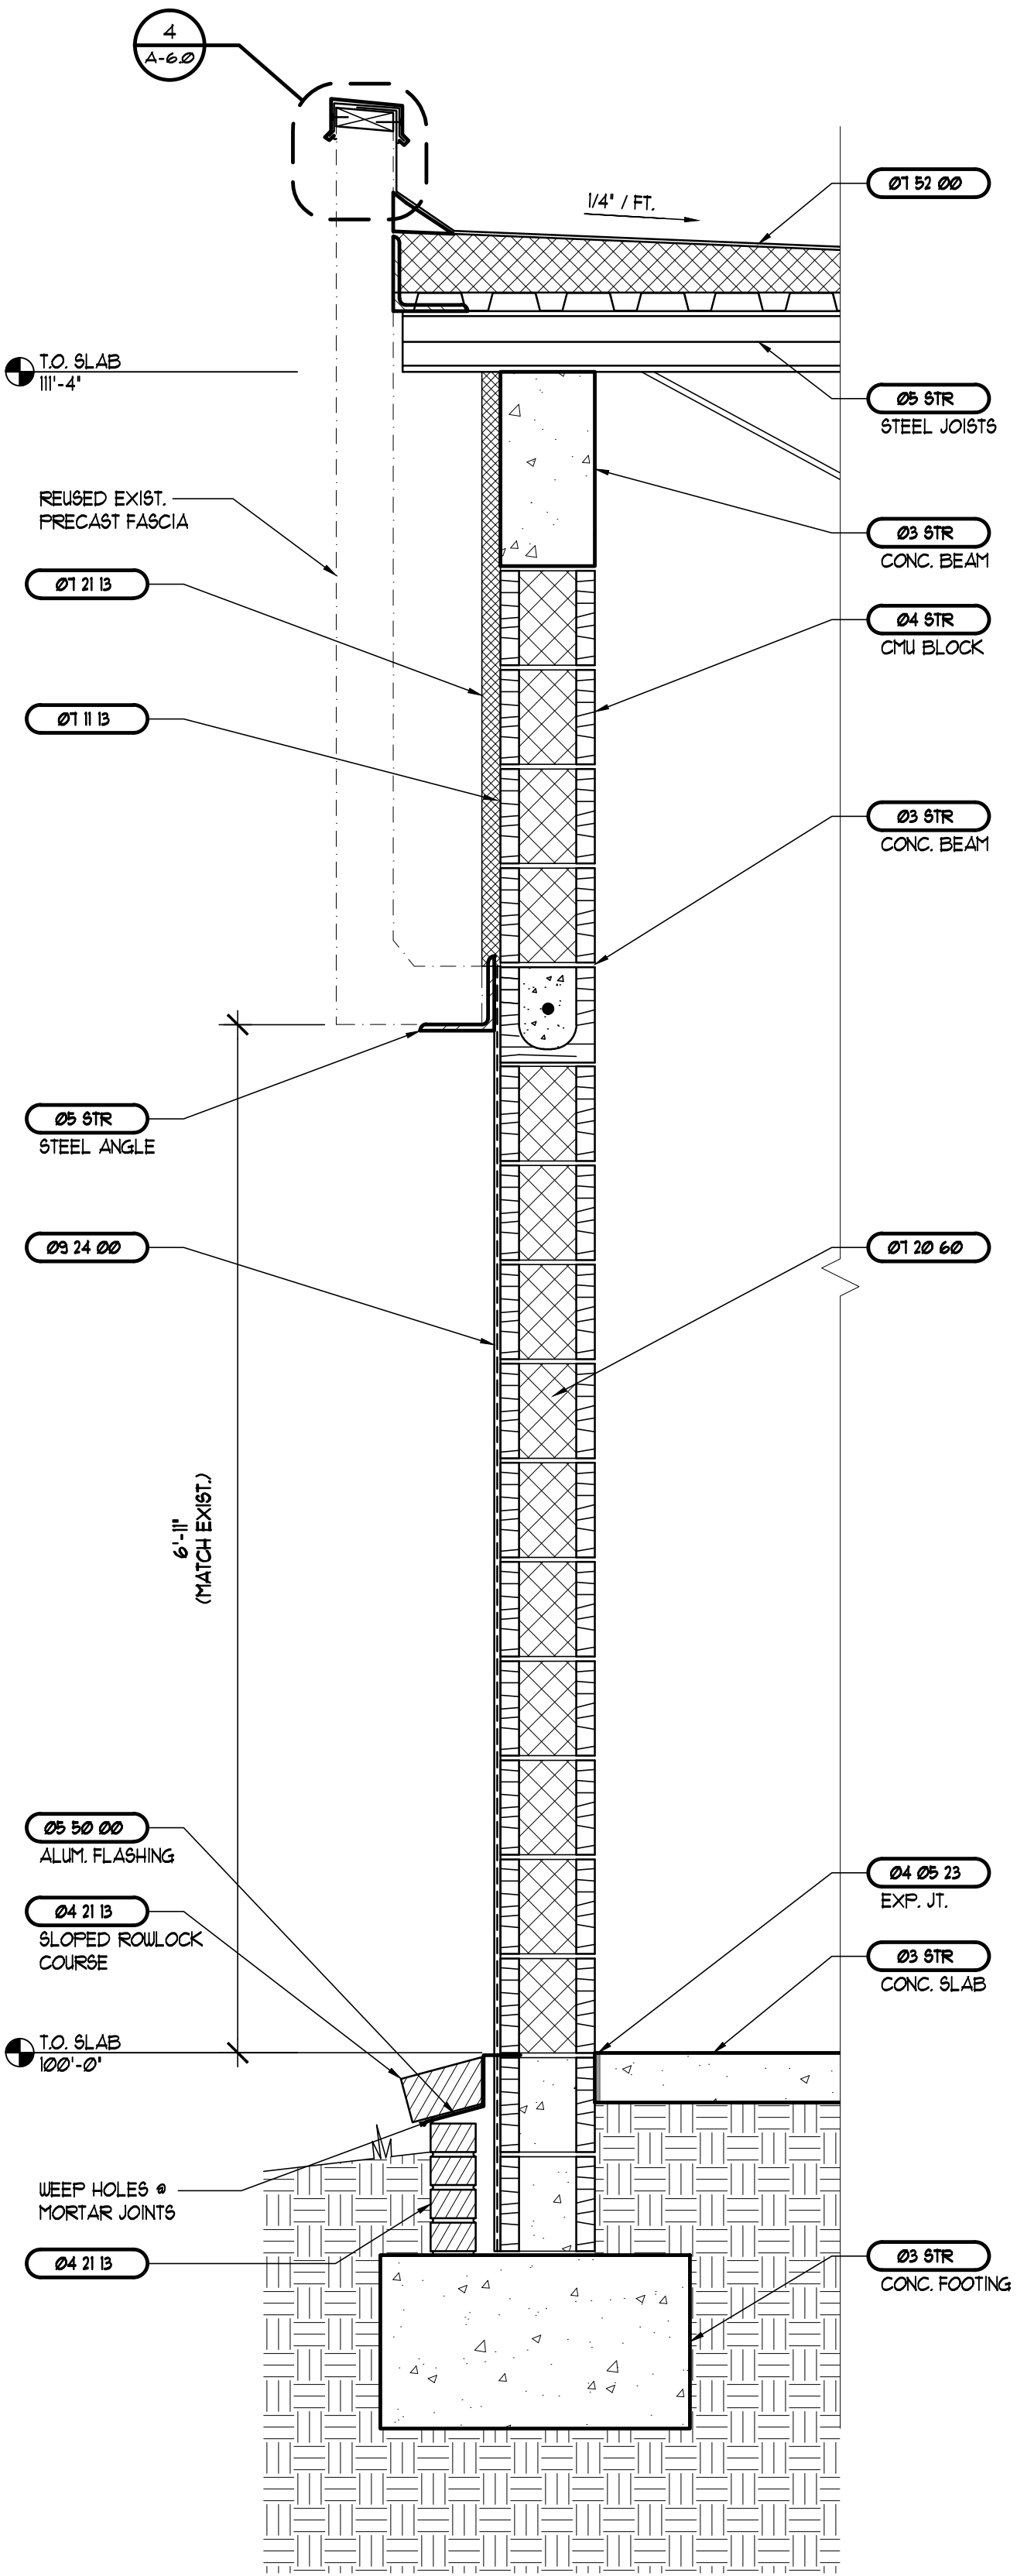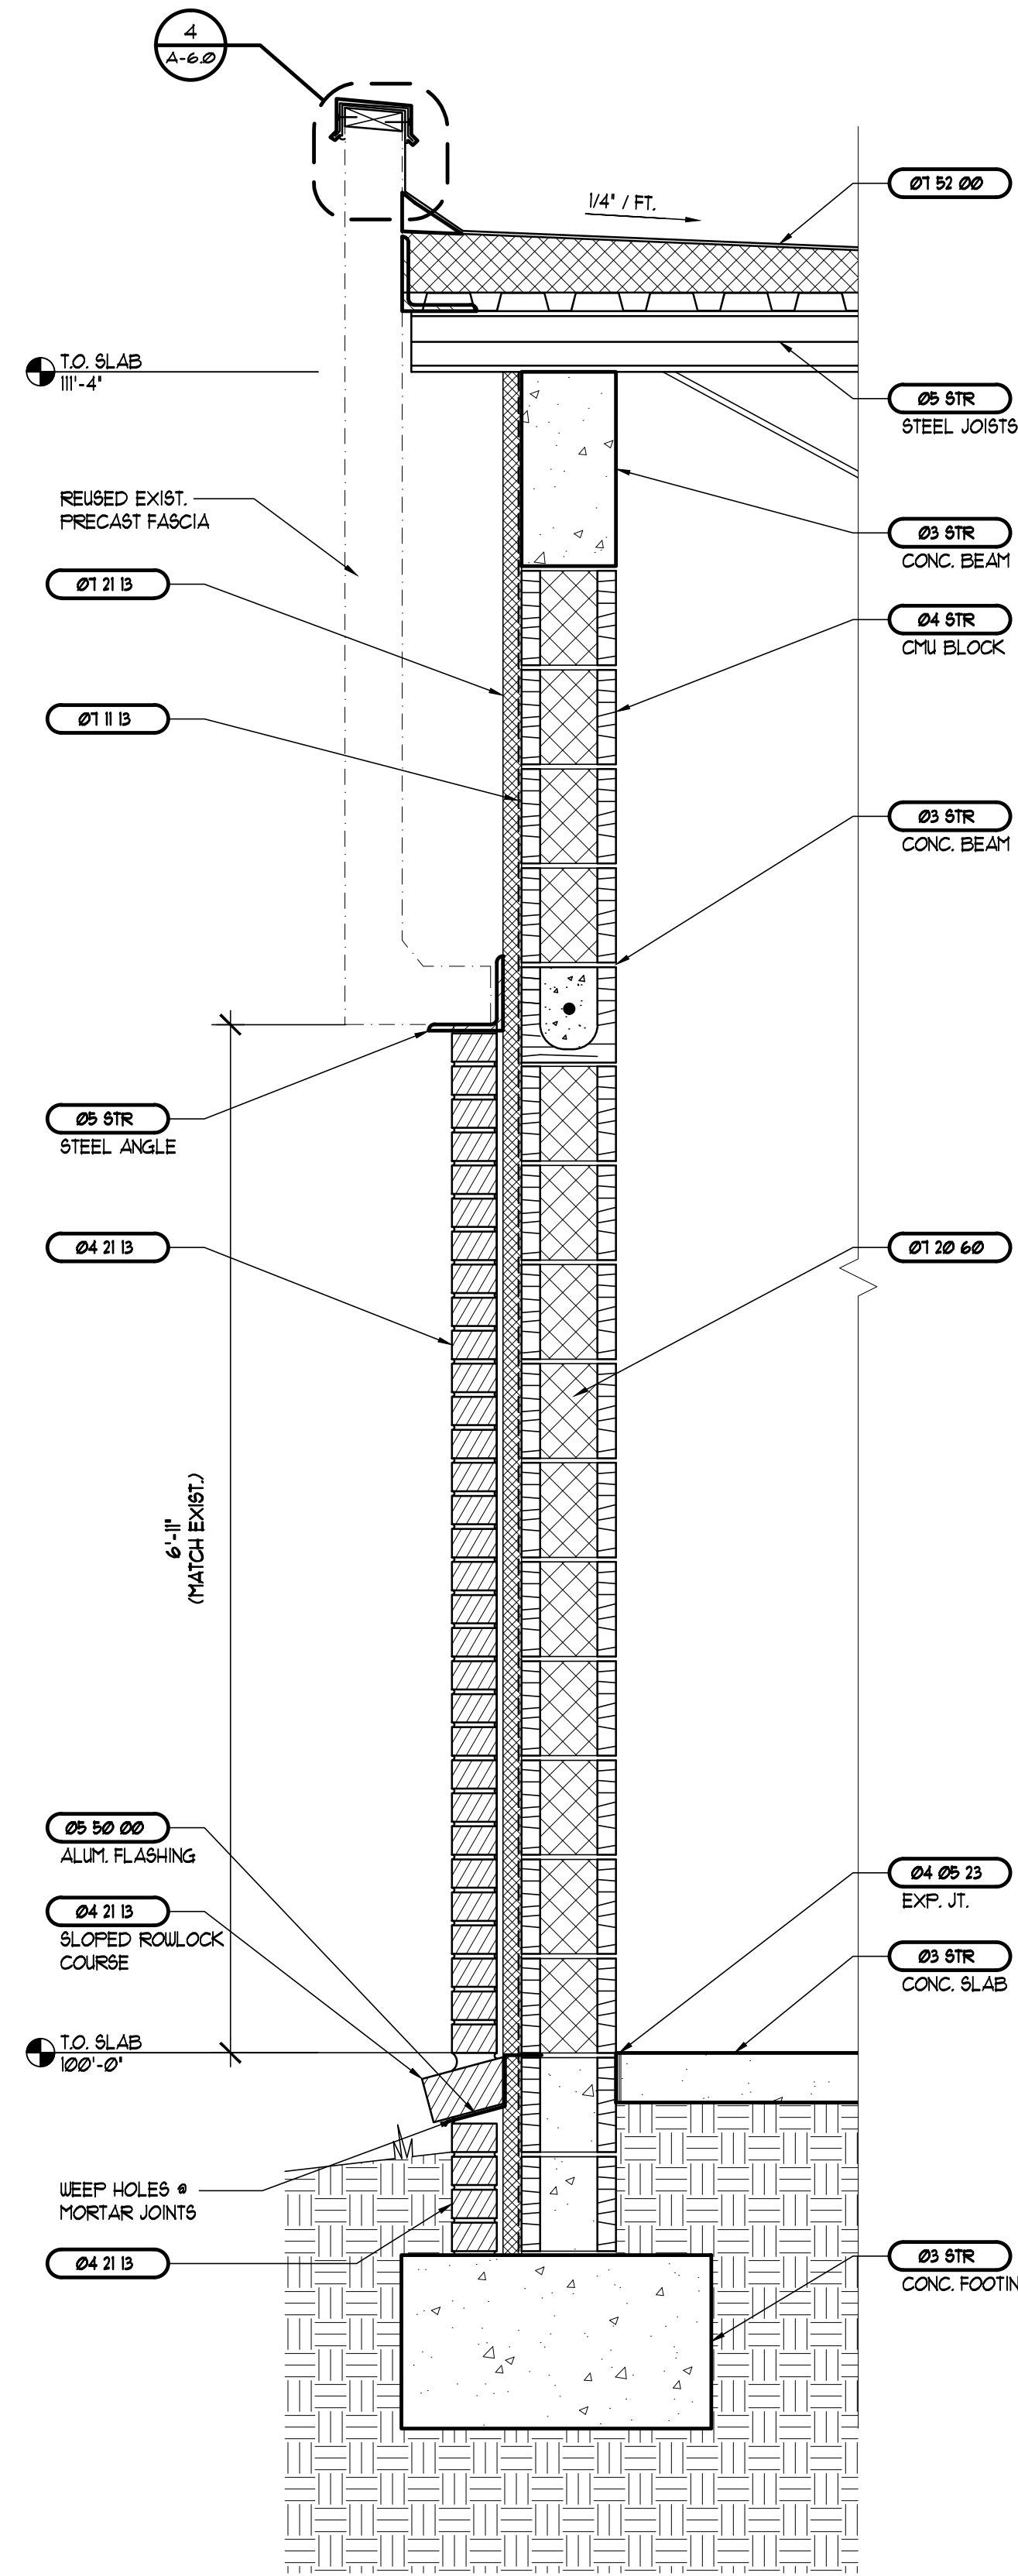3 WALL SECTION  
SCALE: 1" = 1'-0"



4 PARAPET CAP DETAIL  
SCALE: 3" = 1'-0"
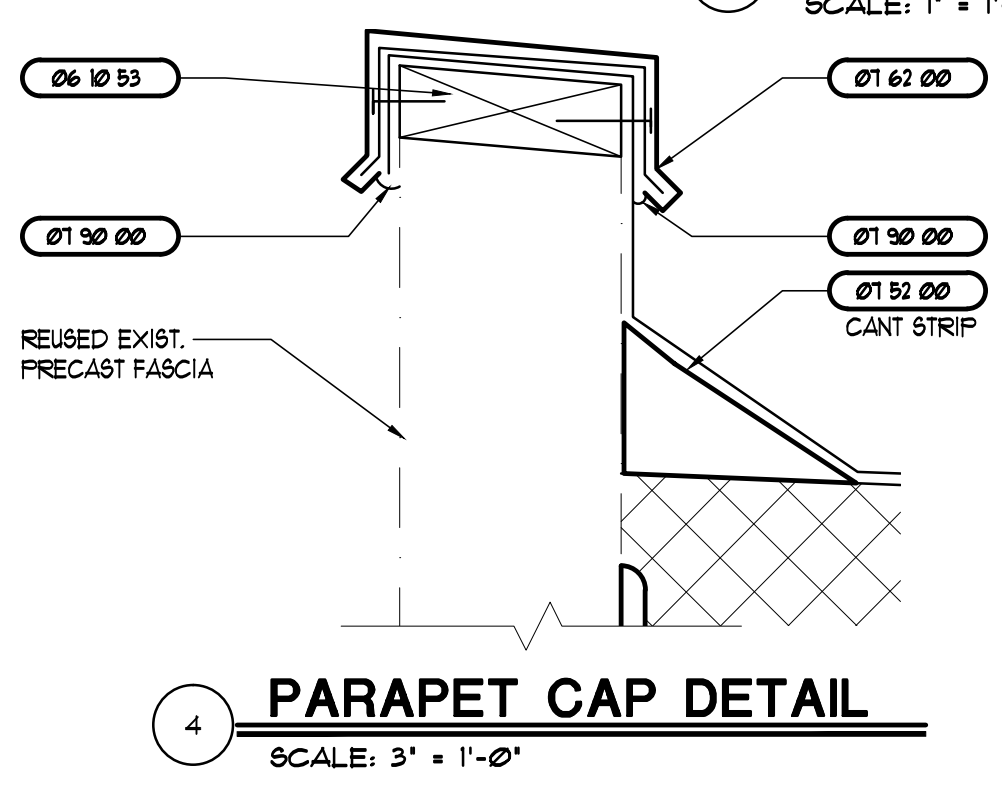
## MATERIALS LIST

03 STR	SEE STRUCTURAL
03 48 16	PRE-CAST CONCRETE SPLASH BLOCKS
04 STR	SEE STRUCTURAL
04 05 23	MASONRY ACCESSORIES
04 21 B	BRICK MASONRY AND ACCESSORIES
05 STR	SEE STRUCTURAL SPECIFICATIONS
05 40 00	COLD-FORMED METAL FRAMING
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06 10 53	ROUGH CARPENTRY (BLOCKING, ETC.)
06 11 00	ROUGH HARDWARE
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07 11 B	BITUMINOUS DAMPROOFING
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07 41 B	PREFORMED METAL ROOFING, SIDING, SOFFIT AND TRIM
07 52 00	SEBS MODIFIED BITUMINOUS ROOF SYSTEM
07 62 00	PREFABRICATED PARAPET TOP AND COLLECTOR BOX
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08 10 00	HOLLOW METAL FRAMES
08 11 00	HOLLOW METAL DOORS
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09 40 00	SOLID SURFACE COUNTERTOP
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09 65 00	RESILIENT FLOORING
09 65 10	VINYL BASE
09 68 18	VINYL CUSHION CARPET TILES
09 91 00	PAINTING
10 11 00	MARKERBOARDS
10 11 B	TACKABLE WALL PANELS
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23 MECH	SEE MECHANICAL SPECIFICATIONS
26 ELECT	SEE ELECTRICAL SPECIFICATIONS

## REVISIONS AND UPDATES

02/14/14		CONSTRUCTION DOCUMENTS FOR BID/PERMIT

SUWANNEE COUNTY SCHOOL BOARD  
SUWANNEE PRIMARY SCHOOL  
ADDITIONS AND REMODELING  
1625 WALKER AVE. SW LIVE OAK, FLORIDA

WALL SECTIONS

drawn 02/18/14	CHK	checked 02/16/14	JCZ	approved	JCZ
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**RZK**  
AA-C000568




JOHN C. ZWICK, R.A.  
FL. REG. AR0009521

Job no. 20031

**A-6.0**

**ARCHITECTS RZK, INC.**  
800 FLORIDA AVENUE SUITE 202 COCOA, FLORIDA 32922 TELEPHONE (321) 631-8030



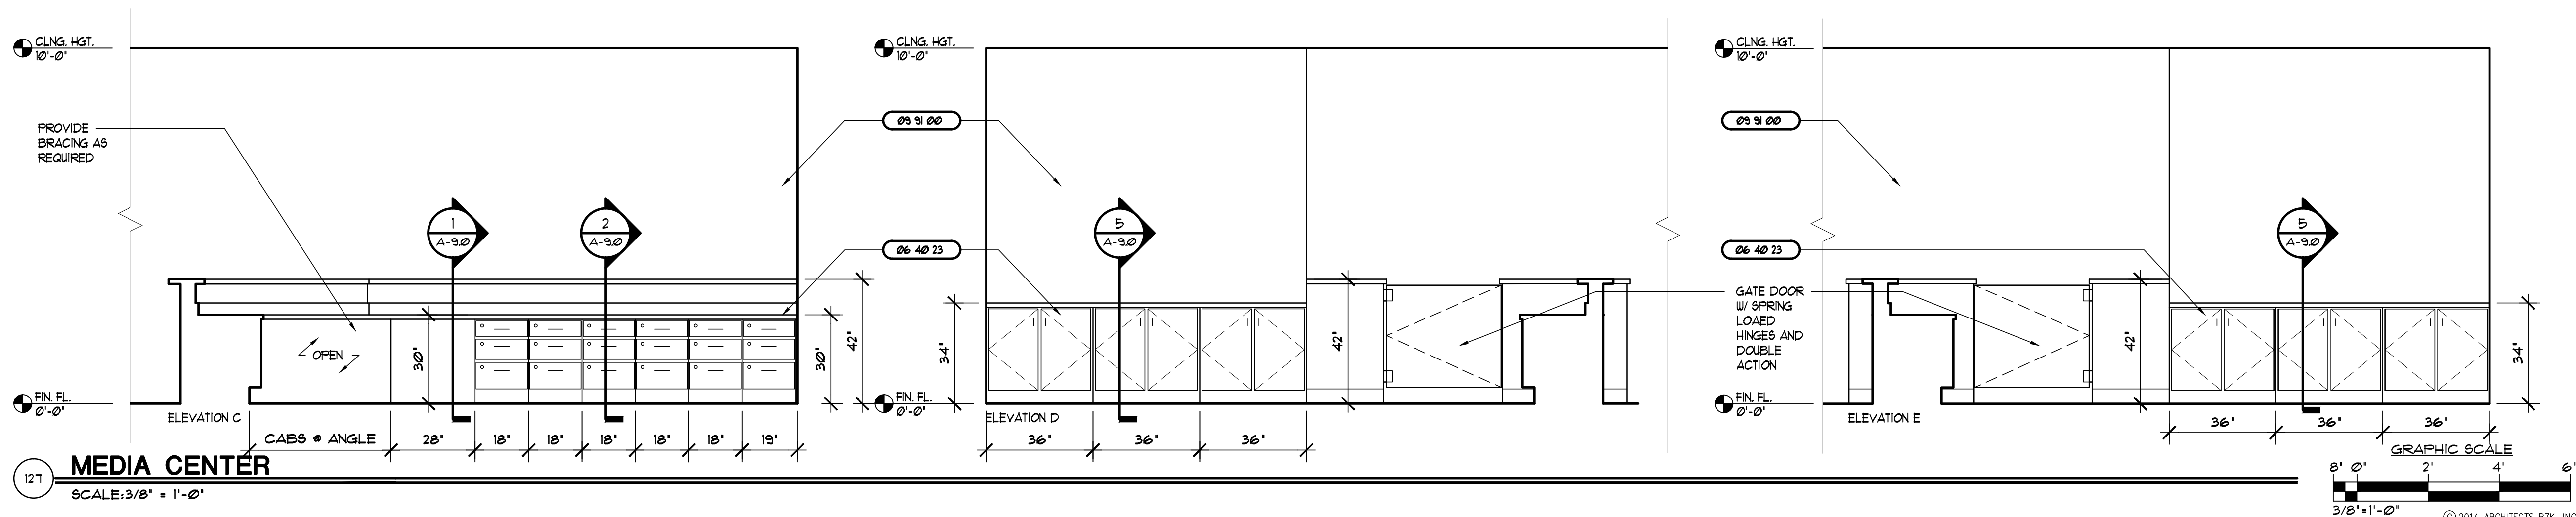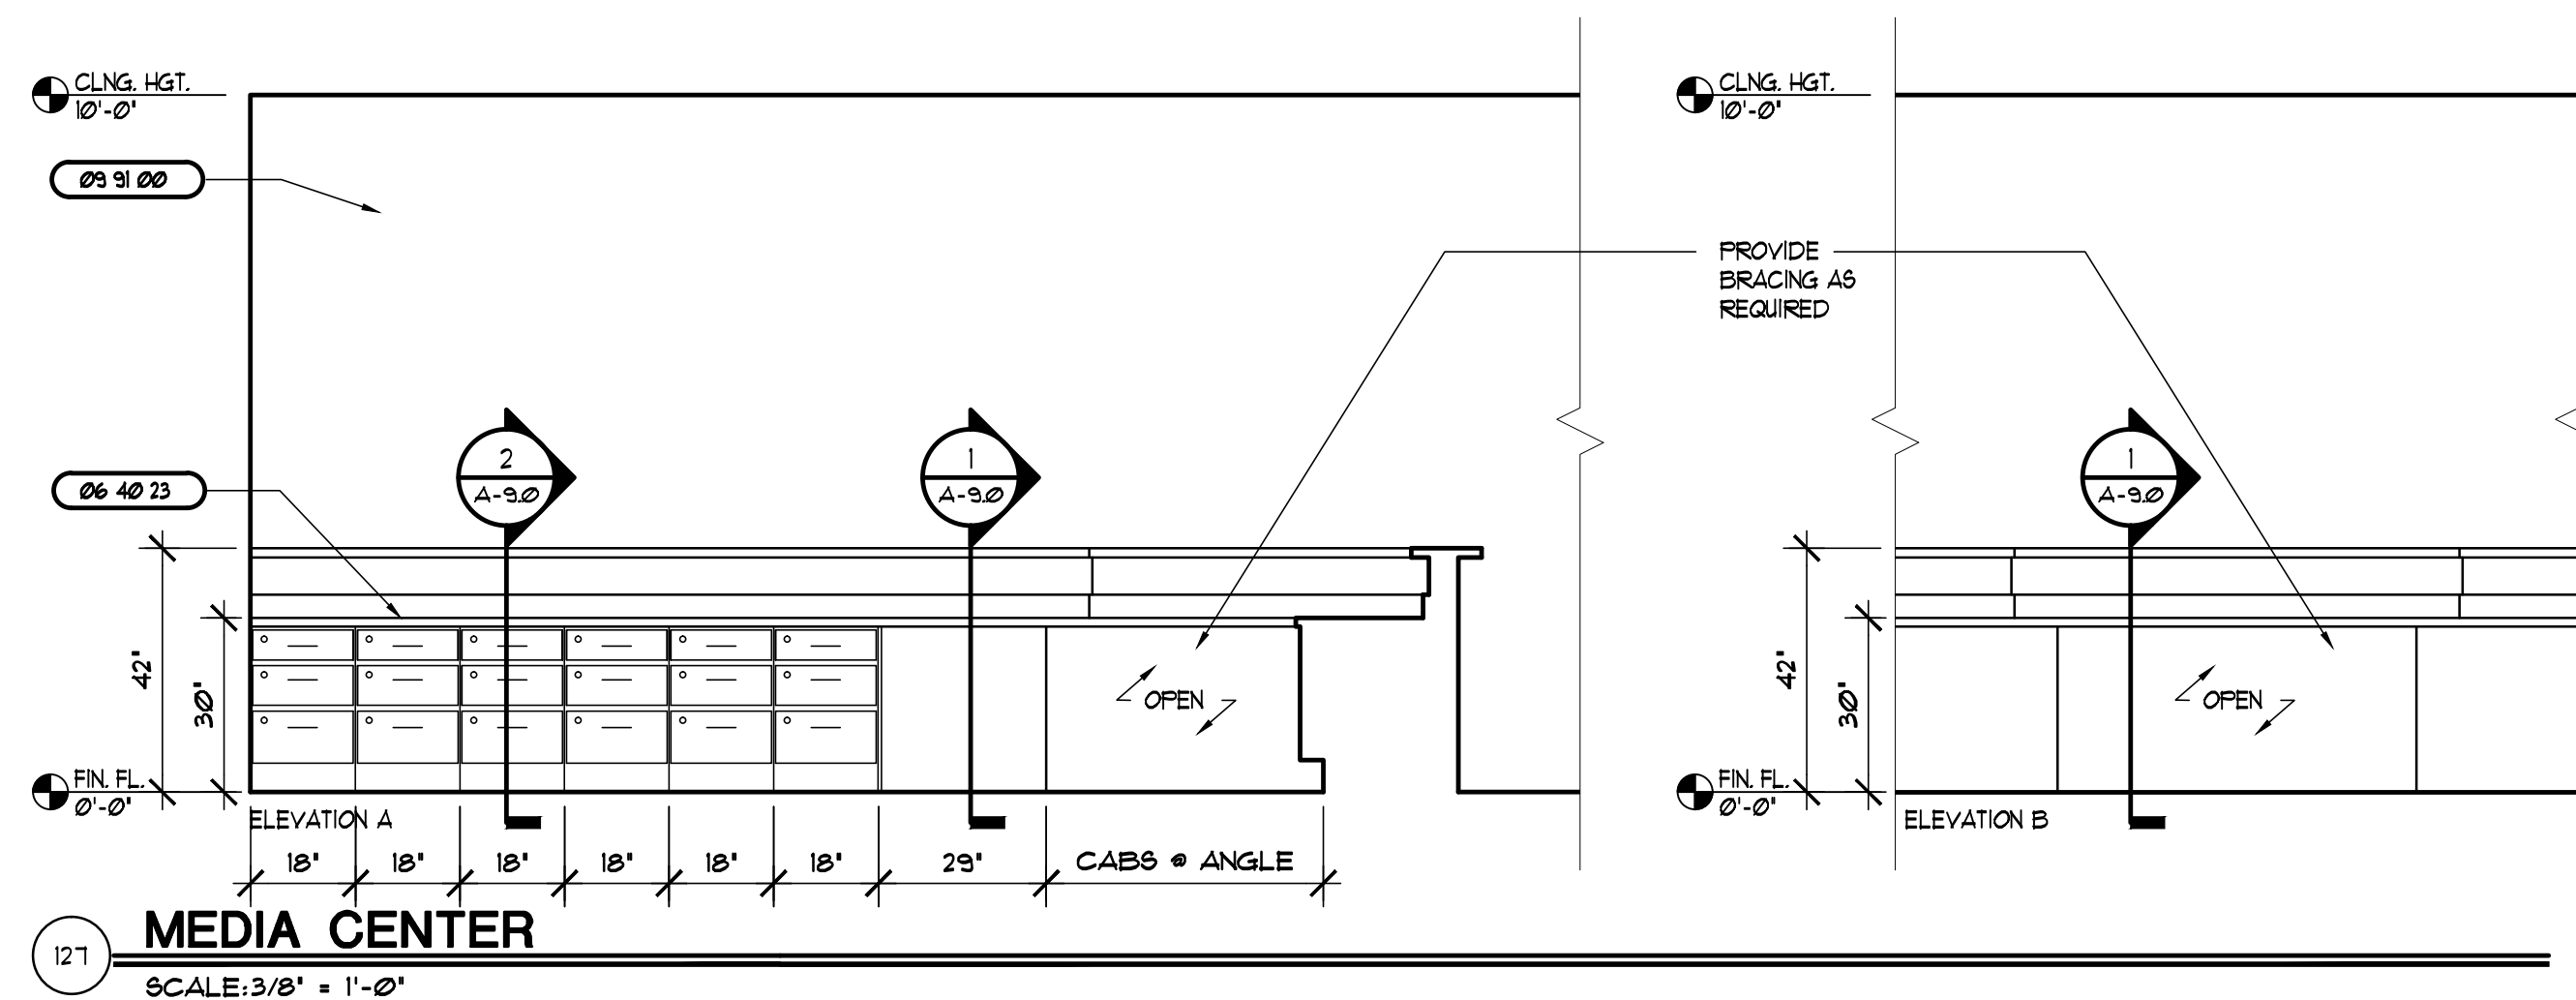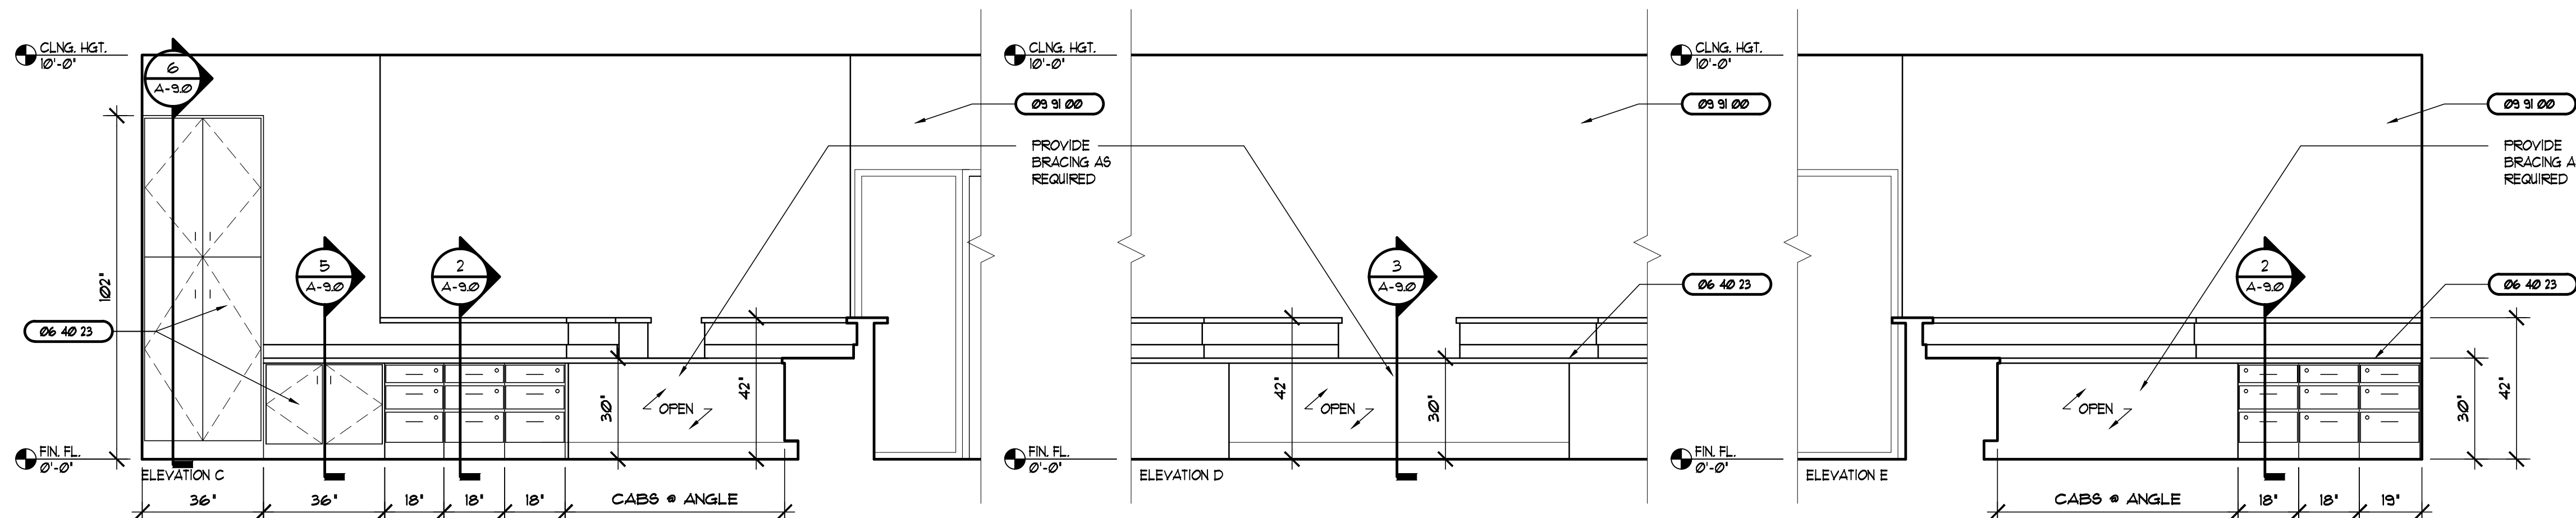

## MATERIALS LIST

03 STR	SEE STRUCTURAL
03 48 16	PRE-CAST CONCRETE SPLASH BLOCKS
04 STR	SEE STRUCTURAL
04 05 23	MASONRY ACCESSORIES
04 21 13	BRICK MASONRY AND ACCESSORIES
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06 10 53	ROUGH CARPENTRY (BLOCKING, ETC.)
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## REVISIONS AND UPDATES

02/14/14		CONSTRUCTION DOCUMENTS FOR BID/PERMIT

**SUWANNEE COUNTY SCHOOL BOARD  
SUWANNEE PRIMARY SCHOOL  
ADDITIONS AND REMODELING**

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**INTERIOR ELEVATIONS**

drawn 02/18/14	CNK	checked 02/16/14	JCZ	approved	JCZ
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JOHN C. ZWICK, R.A.  
FL. REG. AR0009527

Job no. 20251

A-7.0

AA-C00568

**ARCHITECTS RZK, INC.**  
100 FLORIDA AVENUE SUITE 202 COCOA, FLORIDA 32922 TELEPHONE (321) 631-8038

DOOR HARDWARE SETS													REMARKS
SET	HARDWARE												
	HINGES	LOCKSET(S)	DEAD BOLT	CLOSERS(S)	KICKPLATE(S)	THRESHOLD	WEATHER STRIP	FLUSH BOLT	DOOR STOP(S)	RAIN DRIP	PANIC		
01	B	B	-	-	A	A	A	-	A	-	-		
02	B	B	-	-	A	A	A	-	A	-	-		
03	A	B	-	-	A	A	A	-	A	-	-		
04	A	-	-	-	A	A	-	B	-	A	-		
05	A	-	-	-	A	A	A	-	A	-	-		
06	#	-	-	#	-	A <sup>1</sup>	#	-	-	-	-	# = PER SPEC SECTION 08 40 90	
07	A	-	-	-	A	B	B	-	C	-	-		
08	A	A	-	-	A	-	B	-	A	-	-		
09	A	C	-	-	A	-	B	-	A	-	-		


### DOOR TYPE LEGEND

DOOR SIZE  
FRAME MAT./TYPE  
FIRE RATING  
DOOR MAT./TYPE  
HARDWARE SET

GENERAL DOOR NOTES:  
1. SEE SHEET A-8.0 FOR ADDITIONAL INFORMATION


DOOR HARDWARE SCHEDULE	
HINGES	A = BB STEEL B = BB STAINLESS STEEL
LOCKSETS	A = OFFICE FUNCTION (SCHLAGE RHODES 'RD' - SERIES) B = CLASSROOM SECURITY FUNCTION (SCHLAGE RHODES 'RD' - SERIES) C = STOREROOM FUNCTION (SCHLAGE RHODES 'RD' - SERIES) D = EXIT LOCK FUNCTION / BLANK ON INACTIVE SIDE (SCHLAGE RHODES 'RD' - SERIES) E = STOREROOM FUNCTION (SCHLAGE RHODES 'L' - SERIES) MORTISE F = CYTHER FUNCTION (SCHLAGE 'PRO' SERIES CYLINDRICAL - SERIES W/ Ø6 LEVER TRIM) G = PASSAGE FUNCTION (SCHLAGE RHODES 'RD' - SERIES) H = PRIVACY FUNCTION
DEAD BOLTS	A = CLASSROOM FUNCTION (SCHLAGE 'B' SERIES) B = SURFACE FUNCTION (IVES SB453 TB, US 32D)
CLOSERS	A = LCN 4010/4111 SERIES (PARALLEL ARM, ADA) B = LCN 4010/4111 SERIES (INSIDE MOUNTED ARM)
KICKPLATE	A = IVES 8400 SERIES (U32D)
DOOR STOPS	A = IVES US SERIES (W/ ADEQUATE BACK BLOCKING) B = GLYNN JOHNSON (450 SERIES) OVER-HEAD TYPE C = IVES FLOOR STOP SERIES
THRESHOLD	A = ADA COMPLIANT PER SPEC B = MARBLE (SEE TILE SPECIFICATIONS) C = VINYL CARPET EDGE (SEE VCT SPECIFICATIONS)
WEATHERSTRIP	A = PER SPEC B = FERKO 588
PANIC	A = VON DUPRIN

WINDOW SCHEDULE											
MARK	APPROXIMATE SIZE (W X H)	FR. TYPE	GLASS	DETAILS				LOCATION	REMARKS		
				HEAD	JAMB	SILL	MULLION				
A	12'-0" X 3'-8"	ALUMINUM	INSULATED	5/A-81	5/A-81	5/A-81	-	VARIES (SEE PLAN)			
B	4'-0" X 1'-0"	ALUMINUM	TEMPERED	6/A-81	6/A-81	6/A-81	-	VARIES (SEE PLAN)	SEE NOTE #1		
C	8'-0" X 3'-8"	H.M.	CLEAR FLOAT	1/A-81	1/A-81	1/A-81	-	FRONT DESK	SEE NOTE #2		
D	5'-4" X 3'-8"	H.M.	TEMPERED	6/A-81	6/A-81	6/A-81	-	COMPUTER LAB	SEE NOTE #1		
E	6' X 2'-8"	STEEL	SEE NOTE #2	-	-	-	-	DOOR LITES	SEE NOTE #2		
NOTE:											
1. ALL INTERIOR GLASS TO BE CLEAR.											
2. PROVIDE CLEAR TEMPERED GLASS AT NON-RATED AND CLEAR FIRE RATED GLASS AT RATED DOORS.											

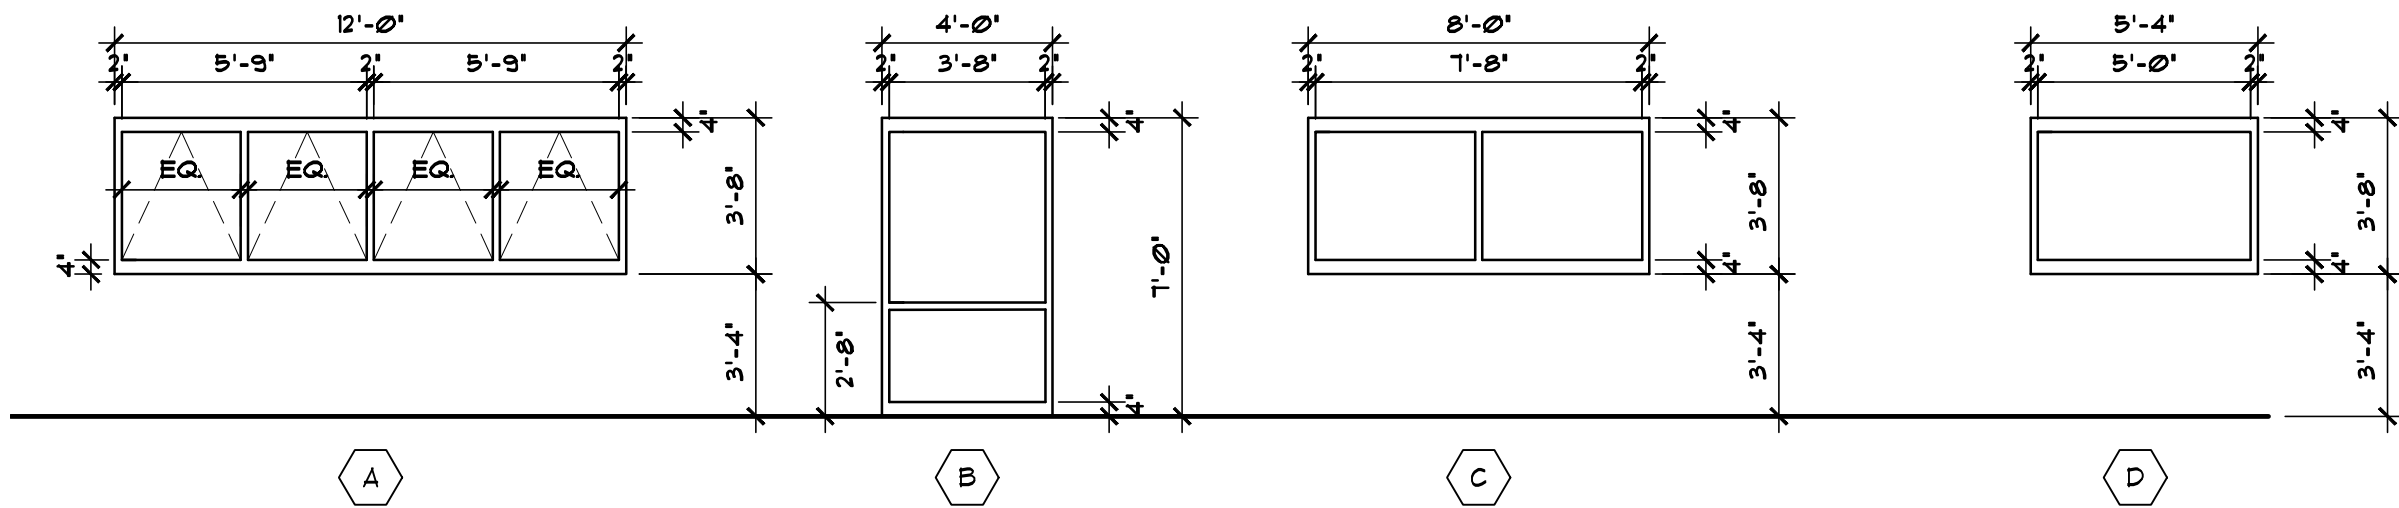

### WINDOW TYPES

SCALE: 1/4" = 1'-0"

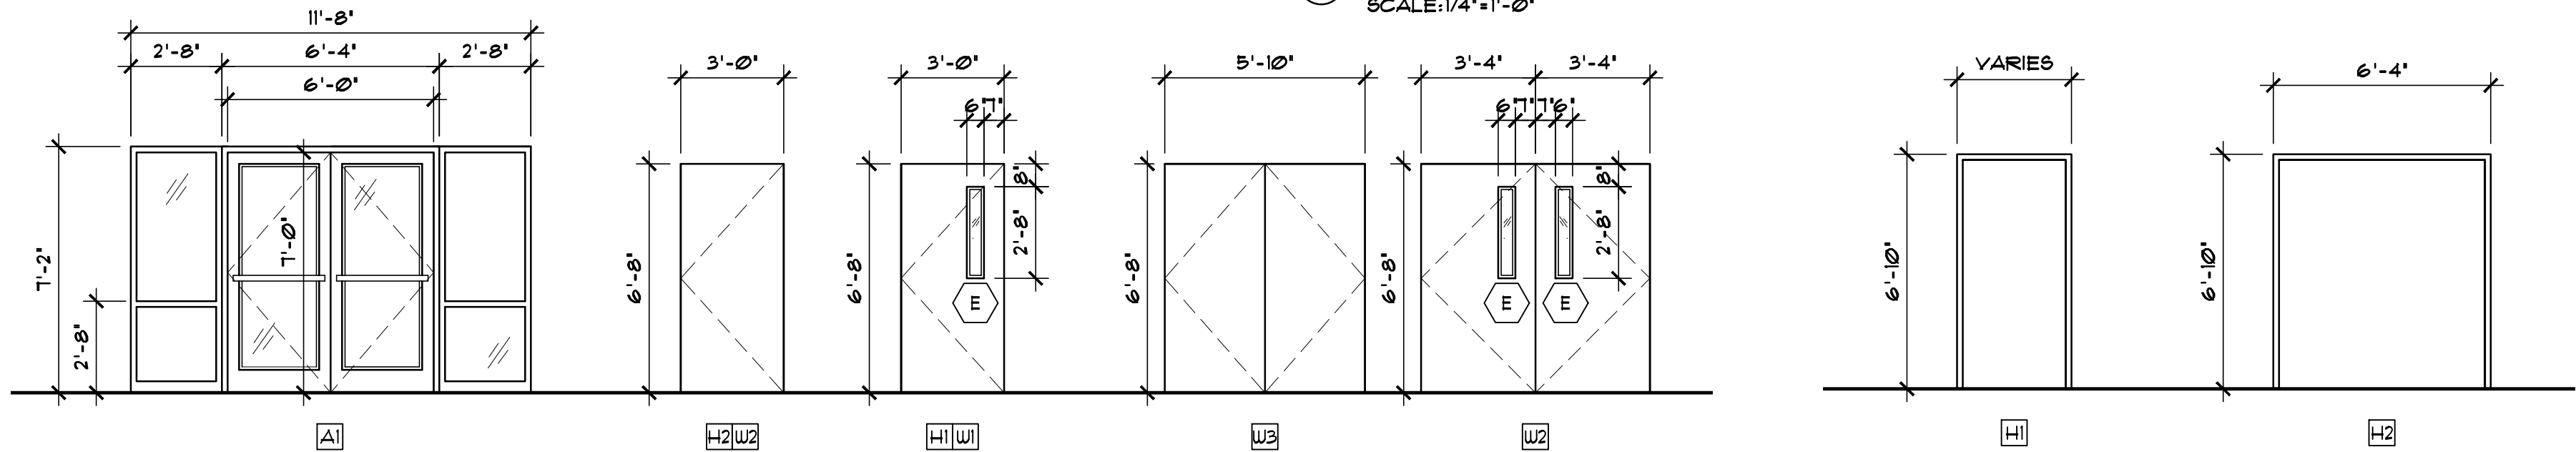

### DOOR TYPES

SCALE: 1/4" = 1'-0"

### FRAME TYPE

SCALE: 1/4" = 1'-0"

### REVISIONS AND UPDATES

02/14/14		CONSTRUCTION DOCUMENTS FOR BID/PERMIT

SUWANNEE COUNTY SCHOOL BOARD  
SUWANNEE PRIMARY SCHOOL  
ADDITIONS AND REMODELING  
1625 WALKER AVE., SW  
DOOR AND WIN. SCHEDULES AND TYPES


1625 WALKER AVE., SW  
LIVE OAK, FLORIDA

drawn 02/18/14 CNK  
checked 02/16/14 JCZ  
approved JCZ


JOHN C. ZWICK, R.A.  
FL. REG. AR0009521

job no. 20031  
A-8.0

ARCHITECTS RZK, INC.  
800 FLORIDA AVENUE SUITE 202 COCOA, FLORIDA 32922  
TELEPHONE (321) 631-8039

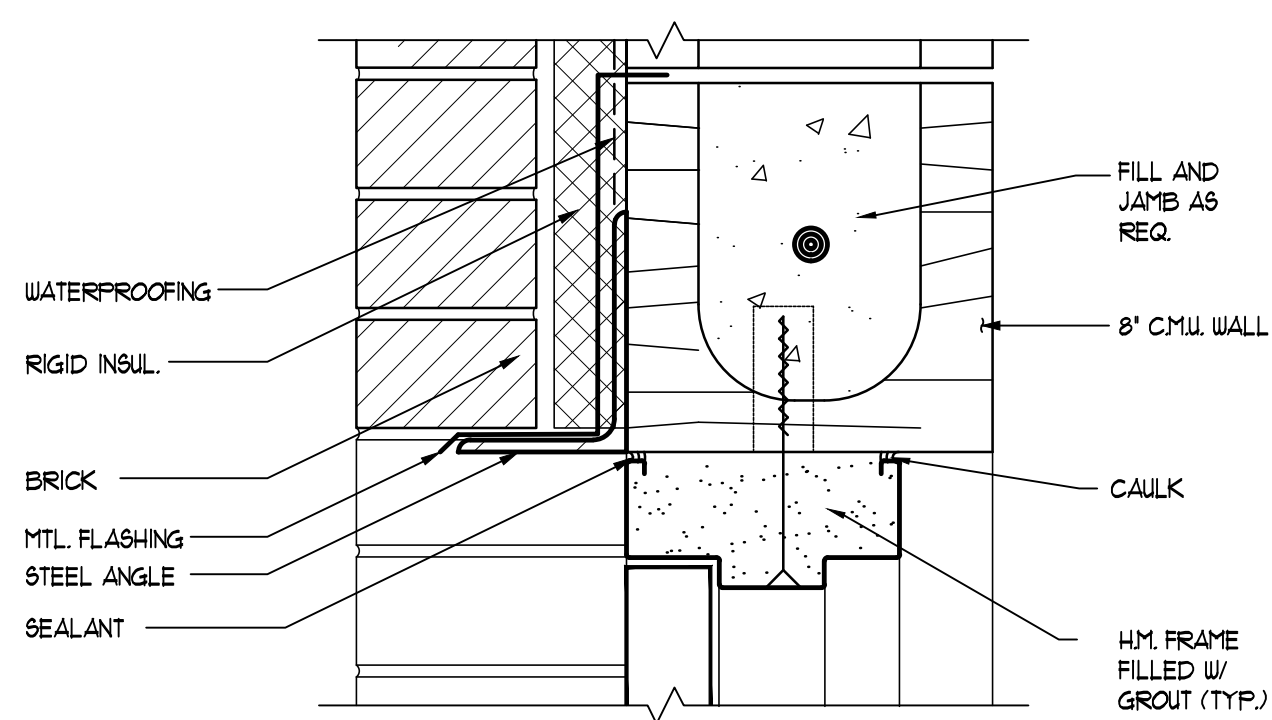


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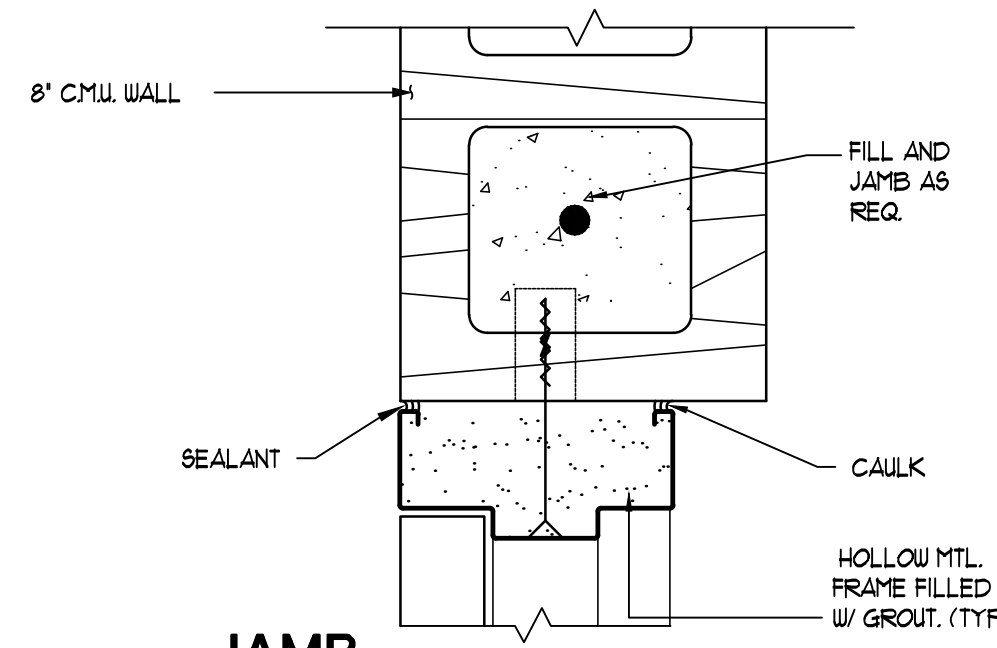


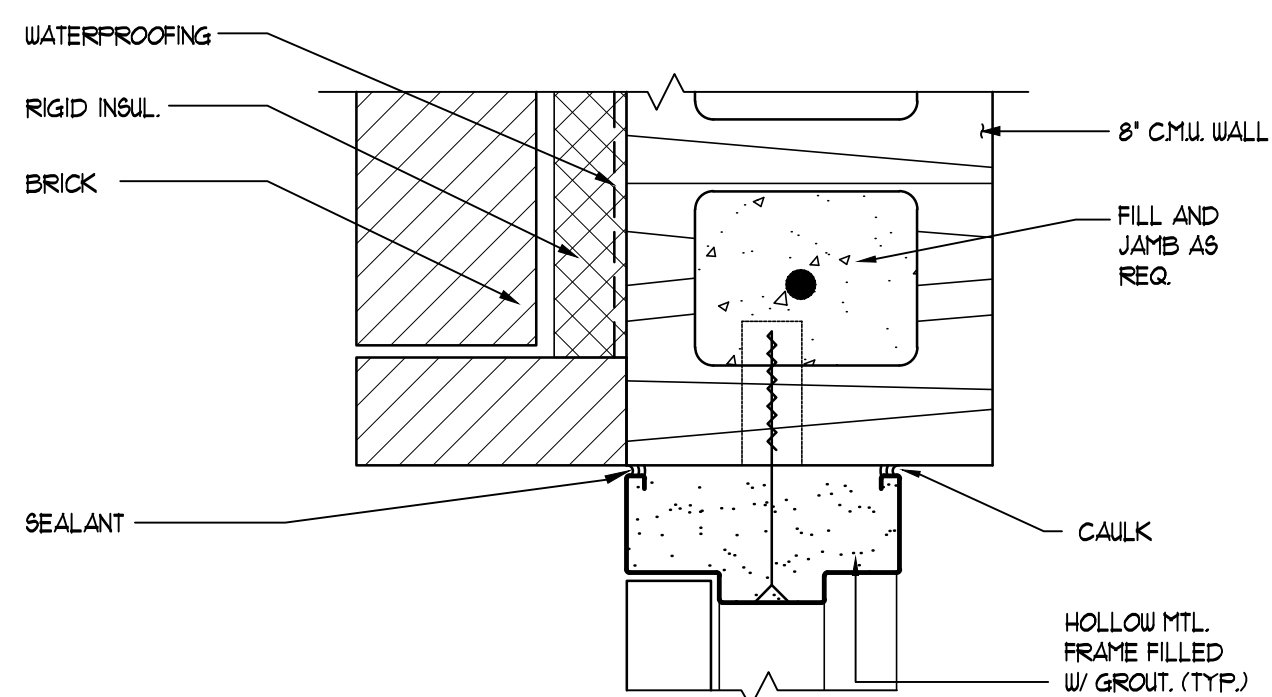JAMB

1 EXTERIOR DOOR DETAILS  
SCALE: 3/4" = 1'-0"

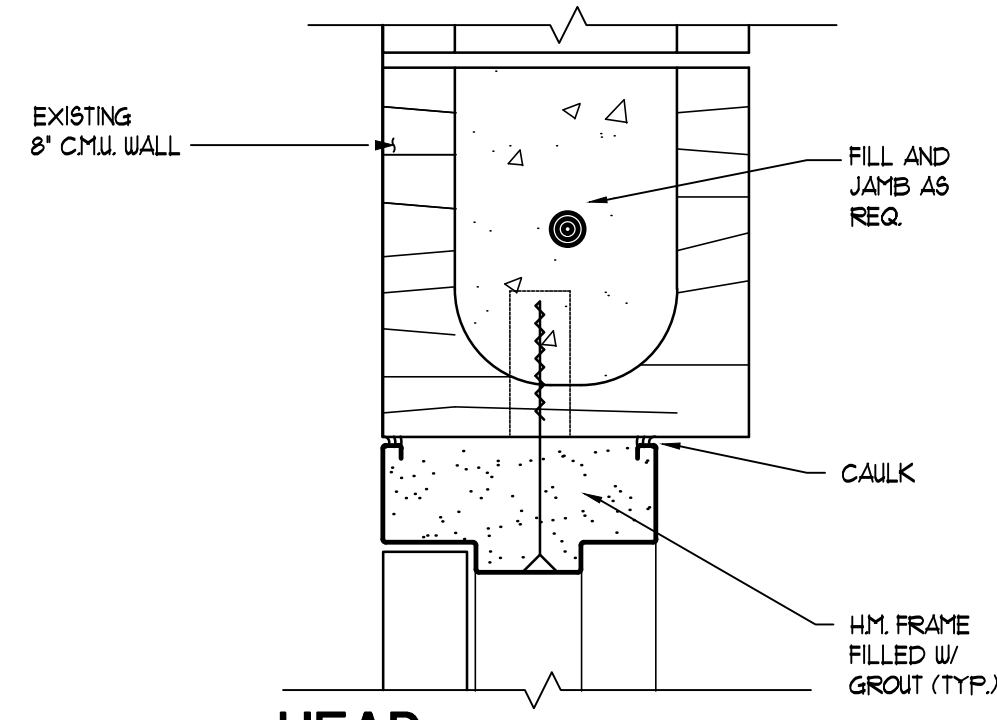


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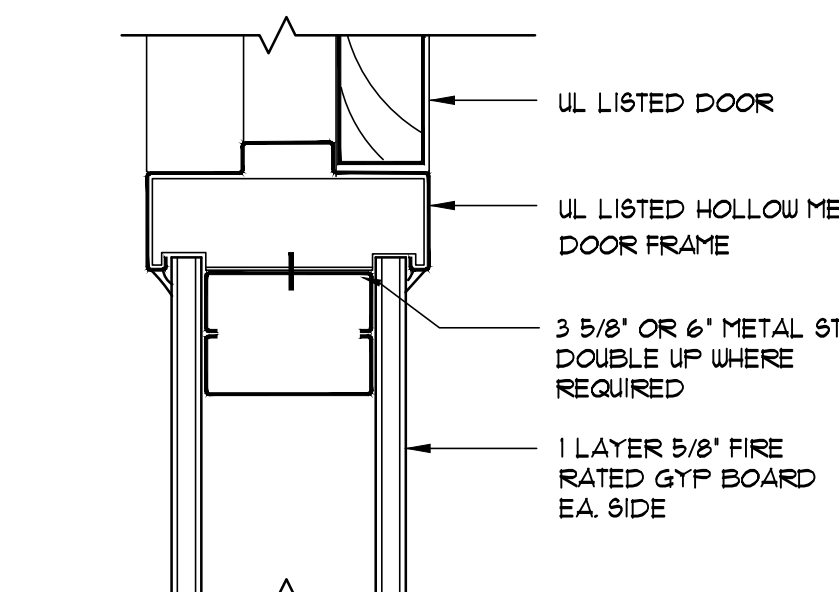
JAMB

2 INTERIOR DOOR DETAILS  
SCALE: 3/4" = 1'-0"

NOTE:  
SEAT FRAME AT EDGE  
FOR 120° - 180° DEGREE  
SWINGS




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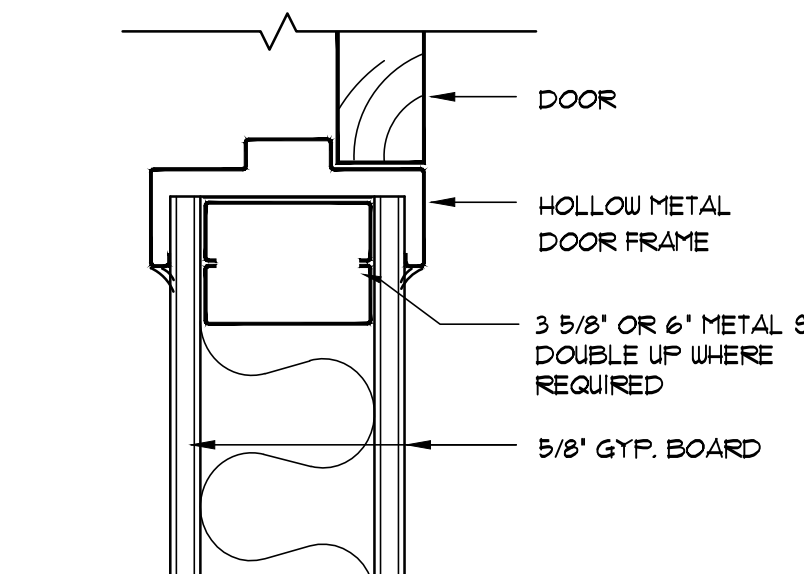


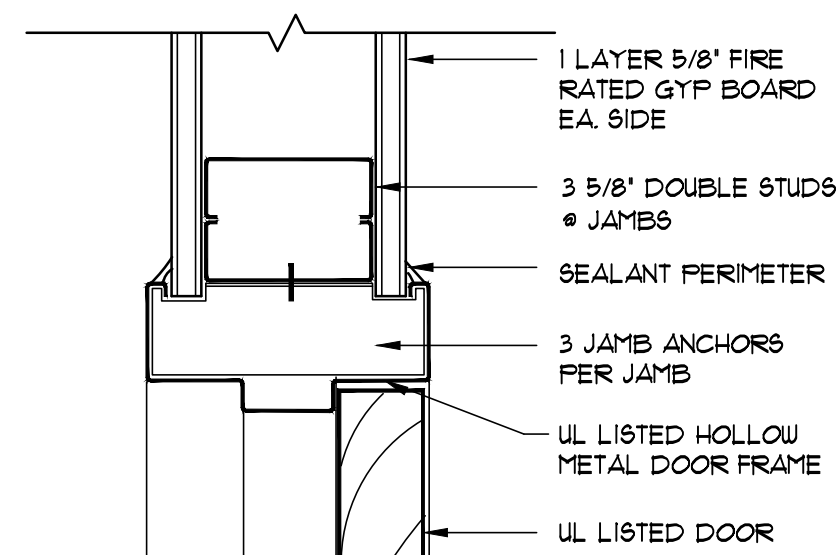JAMB

3 RATED DOOR DETAILS  
SCALE: 3/4" = 1'-0"

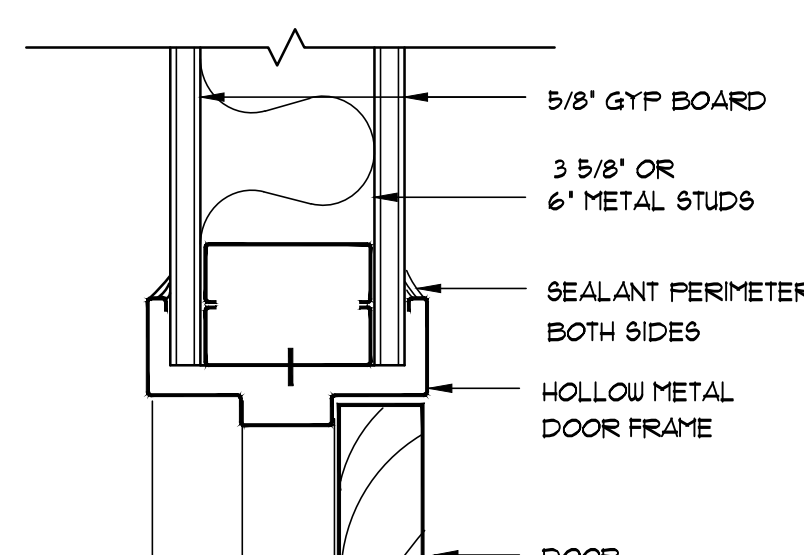


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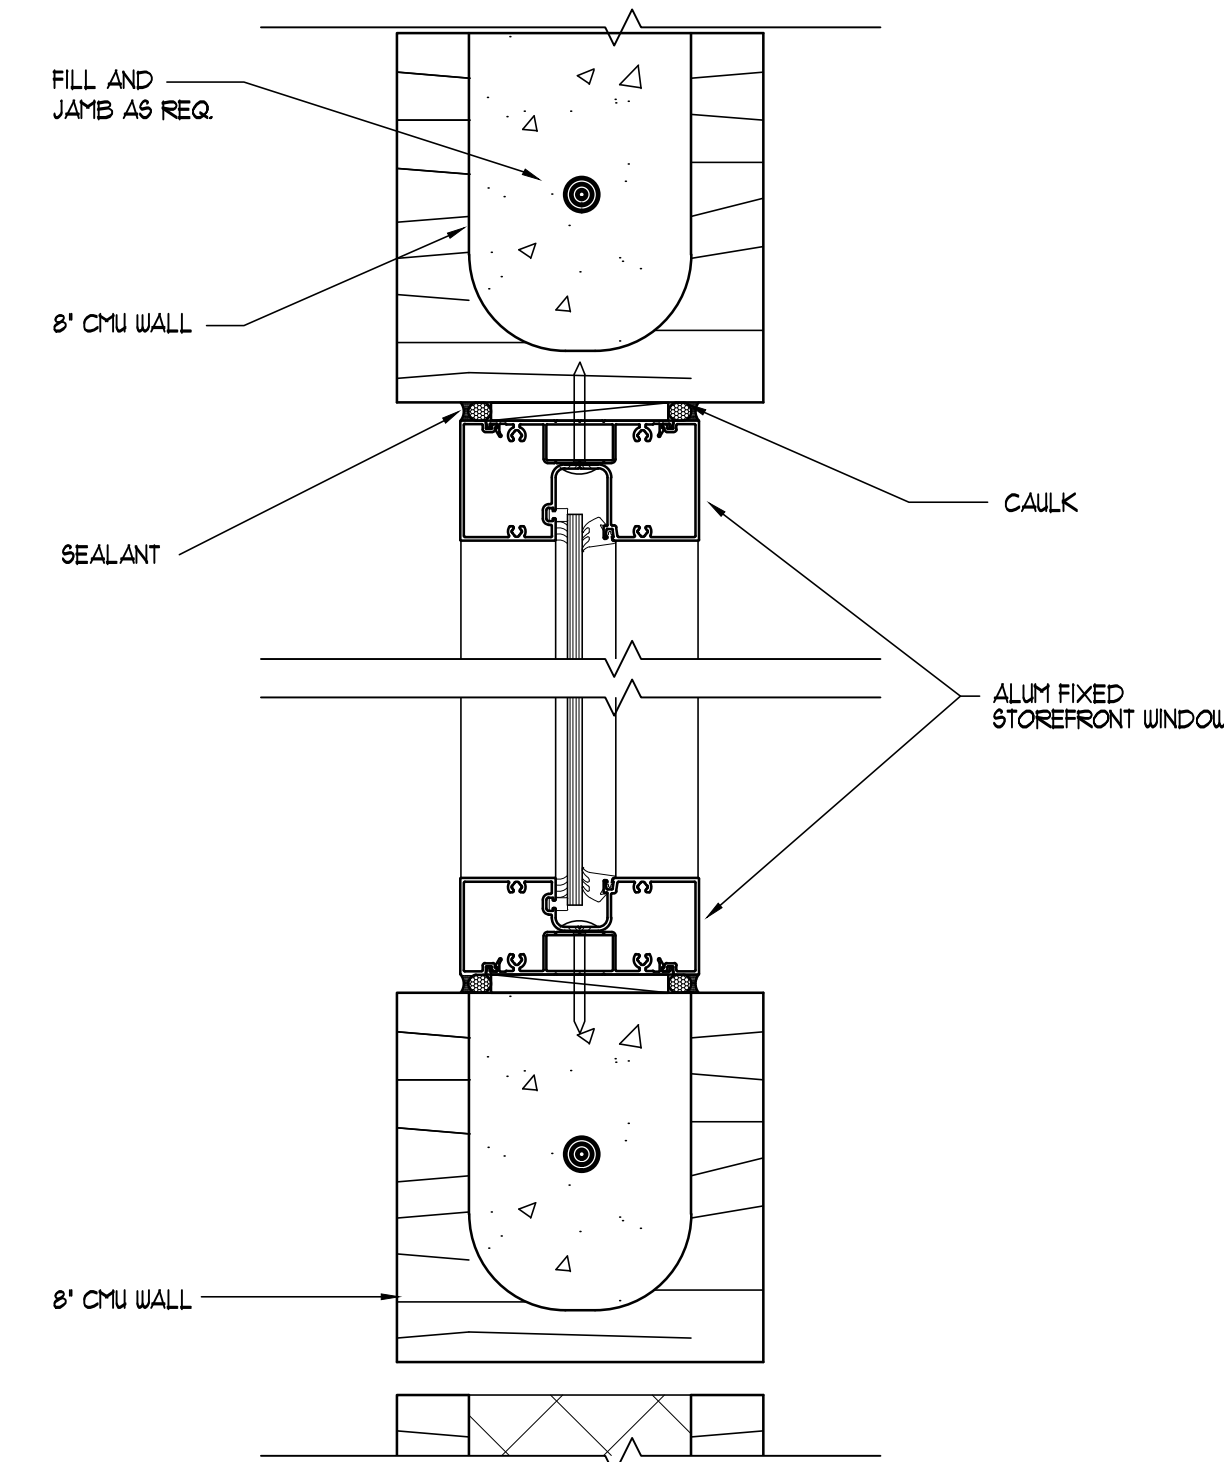


JAMB


4 INTERIOR DOOR DETAILS  
SCALE: 3/4" = 1'-0"

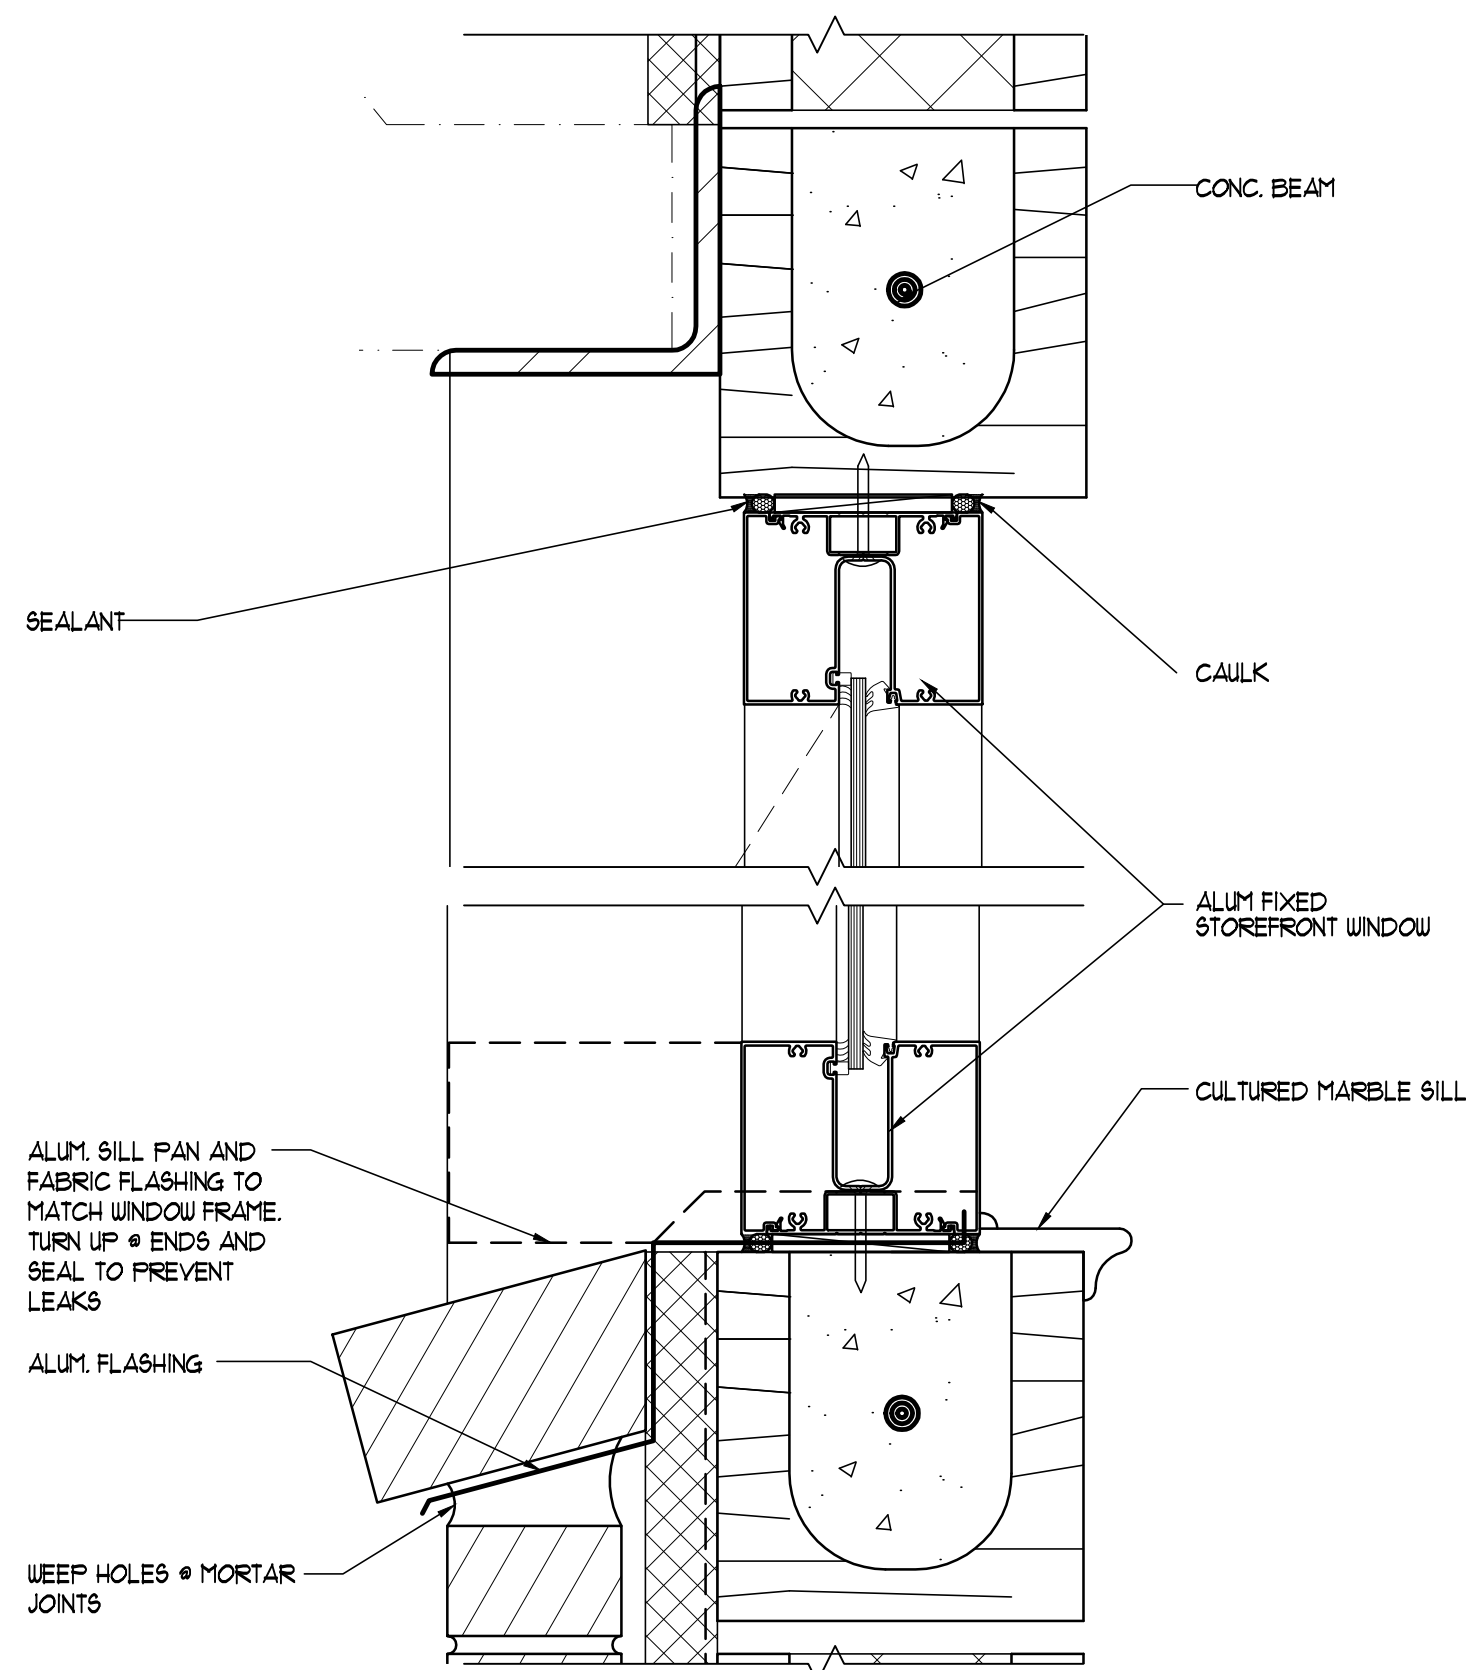


5 EXTERIOR WINDOW DETAILS  
SCALE: 3/4" = 1'-0"



6 INTERIOR WINDOW DETAILS  
SCALE: 3/4" = 1'-0"

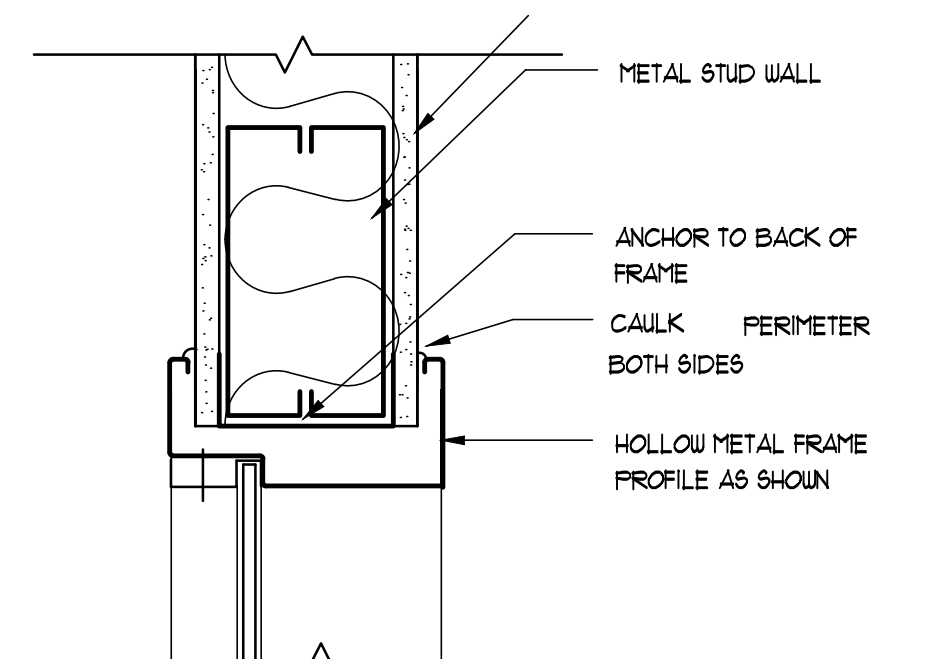


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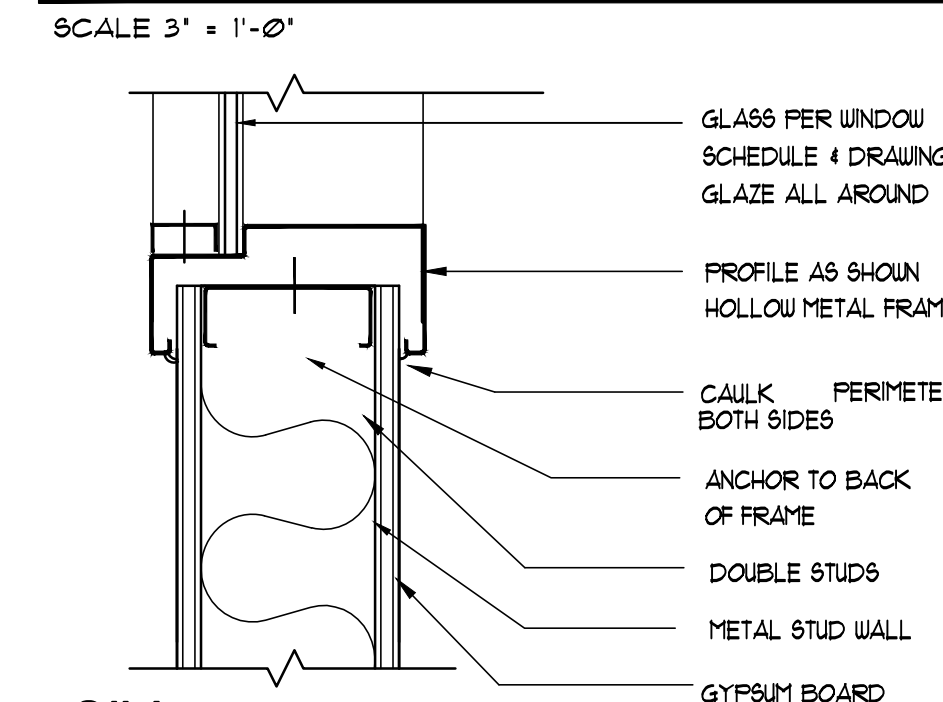


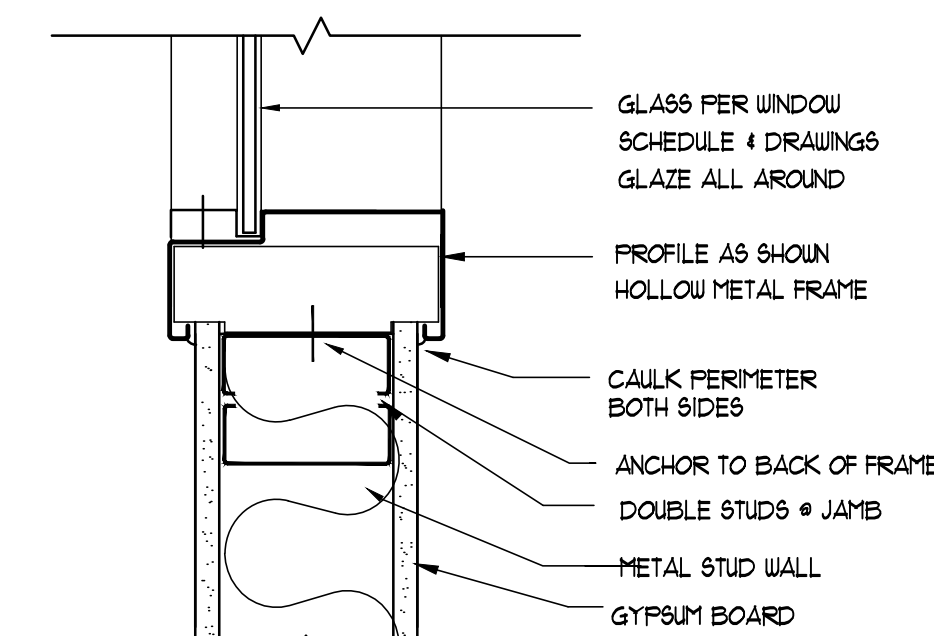SILL / JAMB

7 RATED WINDOW DETAILS  
SCALE: 3/4" = 1'-0"

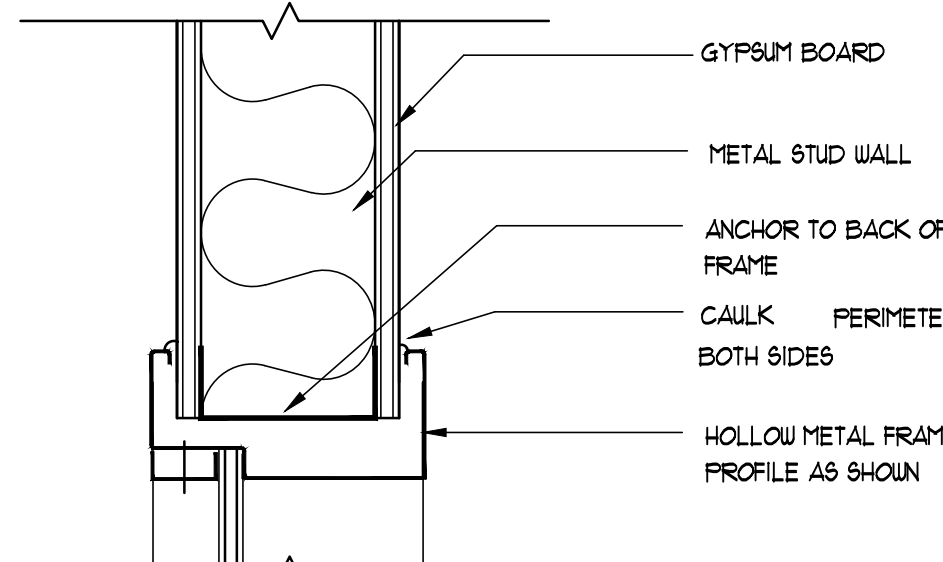

HEAD / JAMB



SILL


8 INTERIOR WINDOW DETAILS  
SCALE: 3/4" = 1'-0"

REVISIONS AND UPDATES

02/14/14	CONSTRUCTION DOCUMENTS FOR BID/PERMIT	

SUWANNEE COUNTY SCHOOL BOARD  
SUWANNEE PRIMARY SCHOOL  
ADDITIONS AND REMODELING  
1625 WALKER AVE., SW LIVE OAK, FLORIDA  
DOOR AND WINDOWS DETAILS

drawn 02/18/14 CNK checked 02/16/14 JCZ approved JCZ

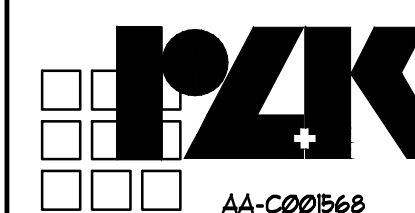


JOHN C. ZWICK, R.A.  
FL. REG. AR0009521

Job no. 20031


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ARCHITECTS RZK, INC.  
800 FLORIDA AVENUE SUITE 202 COCOA, FLORIDA 32922 TELEPHONE (321) 631-8030




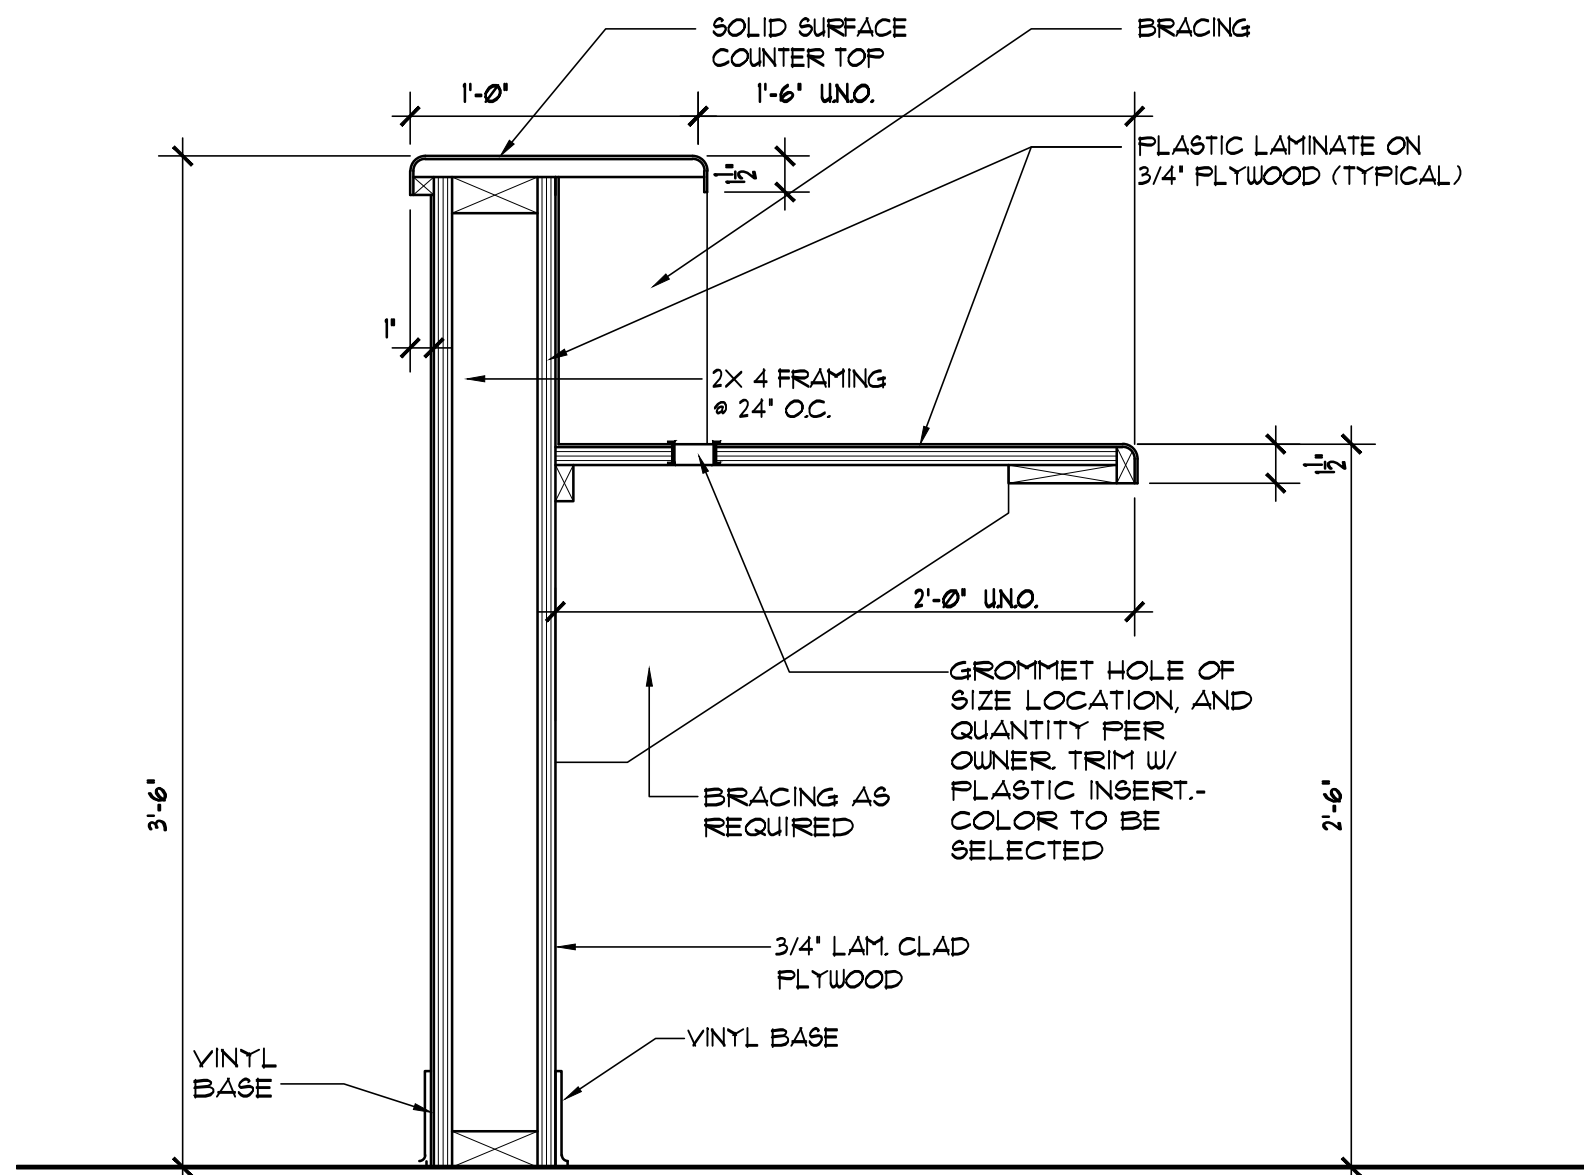


1 RECEPTIN DESK  
SCALE: 1-1/2" = 1'-0"

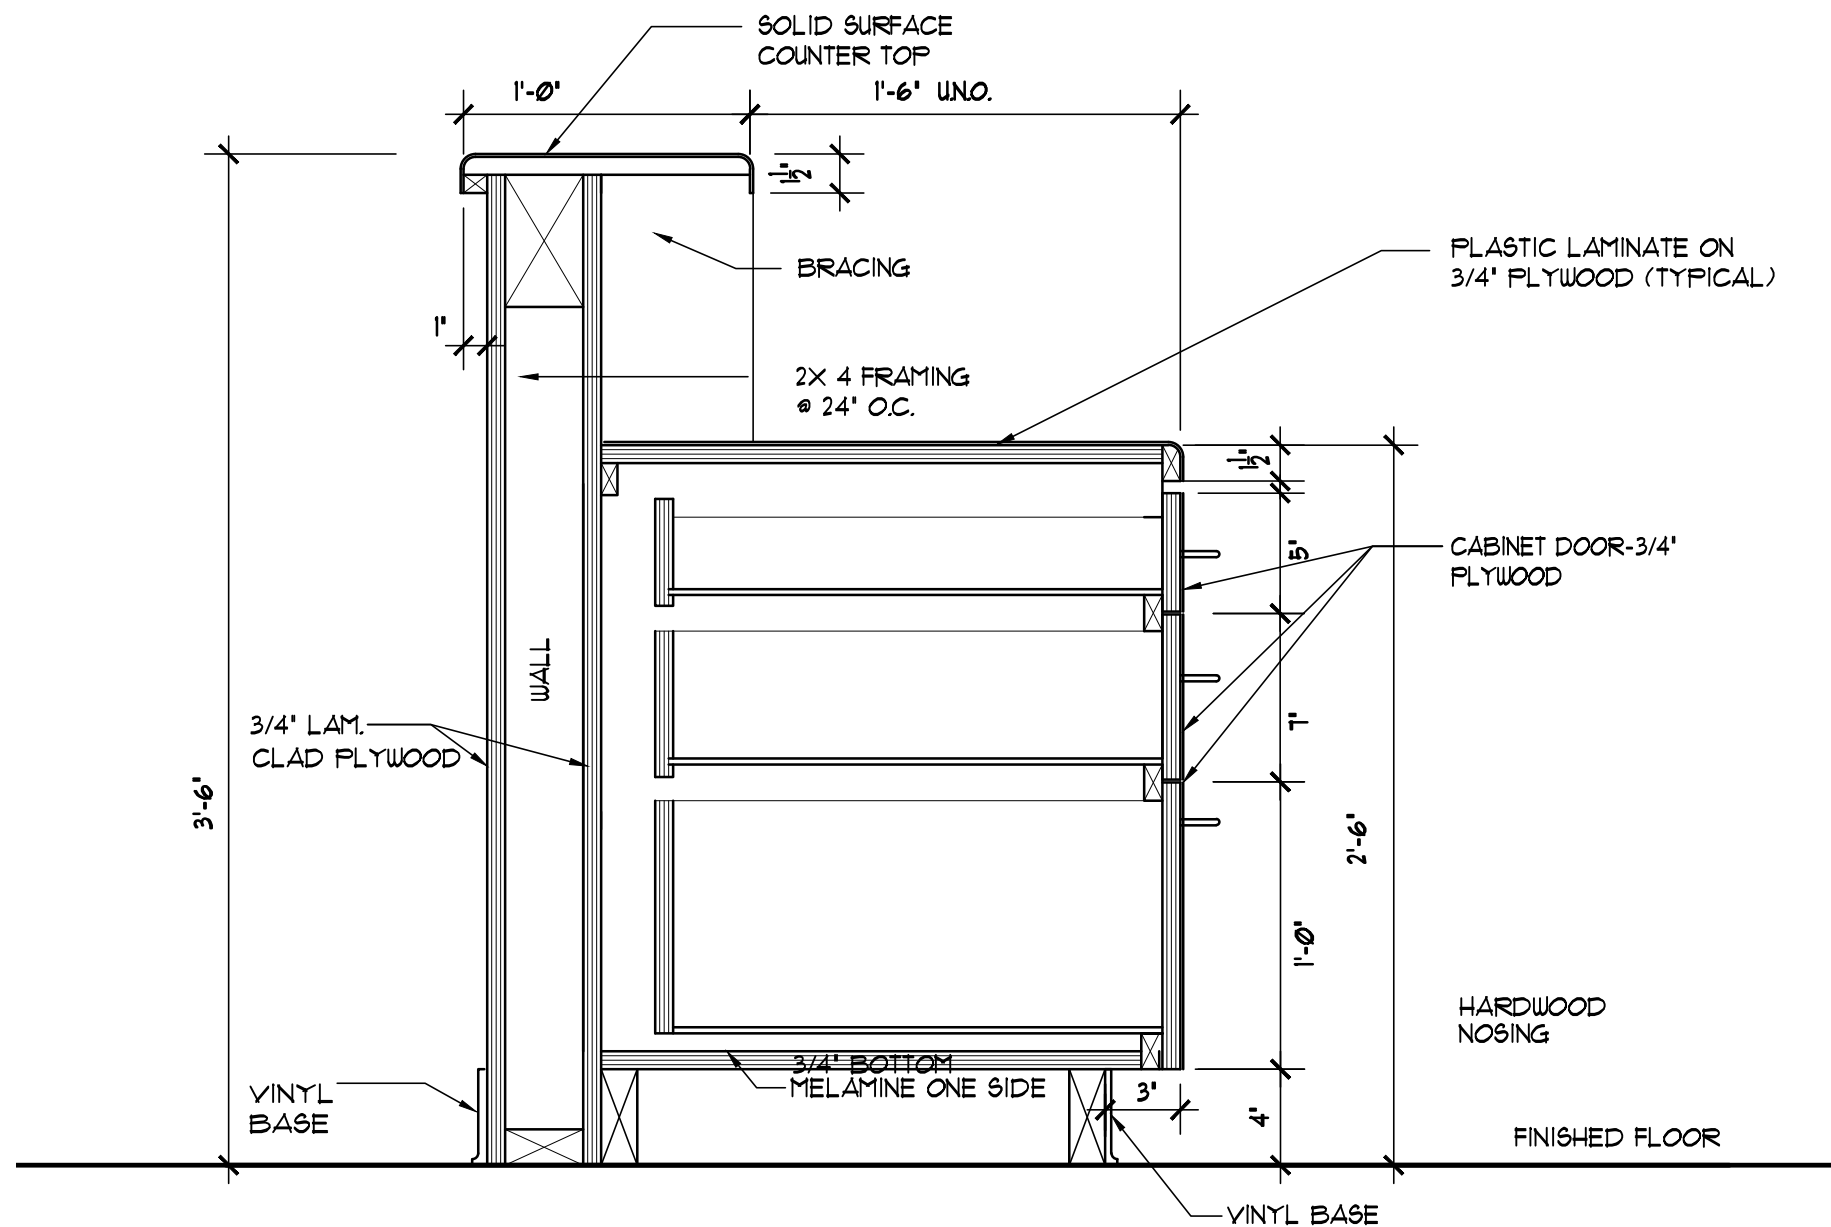


2 RECEPTIN DESK W/ DRAWERS  
SCALE: 1-1/2" = 1'-0"

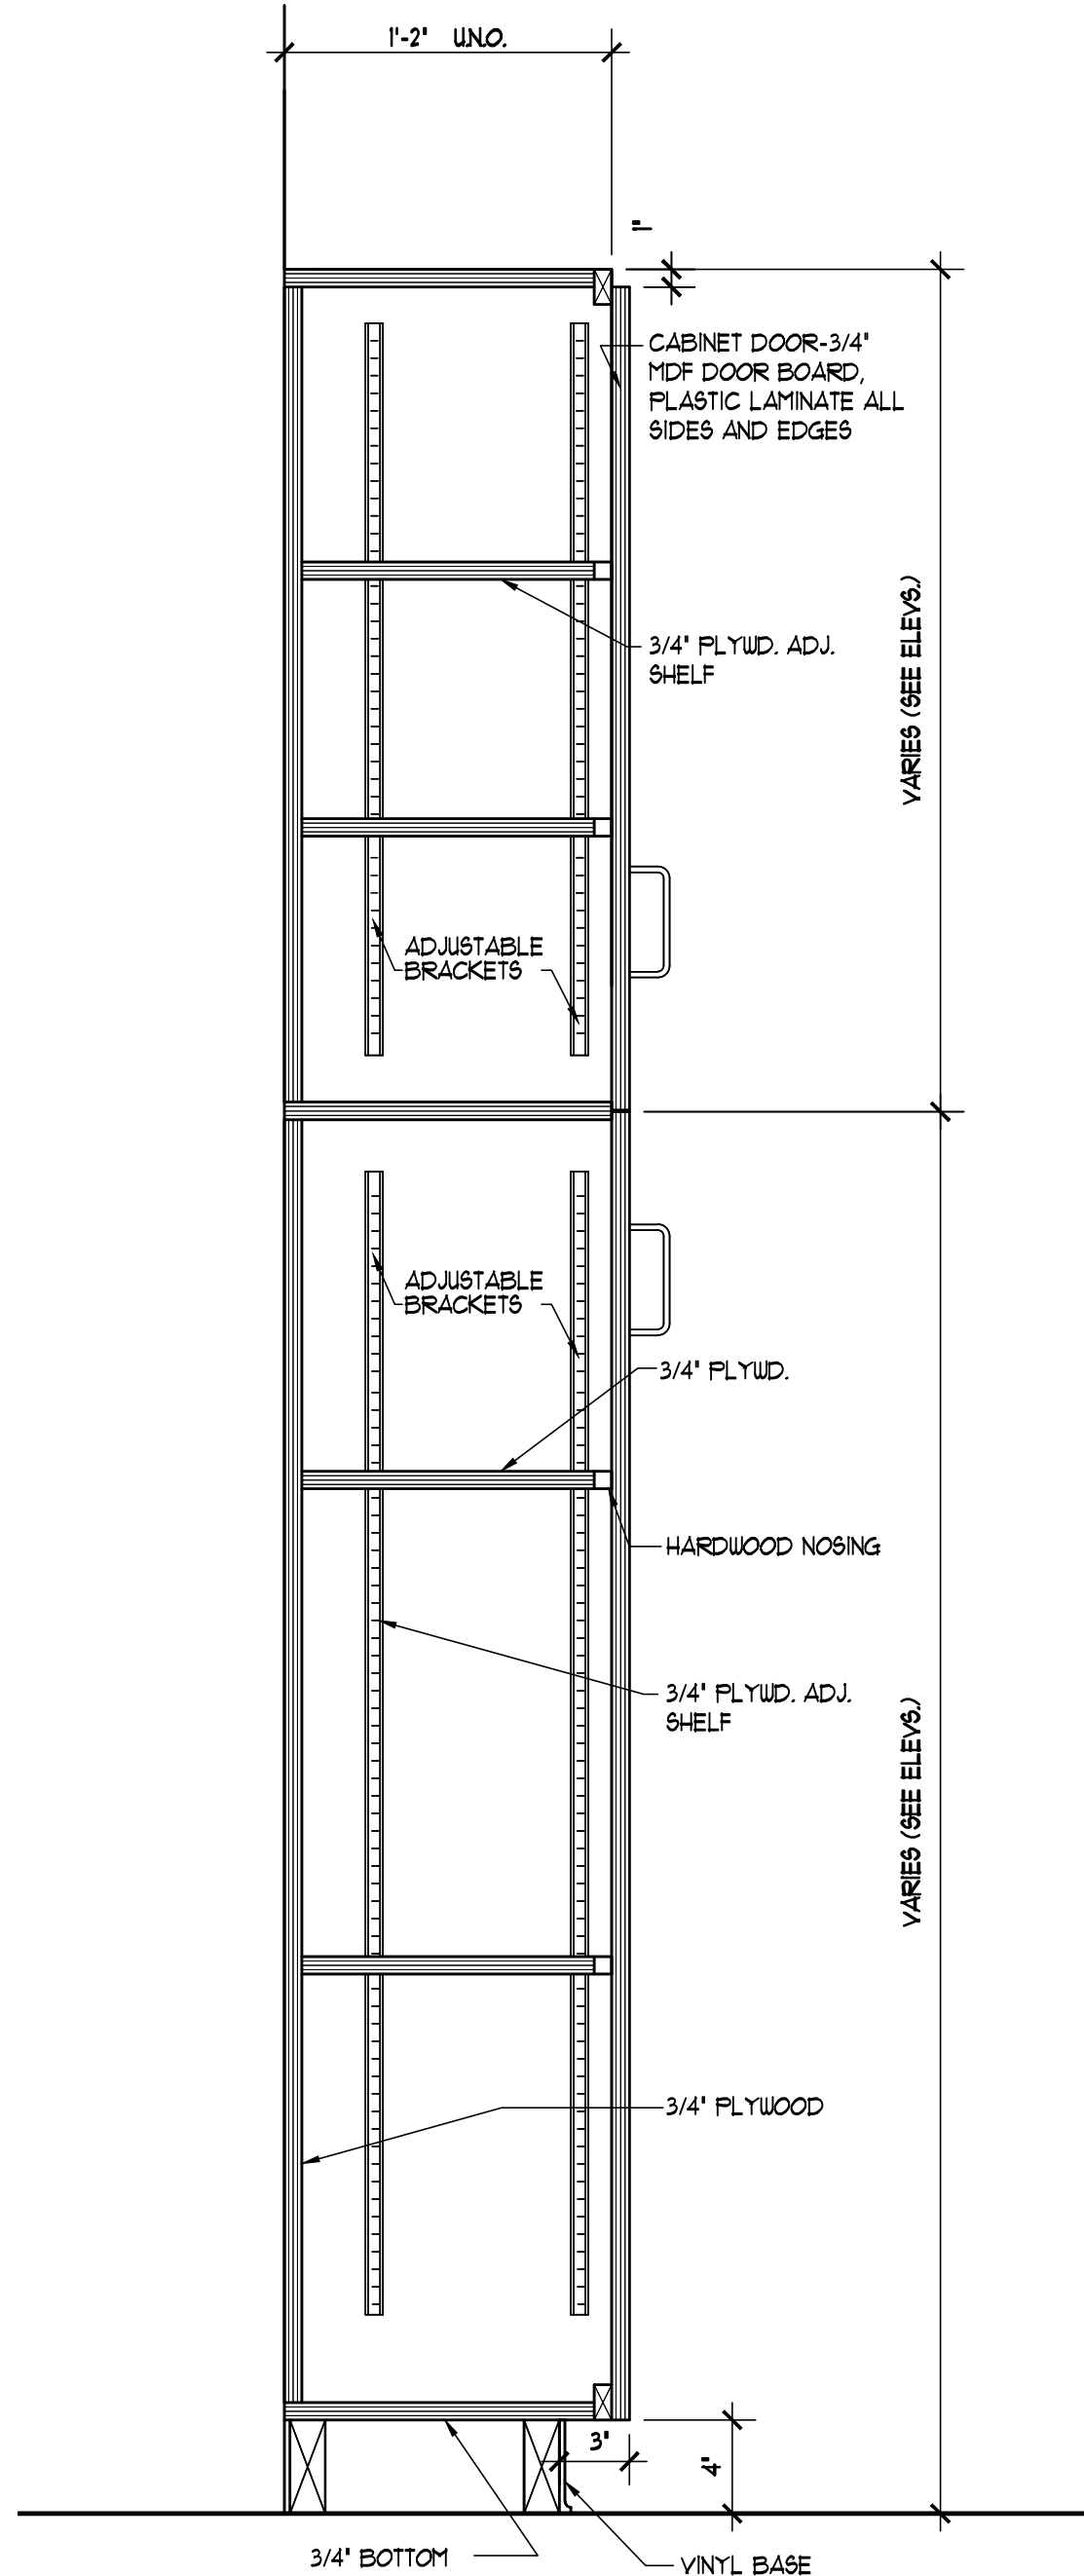


6 STACKED CABINETY  
SCALE: 1-1/2" = 1'-0"

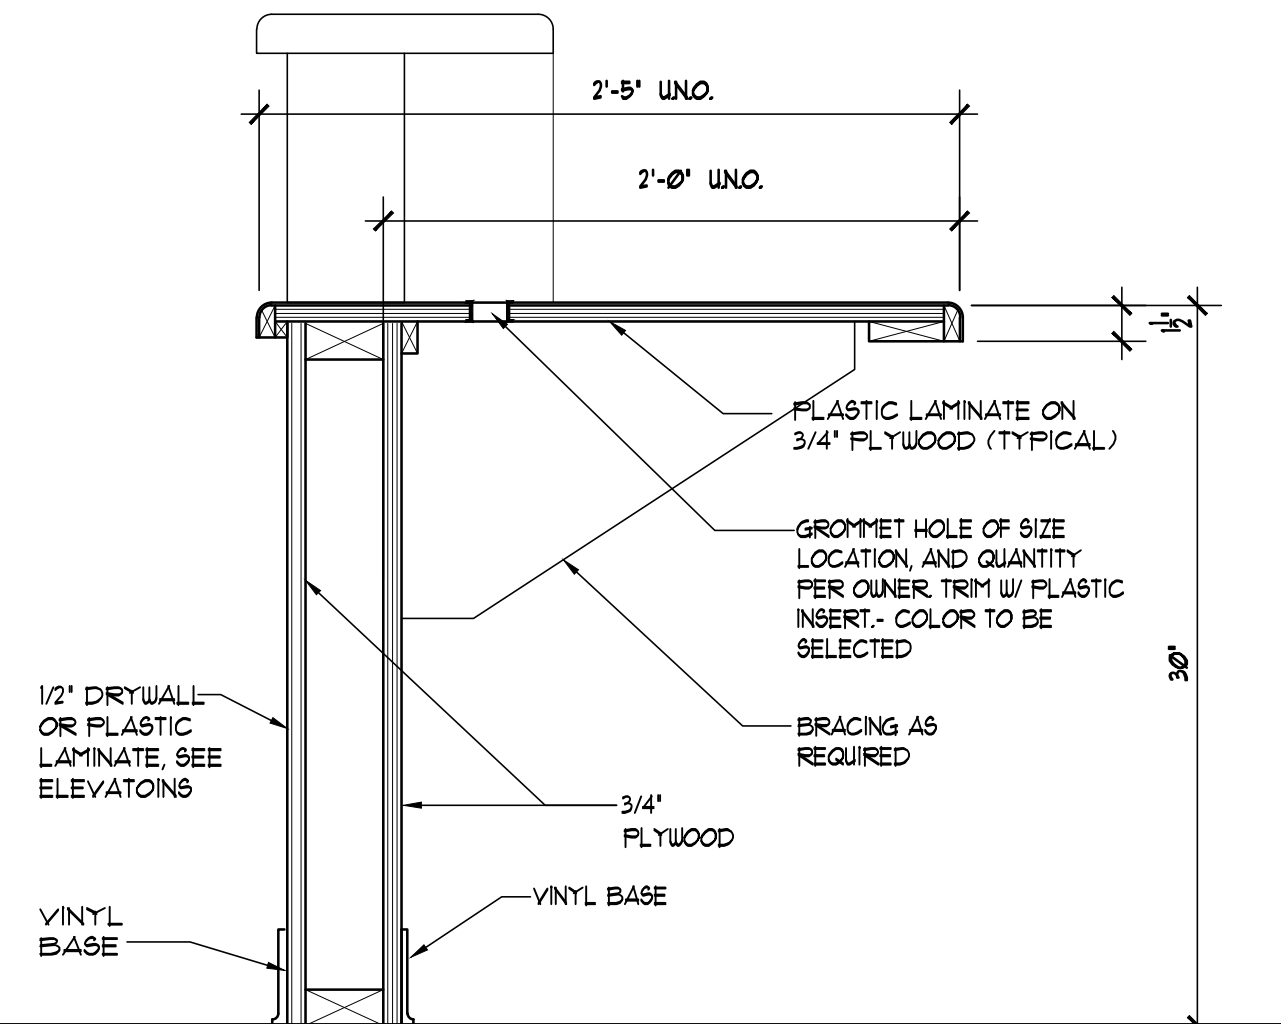


3 RECEPTIN DESK  
SCALE: 1-1/2" = 1'-0"

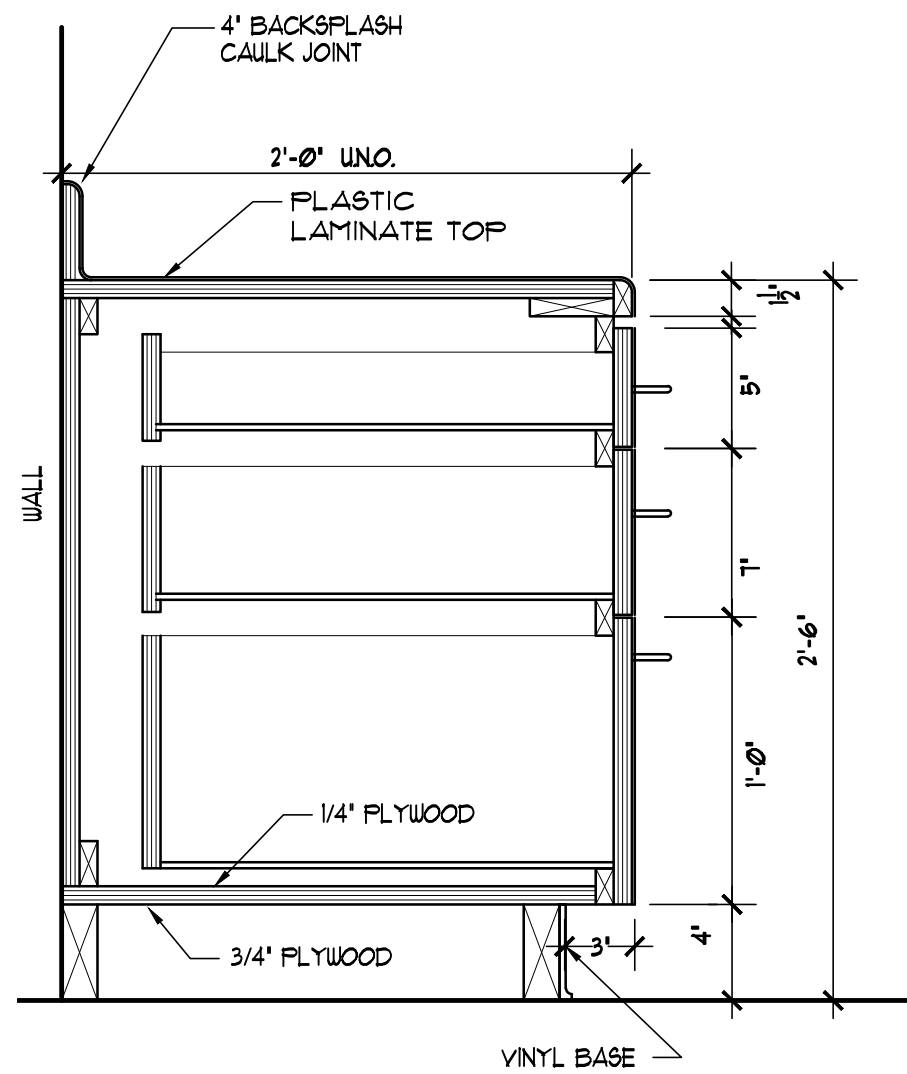

4 RECEPTIN DESK  
SCALE: 1-1/2" = 1'-0"

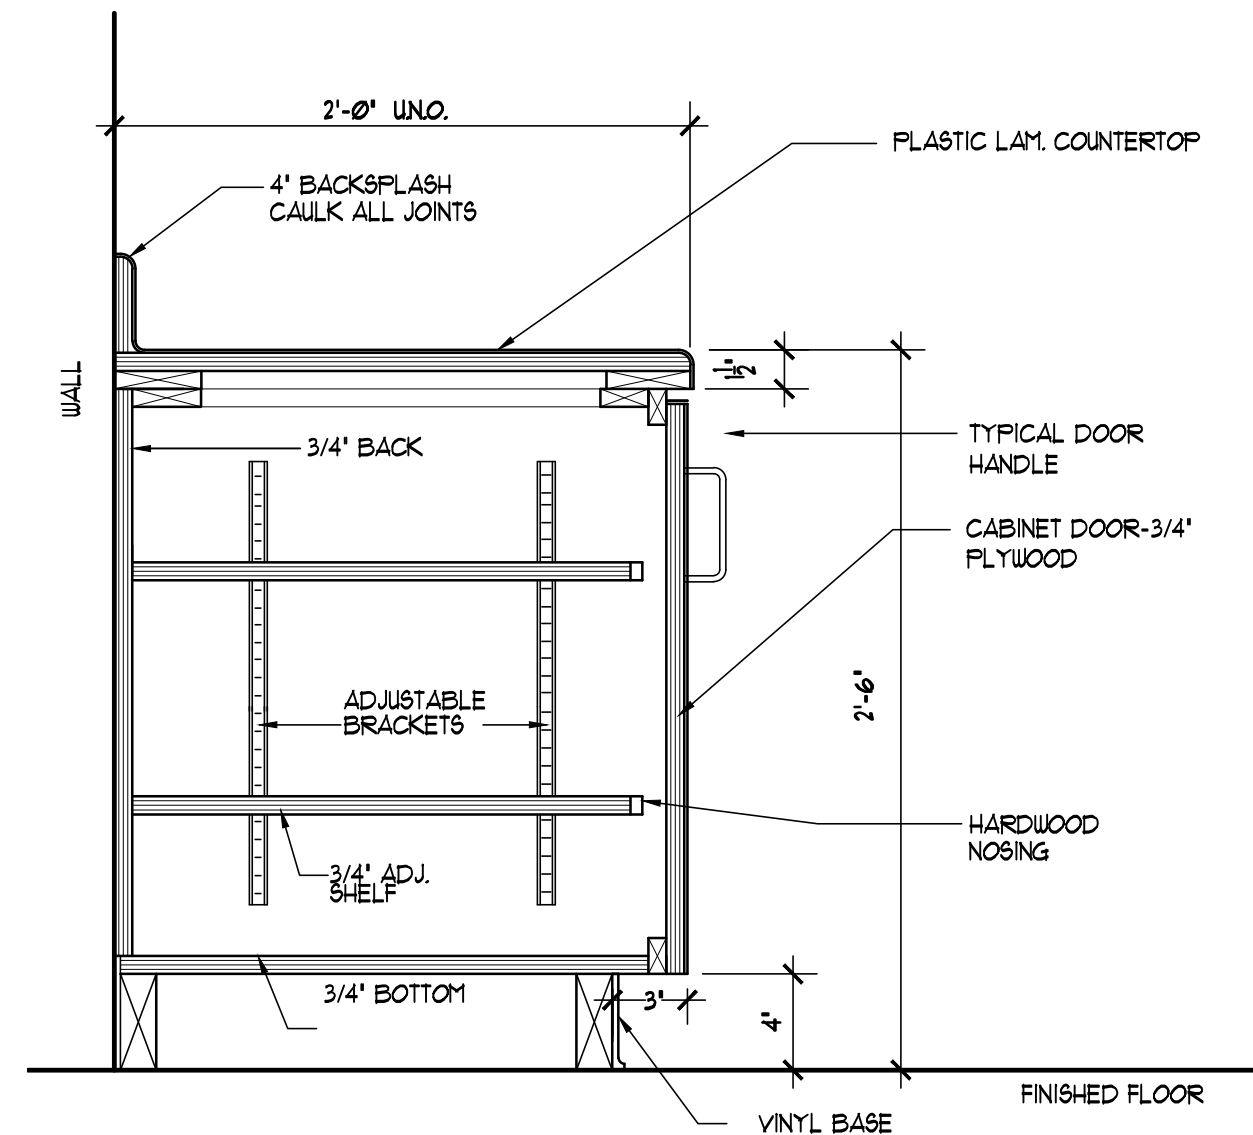

5 RECEPTIN DESK  
SCALE: 1-1/2" = 1'-0"

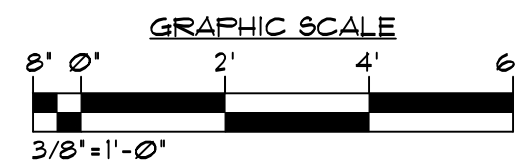

## GENERAL CABINETRY NOTES


- CONTRACTOR TO SUBMIT SHOP DRAWINGS TO INCLUDE ATTACHMENT DETAILS VERIFYING CABINET ASSEMBLIES WILL BE SECURED PER FBC STANDARDS. SECURING AND ATTACHMENT METHODS WILL BE REVIEWED AND APPROVED BY ARCHITECT/ENGINEER.
- PLUMBING AND CASEWORK CONTRACTOR TO COORDINATE SINK LOCATION CONNECTION AND CUT-OUT.
- SEE INTERIOR ELEVATIONS FOR CABINETRY HEIGHT AND PLUMBING SPECIFICATIONS FOR SINK TYPE.
- SEE SPECIFICATIONS FOR ALL DOOR AND DRAWER HARDWARE.
- P.T. PLYWOOD OR SHEET METAL SHALL BE INSTALLED BEHIND ALL MOUNTED FIXTURES, CABINETRY, PARTITIONS ETC. FOR SUPPORT. ANCHOR UNIT SECURELY TO WALL ON CONCEALED IN-WALL BACK BRACING.
- CASEWORK TO BE FRAMELESS CABINETS. DISCARD DETAILS THAT SHOW FACE FRAME CONSTRUCTION.
- CASE WORK TO HAVE PLASTIC LAMINATE ON THE EXTERIOR SURFACES, MELAMINE ON THE INTERIOR SURFACES AND NO EXPOSED FASTENERS.

## REVISIONS AND UPDATES

02/14/14		CONSTRUCTION DOCUMENTS FOR BID/PERMIT

SUWANNEE COUNTY SCHOOL BOARD  
SUWANNEE PRIMARY SCHOOL  
ADDITIONS AND REMODELING  
1625 WALKER AVE. SW LIVE OAK, FLORIDA  
CABINETRY DETAILS

drawn 02/18/14 CNK checked 02/16/14 JCZ approved JCZ

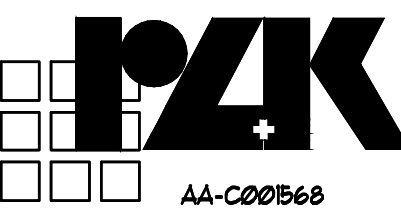


JOHN C. ZWICK, R.A.  
FL. REG. AR20095271

Job no. 200351


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ARCHITECTS RZK, INC.  
800 FLORIDA AVENUE SUITE 202 COCOA, FLORIDA 32922 TELEPHONE (321) 631-8030

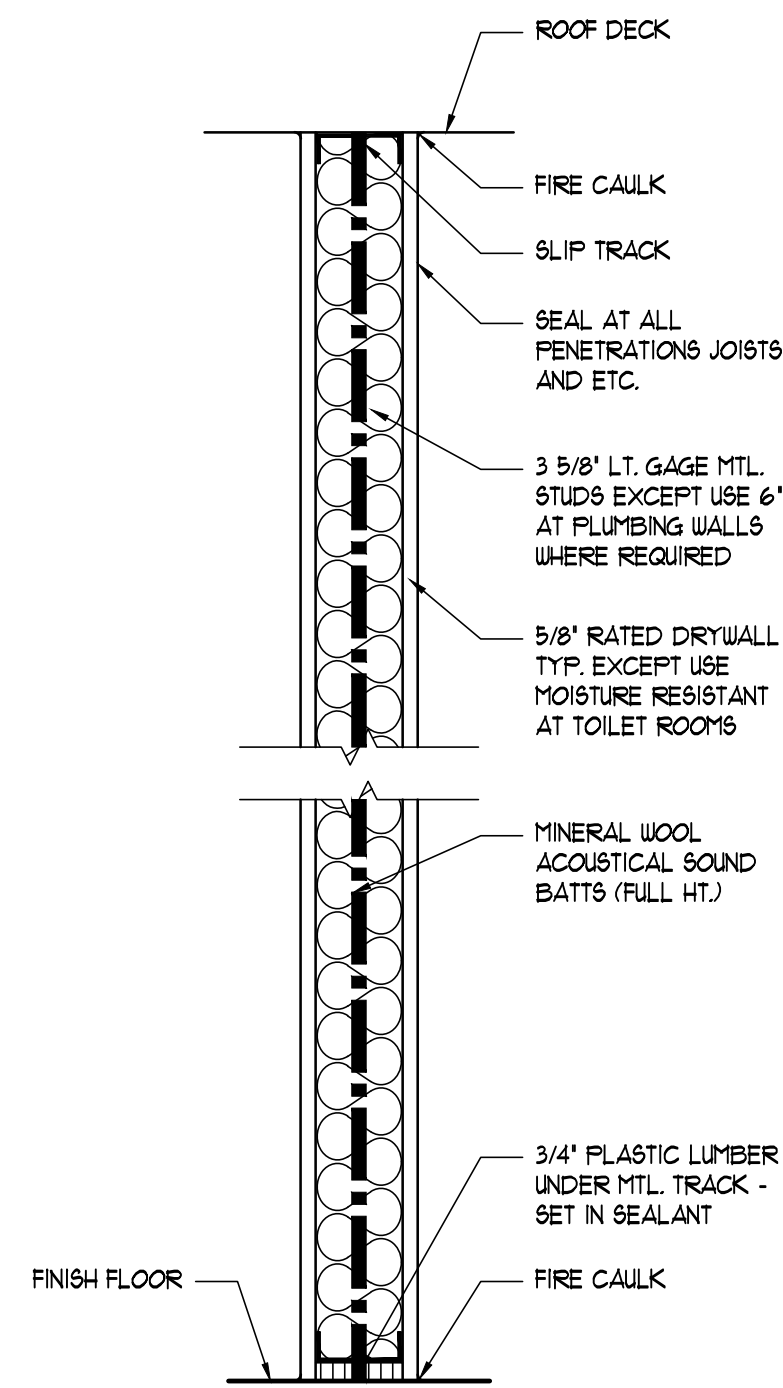


**WALL TYPE**

SCALE 1 1/2" = 1'-0"

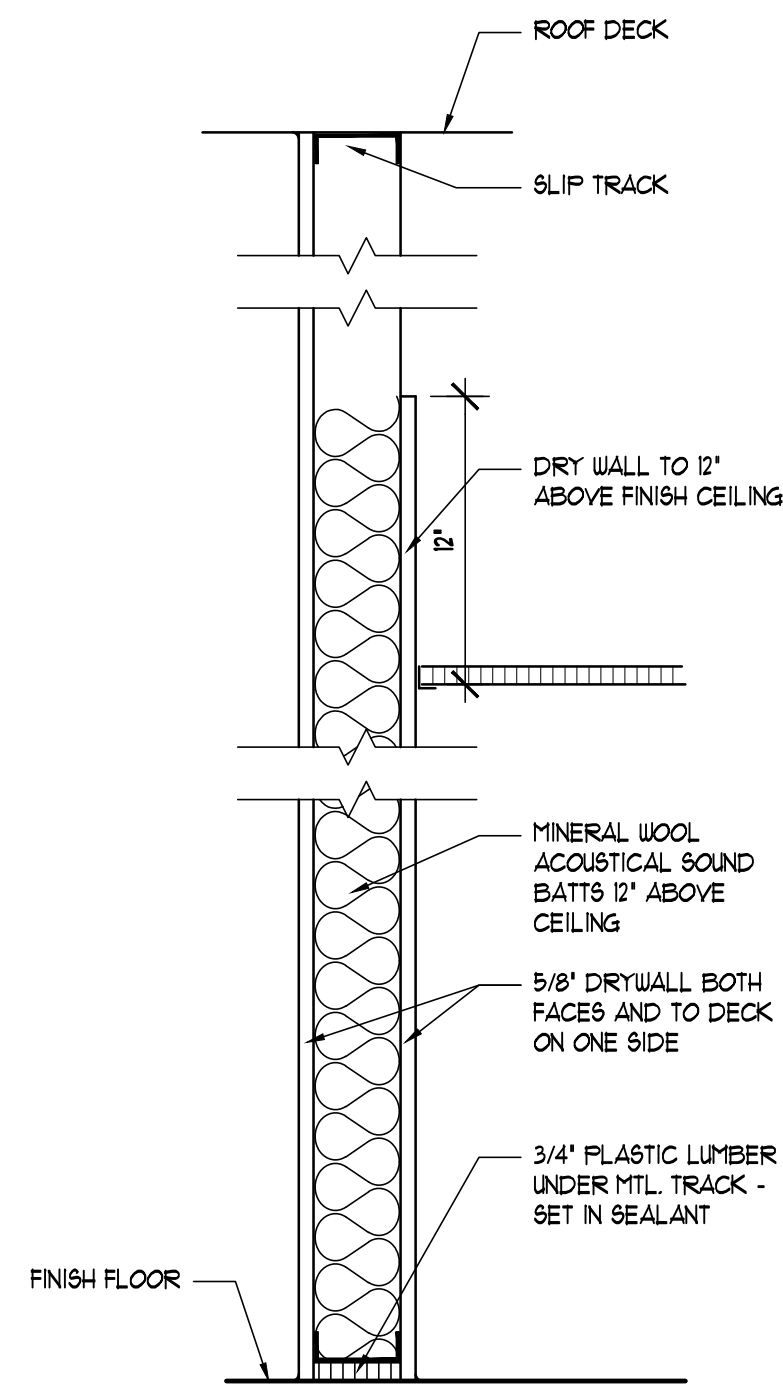


**WALL TYPE**

SCALE 1 1/2" = 1'-0"

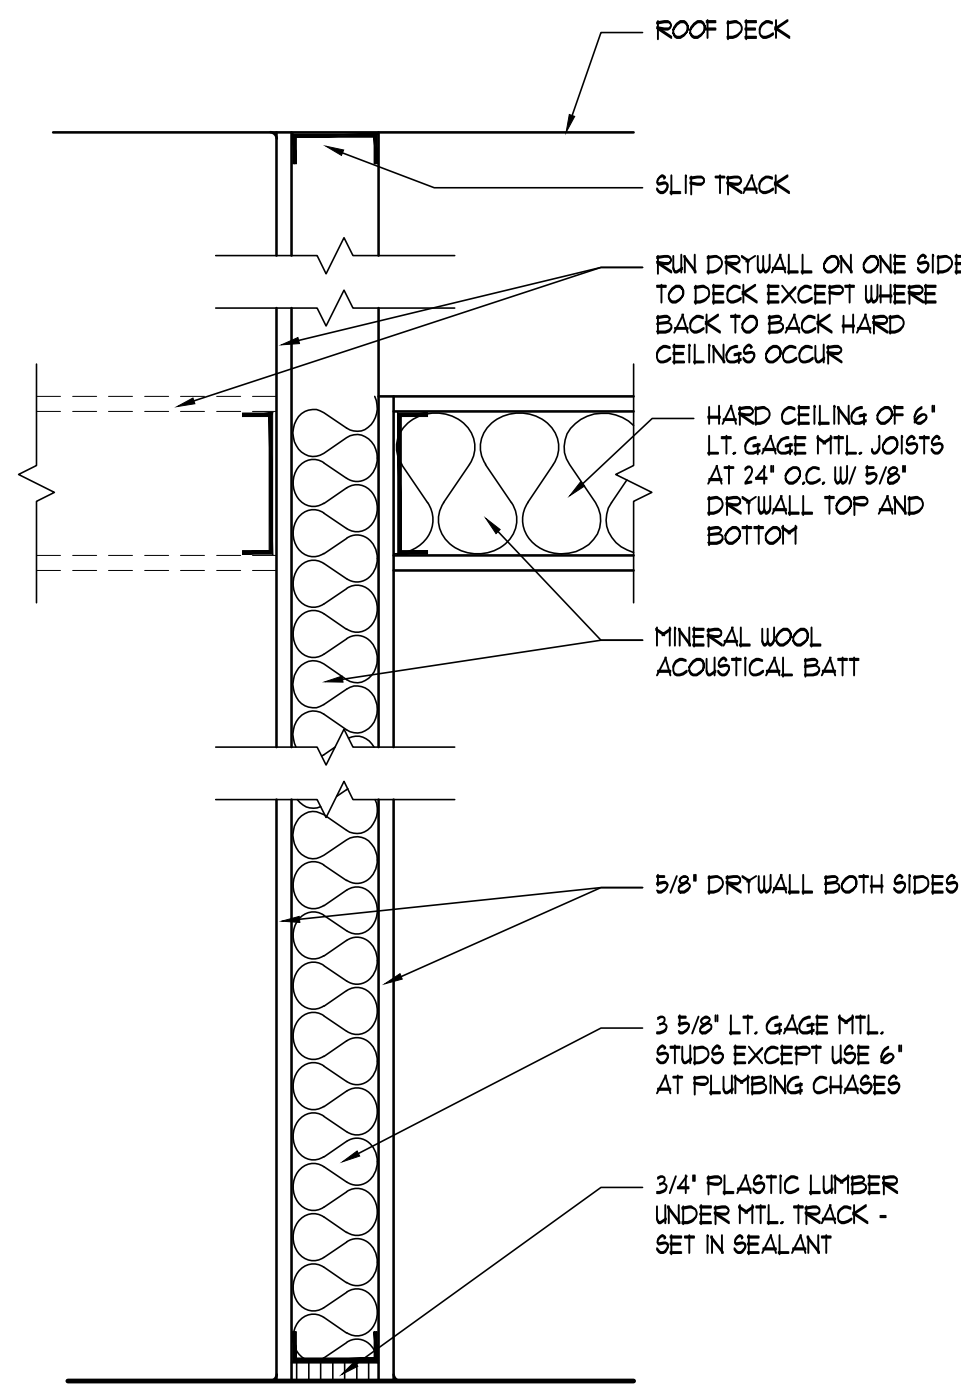


**WALL TYPE**

SCALE 1 1/2" = 1'-0"

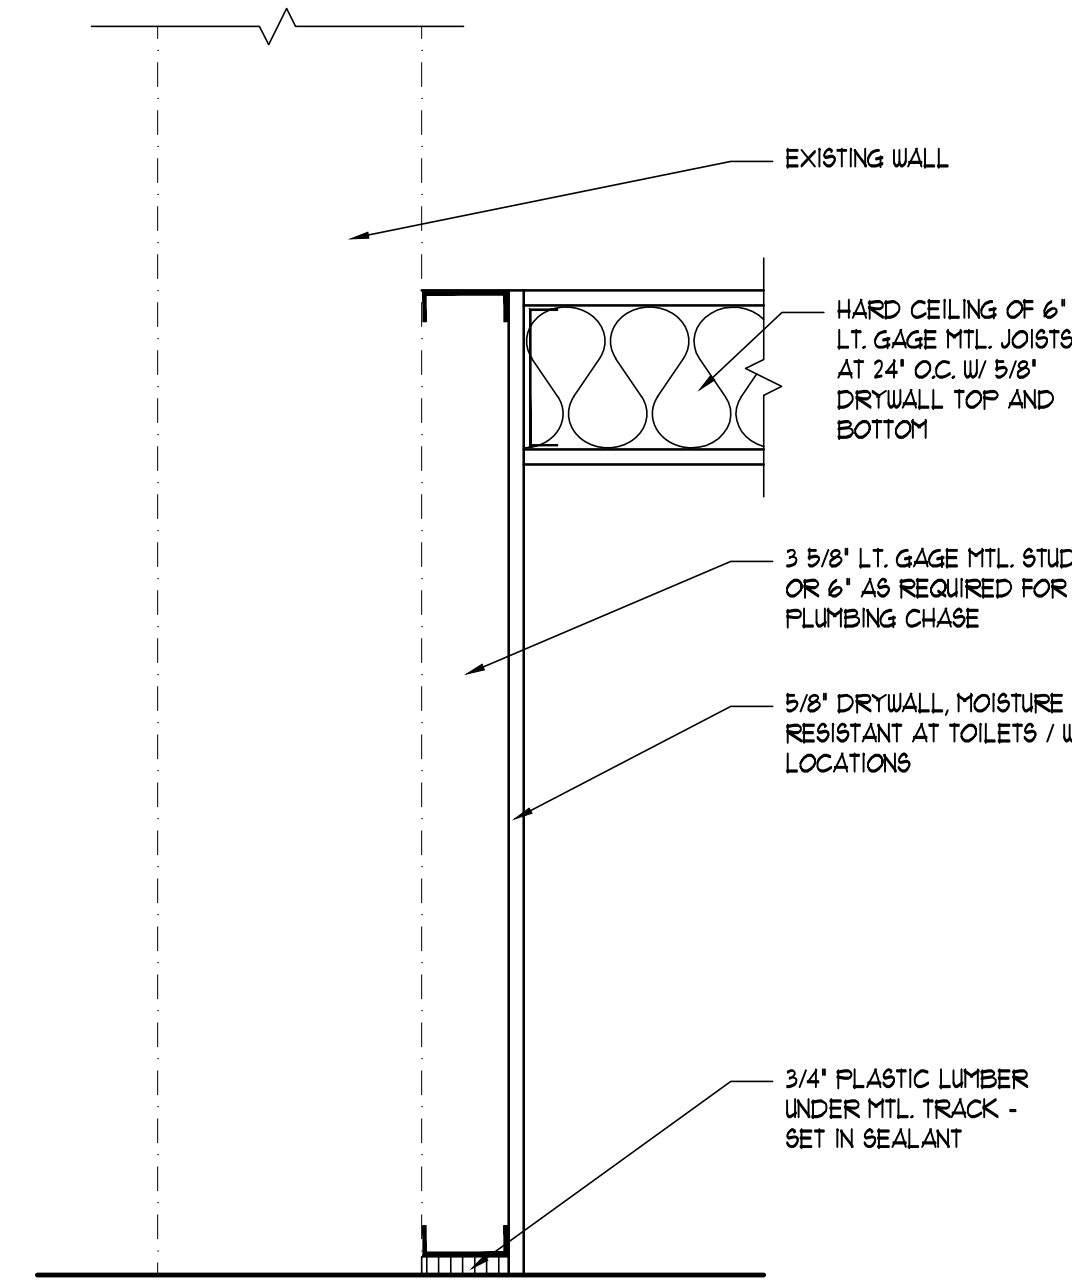


**WALL TYPE**

SCALE 1 1/2" = 1'-0"

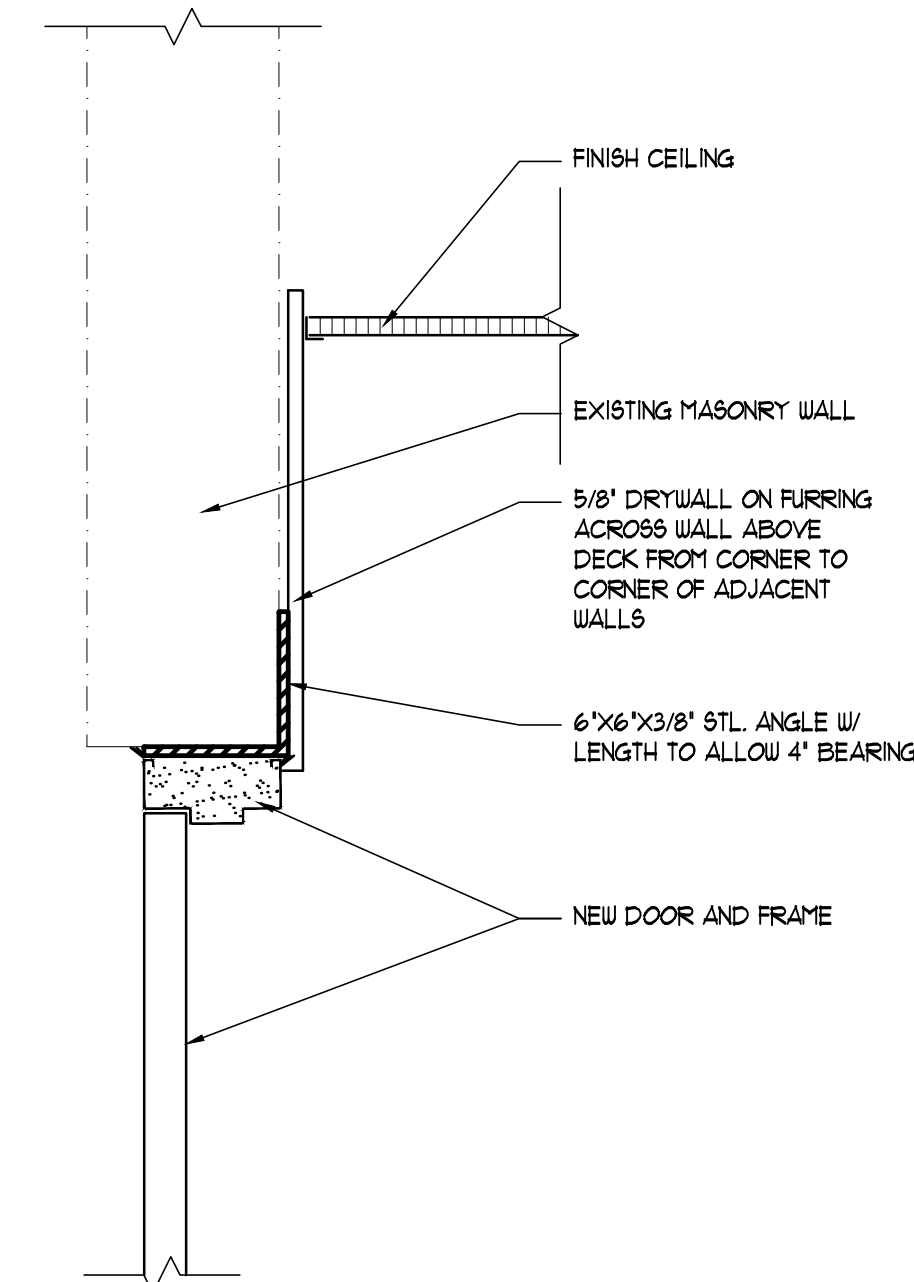


**WALL TYPE**

SCALE 1 1/2" = 1'-0"

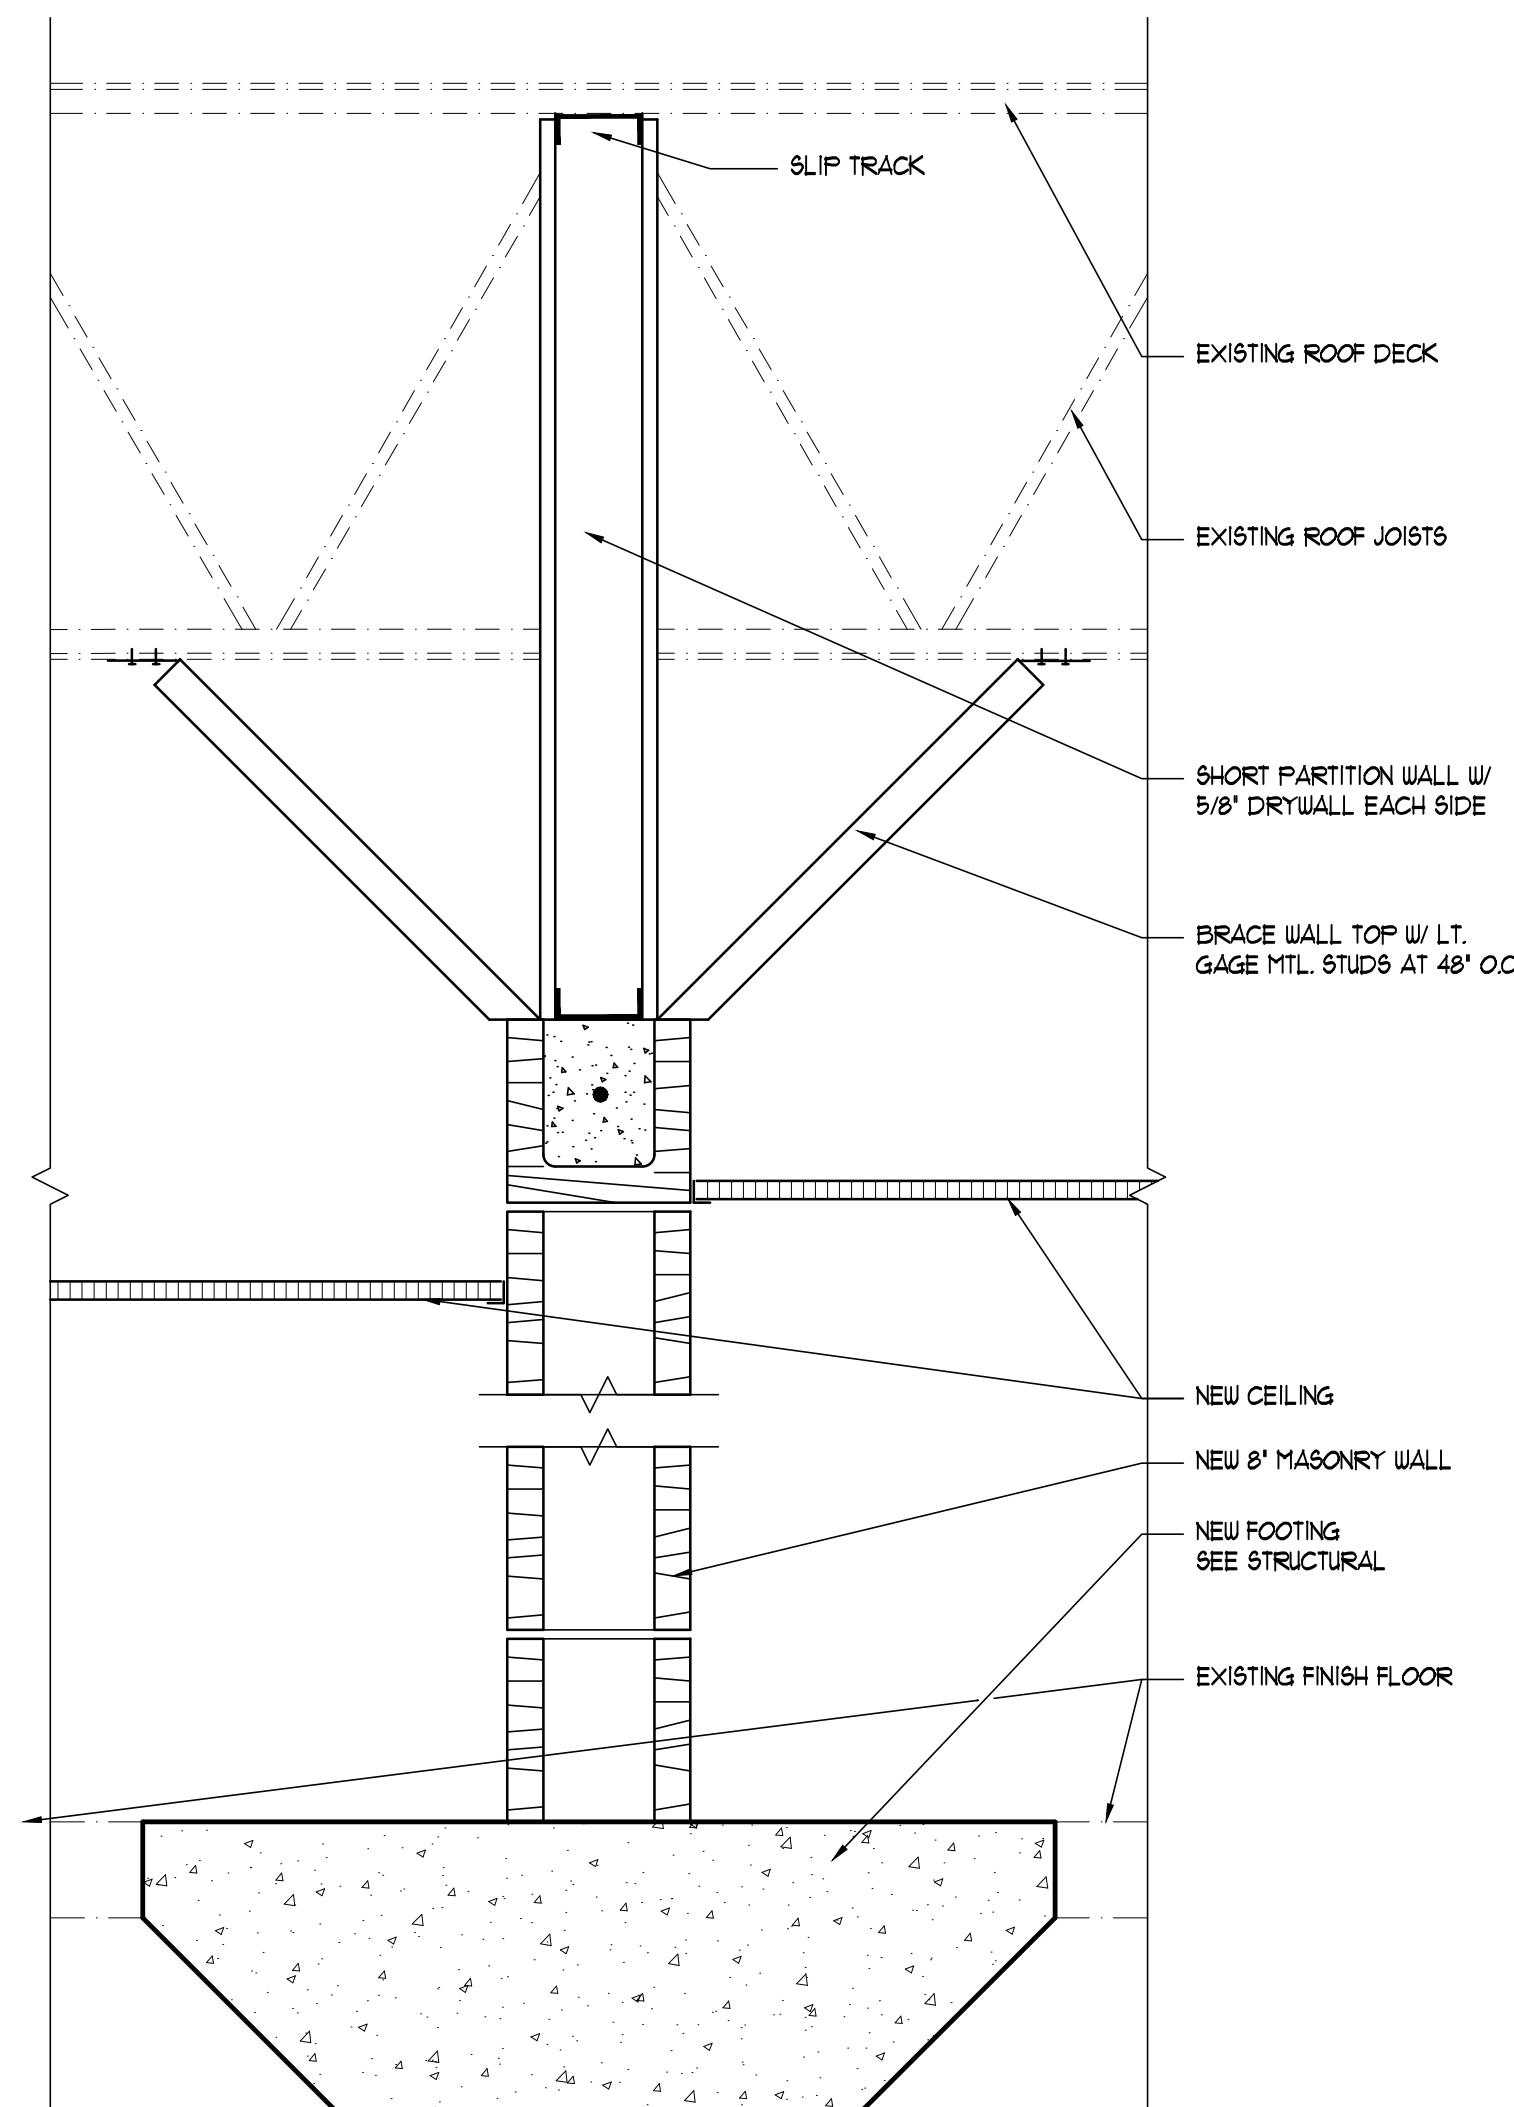


**WALL TYPE**

SCALE 1 1/2" = 1'-0"

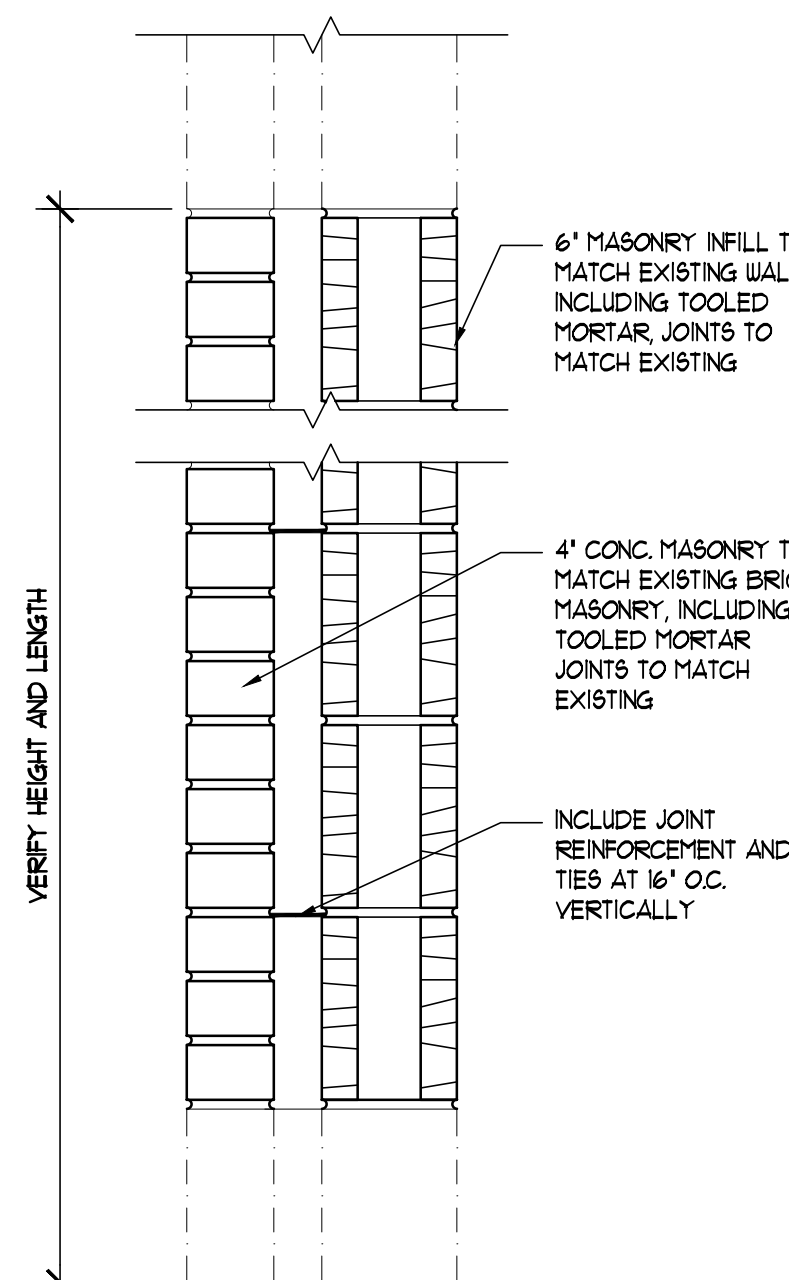


**WALL TYPE**

SCALE 1 1/2" = 1'-0"

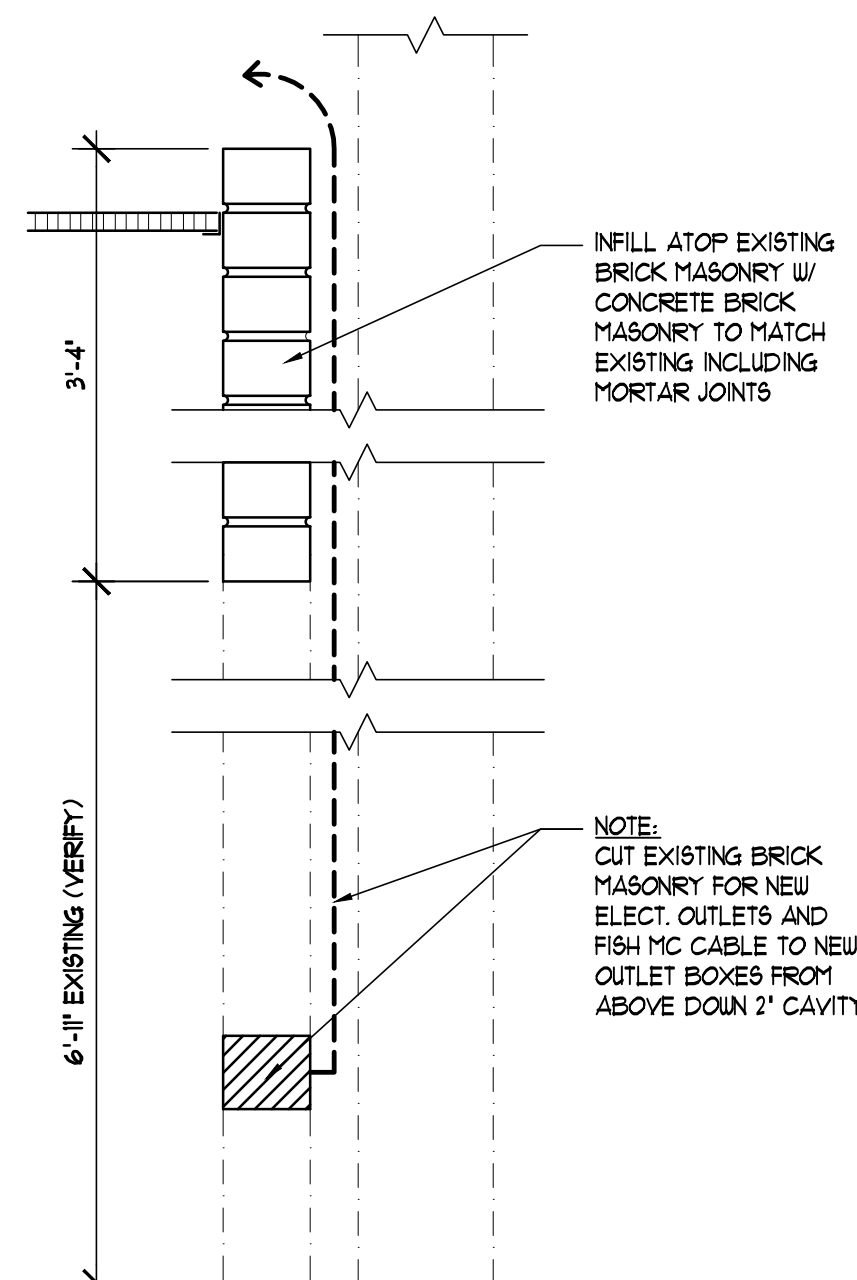

**WALL TYPE**

SCALE 1 1/2" = 1'-0"

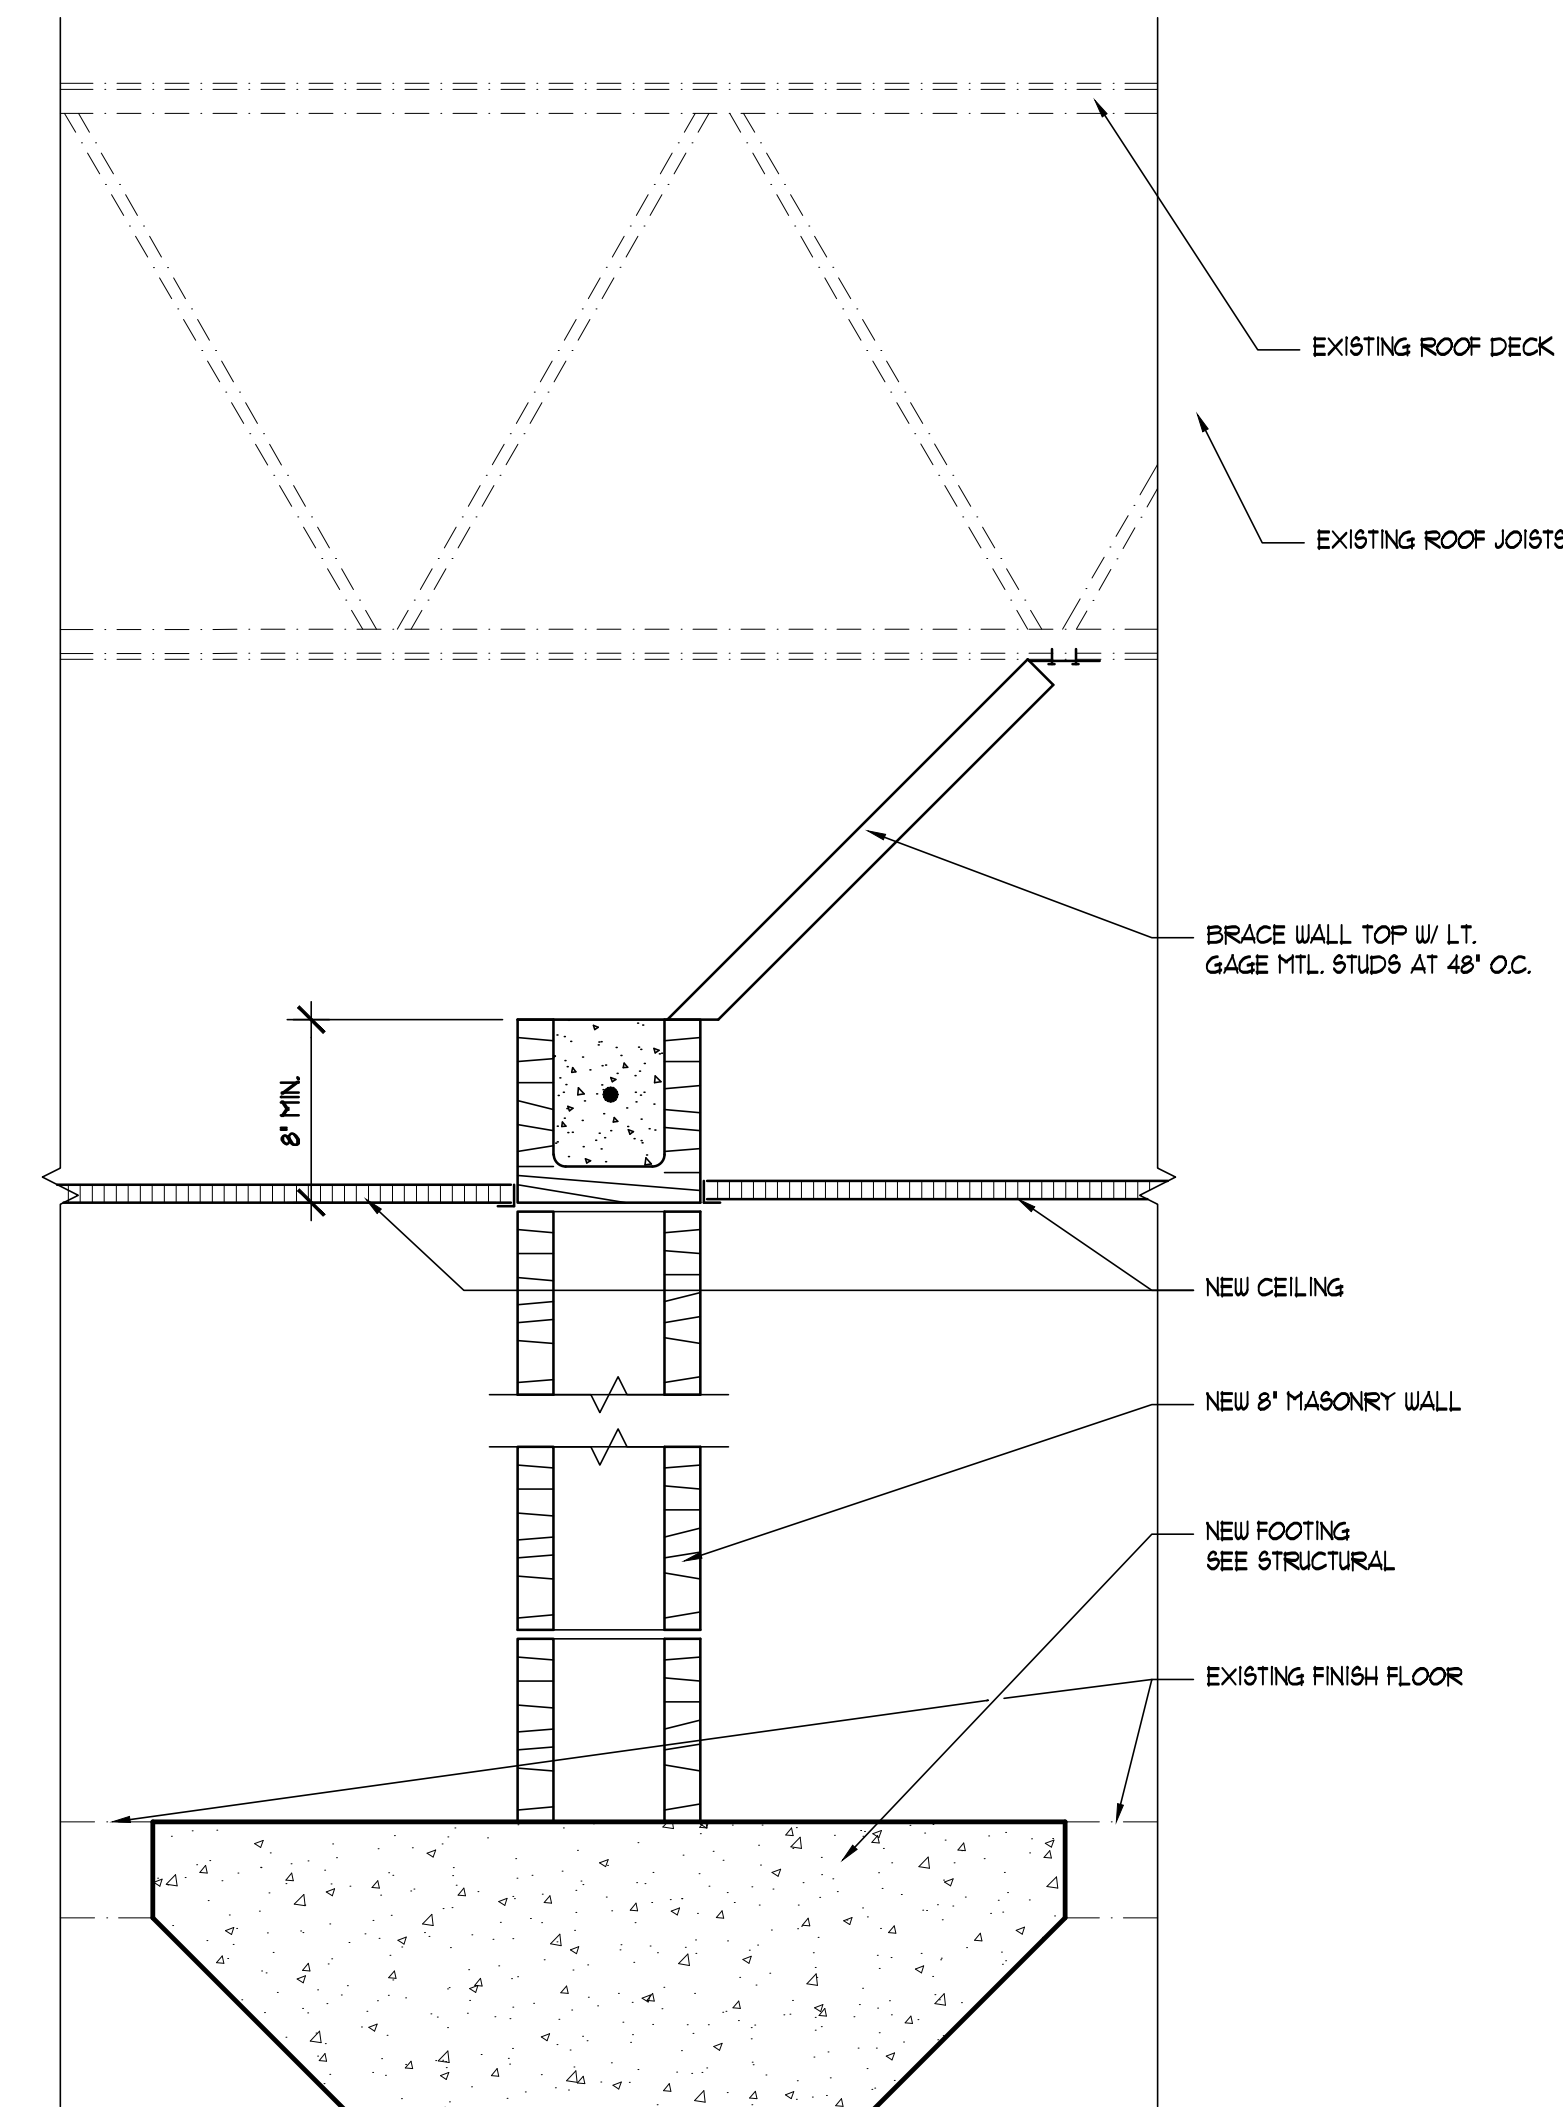

**WALL TYPE**

SCALE 1 1/2" = 1'-0"

**REVISIONS AND UPDATES**

02/14/14	CONSTRUCTION DOCUMENTS FOR BID/PERMIT	

SUWANNEE COUNTY SCHOOL BOARD  
SUWANNEE PRIMARY SCHOOL  
ADDITIONS AND REMODELING  
1625 WALKER AVE., SW LIVE OAK, FLORIDA

**WALL TYPES**

drawn 02/18/14 CNK checked 02/16/14 JCZ approved JCZ

ARCHITECTS RZK, INC.  
800 FLORIDA AVENUE SUITE 202 COCOA, FLORIDA 32922 TELEPHONE (321) 631-8039

JOHN C. ZWICK, R.A.  
FL. REG. AR0009521

Job no. 20051  
A-10.0

ABBREVIATION	LB	POUND
AMERICAN CONCRETE INSTITUTE	LGTH	LENGTH
ADDITIVE	LL	LIVE LOAD
ADDITIONAL	LLH	LONG LEG HORIZONTAL
ABOVE FINISHED FLOOR	LLV	LONG LEG VERTICAL
AMERICAN INSTITUTE OF STEEL CONSTRUCTION	LONG.	LONGITUDINAL
AMERICAN IRON AND STEEL INSTITUTE	LSL	LAMINATED STRAND LUMBER
ALTERNATE/ALTERNATIVE	LT WT	LONG WEIGHT
ALUMINUM	LVL	LAMINATED VENEER LUMBER
ARCHITECTURE/ARCHITECTURAL		
AMERICAN SOCIETY OF TESTING MATERIALS	MATL	MATERIAL
AMERICAN WELDING SOCIETY	MAX	MAXIMUM
	MB	MASONRY BEAM
	MC	MISCELLANEOUS CHANNEL/MASONRY COLUMN
BOTTOM OF	MECH	MECHANICAL
BOTTOM CHORD EXTENSION	MET	METAL
BUILDING	MFR	MANUFACTURE/MANUFACTURER
BLOCK	MID	MIDDLE
BEAM	MIN	MINIMUM
BOTTOM	MISC	MISCELLANEOUS
BASE PLATE/BEARING PLATE	MO	MASONRY OPENING
BEDDING	MPH	MILES PER HOUR
BETWEEN		
CHANNEL	NGVD	NATIONAL GEODETIC VERTICAL DATUM
CONCRETE BEAM	NIC	NOT IN CONTRACT
CONCRETE COLUMN	NO	NUMBER
CUBIC FEET (FOOT)	NS	NEAR SIDE
CAST IN PLACE	NTS	NOT TO SCALE
CONTRACTION JOINT		
CENTERLINE	OC	ON CENTERS
CLEAR/CLEARANCE	OD	OUTSIDE DIAMETER
CONCRETE MASONRY	O.F.	OUTSIDE FACE
CONCRETE MASONRY UNIT	OPNG	OPENING
COMPANY	OPP	OPPOSITE
COLUMN	OSB	ORIENTED STRAND BOARD
CONCRETE		
CONTINUOUS	P/C	PRECAST CONCRETE/PILE CAP
CONNECTION	P/T	POST TENSIONED
CONSTRUCTION	PAR	PARALLEL
COORDINATE	PCB	PRECAST CONCRETE BEAM
CONSTRUCTION JOINT	PCC	PRECAST CONCRETE COLUMN
CENTER	PCF	POUNDS PER CUBIC FEET
CEMENT	PEMB	PRE-ENGINEERED METAL BUILDING
CUBIC YARD	PEN	PENETRATION
	P.J.	PANEL JOINT CENTERLINE
DEPARTMENT	PL	PLATE
DETAIL	PLF	POUNDS PER LINEAR FOOT
DIAMETER	PLMG	PLUMBING
DIAGONAL	PLY.	PLYWOOD
DIMENSION	PREFAB	PREFABRICATED
DISTANCE	PSF	POUNDS PER SQUARE FOOT
DOWN LOAD	PSI	POUNDS PER SQUARE INCH
DRAWING	PSL	PARALLEL STRAND LUMBER
	PT	PRESSURE TREATED
EACH	R/W	REINFORCED WITH
EACH END	RD	ROOF DRAIN
EACH FACE	REF	REFERENCE
EMERGENCY HURRICANE PROTECTION AREA	REINF	REINFORCING
EXPANSION JOINT	REQD	REQUIRED
ELECTRIC/ELECTICAL	REV	REVISION
ELEVATION	RTU	ROOF TOP UNIT
ENGINEER		
EDGE OF DECK	SB	SOFFIT BEAM
ENGINEER OF RECORD	SCHED	SCHEDULE
EQUAL SPACED	S.F.	SQUARE FEET
EACH SIDE	SF	STRIP FOUNDATION
EACH WAY	SIM	SIMILAR
EXISTING	SPC	SPACE/SPACES
EXPANSION	SPCS	SPECIFICATIONS
EXTERIOR	SQ	SQUARE
	SS	STAINLESS STEEL
FOUNDATION	STD	STANDARD
FLOOR DRAIN	STIFF	STIFFENER
FOUNDATION	STL	STEEL
FINISHED FLOOR	STRUCT	STRUCTURAL
FINISH	SYM	SYMMETRICAL
FINISH GRADE		
FLOOR	T/	TOP OF
FAR SIDE	TB	TIE BEAM
FEET/FOOT	T&B	TOP AND BOTTOM
FOOTING	TCH	TOP CHORD EXTENSION
	TDS	TURN DOWN SLAB
GAGE/GAUGE	TE	THICKENED EDGE
GALVANIZED	TEMP	TEMPERATURE
GRADE BEAM	TENS	TENSION
GENERAL CONTRACTOR	THD	THREADED/THREADED
GENERAL	THK	THICK
GRID LINE	TOL	TOLERANCE
GALVANIZED STEEL	TRANS	TRANSVERSE
	TS	TUBE STEEL
HOT DIPPED	T.S.	THICKENED SLAB
HOT DIPPED GALVANIZED	TWF	THICKENED WALL FOUNDATION
HORIZONTAL	TYP	TYPICAL
HEADED STUD ANCHOR		
HOLLOW STRUCTURAL SECTION	UNO	UNLESS NOTED OTHERWISE
HEIGHT		
MOMENT OF INERTIA	VERT	VERTICAL
INSIDE DIAMETER	VOL	VOLUME
INSIDE FACE		
INCH	W/	WIDE FLANGE SECTION
INTERIOR	W/O	WITH
	WD	WITHOUT
JOIST	WF	WOOD
JOINT	WF	WALL FOOTING
	WP	WATERPROOF
	W.P.	WORKING POINT
KIP (1000 LB)	WS	WELDED STUD
KIPS PER LINEAL FOOT	WT	WEIGHT/STRUCTURAL TEE SECTION
KIPS PER SQUARE INCH	WWF	WELDED WIRE FABRIC
KEYWAY		
	@	AT DESIGNATION
	#	POUNDS / REBAR SIZE NUMBER
	PLUS OR MINUS	
	L	ANGLE
	C.L.	CENTER LINE
	&	AND
	Sx	SECTION MODULUS
	Ix	MOMENT OF INERTIA

	DETAIL NUMBER SHEET NUMBER		SPAN DIRECTION NORTH ARROW
	PLAN / DETAIL MARK		COLUMN GRID LINE
	ELEVATION MARK		CIP CONCRETE COLUMN ABOVE
	RECESS OR STEP IN SLAB		TLT-UP/PRECAST CONCRETE COLUMN ABOVE
	SLOPED SURFACE		CONCRETE COLUMN BELOW
	PITCHED ROOF		METAL DECK
	PLAN NOTE		CONCRETE SLAB ON METAL DECK
	MOMENT CONNECTION		ELEVATED CAST-IN-PLACE CONCRETE SLAB
	JOIST BEARING ELEVATION		PRECAST CONCRETE PLANK
	BOLTED JOIST CONNECTION		ELEVATED CAST-IN-PLACE CONCRETE SLAB
	STEP FOUNDATION		WOOD SHEATHING
	STEPPED FOUNDATION		COMPOSITE BEAM DESIGNATION
	COLUMN AND FOUNDATION TYPE MARKS		COMPOSITE STEEL GIRDER DESIGNATION
	SPOT ELEVATION, TYPICALLY TOP OF ITEM TAGGED (T/WALL, T/FOUNDATION, ETC)		
	PANEL TYPE SEE SCHEDULE		
	WALL TYPE DESIGNATION TAG		
	INCREASED FLOOR LOAD AREA IN PSF		
	WALL TYPES		
	LOAD BEARING MASONRY WALL		
	NON-LOAD BEARING MASONRY WALL		
	TLT-UP/PRECAST CONCRETE WALL		
	CIP CONCRETE WALL		
	STUD WALL		
	NOTE: SYMBOLS AND LEGEND SHOWN ARE GENERIC AND DO NOT NECESSARILY INDICATE ACTUAL OCCURRENCES IN THESE DRAWINGS.		


<b>REVISIONS AND UPDATES</b>	
02/14/14	CONSTRUCTION DOCUMENTS FOR BID/PERMIT

SUWANNEE COUNTY SCHOOL BOARD  
**SUWANNEE PRIMARY SCHOOL**  
**ADDITIONS AND REMODELING**

1625 WALKER AVE., SW LIVE OAK, FLORIDA

**GENERAL NOTES AND DETAILS**

drawn <b>SES</b>	checked <b>GCK</b>	approved <b>GCK</b>
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AA-COO/560

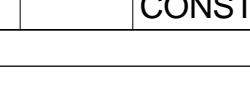job no. 2012.51

**S-0.1**

ARCHITECTS RZK, INC.

600 PARK AVENUE SUITE 202 COCOA, FLORIDA 32922    TELEPHONE (321) 631-8030



1000 GENERAL NOTES:

1. STRUCTURAL DRAWINGS SHALL BE USED IN CONJUNCTION WITH PROJECT SPECIFICATIONS AND ARCHITECTURAL, MECHANICAL, ELECTRICAL, PLUMBING, AND SITE DRAWINGS. CONSULT THESE DRAWINGS FOR OPENINGS, DEPRESSIONS, EQUIPMENT WEIGHTS AND LOCATIONS, EMBEDDED ITEMS AND OTHER DETAILS NOT SHOWN ON STRUCTURAL DRAWINGS.
2. DIMENSIONS AND CONDITIONS MUST BE VERIFIED IN THE FIELD. ANY DISCREPANCIES SHALL BE BROUGHT TO THE ATTENTION OF THE ENGINEER OF RECORD BEFORE PROCEEDING WITH THE AFFECTED PART OF THE WORK.
3. NO STRUCTURAL MEMBER OR COMPONENT SHALL BE CUT, NOTCHED, OR OTHERWISE ALTERED UNLESS APPROVED IN WRITING BY THE ENGINEER OF RECORD. THE CONTRACTOR SHALL BE RESPONSIBLE FOR ANY AND ALL COSTS INCURRED BY THE ENGINEER OF RECORD FOR REVIEW OF ANY SUCH DEVIATIONS.
4. DO NOT SCALE DRAWINGS.
5. THE STRUCTURE IS DESIGNED TO BE SELF-SUPPORTING AND STABLE AFTER THE BUILDING IS COMPLETE. IT IS THE CONTRACTOR'S RESPONSIBILITY TO DETERMINE ERECTION PROCEDURES AND SEQUENCE TO ENSURE SAFETY OF THE BUILDING AND ITS COMPONENTS DURING ERECTION. THIS INCLUDES THE ADDITION OF NECESSARY SHORING, SHEETING, TEMPORARY BRACING, GUYS OR TIEDOWNS.
6. DETAILS LABELED "TYPICAL DETAILS" ON THE DRAWINGS SHALL APPLY TO ALL SITUATIONS OCCURRING ON THE PROJECT THAT ARE THE SAME OR SIMILAR TO THOSE SPECIFICALLY DETAILED. THE APPLICABILITY OF THE DETAIL TO ITS LOCATION ON THE DRAWINGS CAN BE DETERMINED BY THE TITLE OF DETAIL. SUCH DETAILS SHALL APPLY WHETHER OR NOT THEY ARE REFERENCED AT EACH LOCATION. QUESTIONS REGARDING APPLICABILITY OF TYPICAL DETAILS SHALL BE DETERMINED BY THE ENGINEER OF RECORD.
7. THE GENERAL CONTRACTOR SHALL COMPARE THE ARCHITECTURAL, MECHANICAL, ELECTRICAL, PLUMBING, CIVIL AND STRUCTURAL DRAWINGS AND REPORT ANY DISCREPANCIES BETWEEN EACH SET OF DRAWINGS AND WITHIN EACH SET OF DRAWINGS TO THE ARCHITECT AND ENGINEER OF RECORD PRIOR TO THE FABRICATION AND INSTALLATION OF ANY STRUCTURAL MEMBERS.
8. THE CONTRACT STRUCTURAL DRAWINGS AND SPECIFICATIONS REPRESENT THE FINISHED STRUCTURE, AND DO NOT INDICATE THE METHOD OR MEANS OF CONSTRUCTION. THE CONTRACTOR SHALL SUPERVISE AND DIRECT THE WORK AND SHALL BE SOLELY RESPONSIBLE FOR ALL CONSTRUCTION MEANS, METHODS, PROCEDURES, TECHNIQUES, SEQUENCE AND SAFETY. THE ENGINEER DOES NOT HAVE CONTROL OR CHARGE OF, AND SHALL NOT BE RESPONSIBLE FOR, CONSTRUCTION MEANS, METHODS, TECHNIQUES, SEQUENCES, OR PROCEDURES, FOR SAFETY, PRECAUTIONS AND PROGRAMS IN CONNECTION WITH THE WORK, FOR THE ACTS OR OMISSION OF THE CONTRACTOR, SUBCONTRACTOR OR ANY OTHER PERSONS PERFORMING ANY OF THE WORK, OR FOR THE FAILURE OF ANY OF THEM TO CARRY OUT THE WORK IN ACCORDANCE WITH THE CONTRACT DOCUMENTS.
9. THE STRUCTURAL ENGINEER'S OBLIGATIONS TO REVIEW SHOP DRAWINGS AND OTHER SUBMITTALS AND TO RETURN THEM IN A TIMELY MANNER ARE CONDITIONED UPON THE PRIOR REVIEW AND APPROVAL OF THE SHOP DRAWINGS OR SUBMITTALS BY THE ARCHITECT AND ENGINEER OF RECORD. THE CONSTRUCTION CONTRACT AND THE CONTRACTOR'S SUBMITTAL OF THE SHOP DRAWINGS AND OTHER SUBMITTALS IN ACCORDANCE WITH A WRITTEN SCHEDULE DISTRIBUTED IN ADVANCE TO THE ENGINEER IDENTIFYING THE DATES FOR THE SUBMITTAL OF THE VARIOUS SHOP DRAWINGS AND SUBMITTALS.
10. PERIODIC SITE OBSERVATION BY FIELD REPRESENTATIVES OF TFC ENGINEERING FOR ARCHITECTURE IS SOLELY FOR THE PURPOSE OF DETERMINING IF THE WORK OF THE CONTRACTOR IS PROCEEDING IN GENERAL ACCORDANCE WITH THE STRUCTURAL CONTRACT DOCUMENTS. THIS LIMITED SITE OBSERVATION SHALL NOT BE CONSTRUED AS EXHAUSTIVE OR CONTINUOUS TO CHECK THE QUALITY OR QUANTITY OF THE WORK.
11. ALL STRUCTURES REQUIRE PERIODIC MAINTENANCE TO EXCEED LIFE SPAN AND TO ENSURE STRUCTURAL INTEGRITY FROM EXPOSURE TO THE ENVIRONMENT. A PLANNED PROGRAM OF MAINTENANCE SHALL BE ESTABLISHED BY THE OWNER. THIS PROGRAM SHALL INCLUDE ITEMS SUCH AS, BUT NOT LIMITED TO, PAINTING OF STRUCTURAL STEEL, PROTECTIVE COATINGS FOR CONCRETE, SEALANTS, CAULKED JOISTS, EXPANSION JOINTS, CONTROL JOINTS, SPALLS AND CRACKS IN CONCRETE, AND PRESSURE WASHING OF EXPOSED STRUCTURAL ELEMENTS EXPOSED TO SALT ENVIRONMENT OR OTHER HARSH CONDITIONS.
12. THE STRUCTURAL ENGINEER OF RECORD IS NOT RESPONSIBLE FOR THE DESIGN OF STEEL STAIRS, HANDRAILS, WINDOW AND DOOR SYSTEMS, COLD-FORMED STEEL FRAMING, OR OTHER SYSTEMS NOT SHOWN IN THE STRUCTURAL DOCUMENTS. SUCH SYSTEMS SHALL BE DESIGNED, FURNISHED, AND INSTALLED AS REQUIRED BY OTHER PORTIONS OF THE CONTRACT DOCUMENTS.
13. IN THE PROFESSIONAL OPINION OF TFC ENGINEERING FOR ARCHITECTURE, INC. THE STRUCTURAL CONTRACT DOCUMENTS FOR THIS PROJECT HAVE BEEN PREPARED IN ACCORDANCE WITH THE DESIGN CRITERIA AS SET FORTH IN THE FLORIDA BUILDING CODE, LATEST EDITION.
14. NO PROVISIONS HAVE BEEN MADE FOR VERTICAL OR HORIZONTAL EXPANSION EXCEPT AS SHOWN ON CONTRACT DOCUMENTS.
15. FINISH FLOOR ELEVATION (FIRST FLOOR) OF 0'-0" (100'-0") IS USED AS A REFERENCE ELEVATION. SEE CIVIL DRAWINGS FOR ACTUAL ELEVATION.
16. THE USE OF REPRODUCTION OF THE CONTRACT DOCUMENTS AND USE OF CAD FILES BY ANY CONTRACTOR, SUBCONTRACTOR, ERECTOR, FABRICATOR OR MATERIAL SUPPLIER IN LIEU OF PREPARATION OF SHOP DRAWINGS SIGNIFY HIS ACCEPTANCE OF ALL INFORMATION SHOWN HEREON AS CORRECT, AND OBLIGATES HIMSELF TO ANY JOBS EXPENSES, REAL OR IMPLIED, ARISING DUE TO ANY ERRORS THAT MAY OCCUR HEREON.
17. IN THE EVENT THAT THE STRUCTURAL CONTRACTS DRAWINGS AND SPECIFICATIONS CONFLICT ON INFORMATION, THE STRUCTURAL CONTRACT DRAWINGS SHALL SUPERSEDE THE SPECIFICATIONS.

1060 DESIGN LOADS:

1. THE STRUCTURAL SYSTEM FOR THIS BUILDING HAS BEEN DESIGNED IN ACCORDANCE WITH THE FLORIDA BUILDING CODE, 2010 EDITION, AND AS SUPPLEMENTED BY LOCAL AMENDMENTS.
2. THE FOLLOWING SUPERIMPOSED LOADINGS HAVE BEEN UTILIZED:
  - 2.1. DEAD LOADS
    - ROOF STRUCTURE 15 PSF
    - ROOF STRUCTURE W/ LT. WT. CONC. INSULATION M/E/P LOADS 5 PSF
    - CEILING 5 PSF
    - COLLATERAL LOADS 10 PSF
    - STEEL STUDS W/ GYP. BOARD PARTITIONS 10 PSF
    - 8" CMU NON-LOAD BEARING PARTITIONS 44 PSF
    - 8" CMU LOAD BEARING PARTITIONS 51 PSF
  - 2.2. LIVE LOADS
    - ROOF 20 PSF
- 2.3. WIND: PER FLORIDA BUILDING CODE, SECTION 1609. SEE SHEET S-0.3 FOR COMPONENTS AND CLADDING PRESSURES
  - ULTIMATE DESIGN WIND SPEED,  $V_{ult}$  = 140 MPH (3 SEC. GUST)
  - NOMINAL DESIGN WIND SPEED,  $V_{asd}$  = 108 MPH (3 SEC. GUST)
  - RISK CATEGORY III
  - EXPOSURE = C

1330 SHOP DRAWING REVIEW:

1. SHOP DRAWINGS SHALL ADEQUATELY DEPICT THE STRUCTURAL ELEMENTS AND CONNECTIONS SHOWN ON THE CONTRACT DOCUMENTS. SHOP DRAWINGS WILL BE REVIEWED FOR GENERAL COMPLIANCE WITH THE DESIGN INTENT OF THE CONTRACT DOCUMENTS ONLY. SHOP DRAWINGS SHALL BE THE RESPONSIBILITY OF THE CONTRACTOR TO VERIFY COMPLIANCE WITH THE CONTRACT DOCUMENTS AS TO QUANTITY, LENGTH, ELEVATIONS, DIMENSIONS, ETC. REVIEW OF SUBMITTALS AND SHOP DRAWINGS DOES NOT RELIEVE THE CONTRACTOR OF FULL RESPONSIBILITY FOR ERRORS AND OMISSIONS ASSOCIATED WITH THE PREPARATION OF SHOP DRAWINGS.
2. SHOP DRAWINGS SHALL BE REVIEWED BY THE CONTRACTOR AND MARKED "APPROVED" PRIOR TO SUBMITTAL TO THE ARCHITECT/ENGINEER. NON-CONFORMING DRAWING SUBMITTALS WILL BE RETURNED WITHOUT REVIEW.
3. SHOP DRAWING SUBMITTALS SHALL INCLUDE, AT A MINIMUM, ONE GOOD QUALITY REPRODUCIBLE AND THREE SETS OF BLUEPRINTS. ONE SET OF PRINTS WILL BE RETAINED BY THE ENGINEER OF RECORD, ONE BY THE ARCHITECT, ONE BY THE LOCAL BUILDING DEPARTMENT (WHERE REQUIRED) AND THE CONTRACTOR SHALL MAKE PRINTS FROM THE REPRODUCIBLE AS REQUIRED FOR DISTRIBUTION.
4. THE CONTRACT DOCUMENTS WILL GOVERN OVER THE SHOP DRAWINGS UNLESS OTHERWISE SPECIFIED IN WRITING BY THE ENGINEER OF RECORD. ANY CHANGES AND ADDITIONS MADE ON RE-SUBMITTALS SHALL BE CLEARLY FLAGGED AND NOTED. THE PURPOSE OF THE RE-SUBMITTALS SHALL BE CLEARLY NOTED ON THE LETTER OF TRANSMITTAL. ARCHITECT/ENGINEER OF RECORD REVIEW WILL BE LIMITED TO THOSE ITEMS CAUSING THE RE-SUBMITTAL. THE CONTRACTOR IS RESPONSIBLE FOR COSTS CAUSED BY MULTIPLE RE-SUBMITTALS (MORE THAN ONE) AT ARCHITECT/ENGINEERS' CURRENT HOURLY RATES.

1333 SUBMITTALS

1. ALL SHOP DRAWINGS MUST BE REVIEWED AND STAMPED APPROVED BY THE GENERAL CONTRACTOR PRIOR TO SUBMITTAL.
  2. THE GENERAL CONTRACTOR SHALL SUBMIT FOR ENGINEER REVIEW SHOP DRAWINGS FOR THE FOLLOWING ITEMS:
    - A. STRUCTURAL STEEL (\*)
    - B. REINFORCING STEEL
    - C. METAL ROOF OR FORM DECK
    - D. CONCRETE MIX DESIGNS
  3. ALL SHOP DRAWINGS MUST BE SHOWN ON SHOP DRAWINGS SEALED BY A PROFESSIONAL ENGINEER REGISTERED IN THE STATE OF FLORIDA.
  4. ITEMS MARKED (\*) SHALL BE SUBMITTED FOR ENGINEERS RECORD ONLY.
  5. MANUFACTURER'S LITERATURE. SUBMIT TWO COPIES OF MANUFACTURER'S LITERATURE FOR ALL MATERIALS AND PRODUCTS USED IN CONSTRUCTION ON THE PROJECT.
- 1334 REQUEST FOR INTERPRETATION (RFI)
1. RFI SHALL ORIGINATE WITH CONTRACTOR AND SHALL BE SUBMITTED IN THE FORM SPECIFIED WITHIN CONTRACT DOCUMENTS. RFI SHALL BE SUBMITTED IN A PROMPT MANNER AS TO AVOID DELAYS IN CONTRACTORS WORK.
  2. RFI SHALL BE SUBMITTED AS SPECIFIED WITHIN THE CONTRACT DOCUMENTS AND SHALL BE FORWARDED TO THE ENGINEER VIA THE ARCHITECT OR DIRECTLY TO THE ENGINEER BY THE CONTRACTOR WHEN APPROVED BY THE ARCHITECT.
  3. ENGINEER SHALL TAKE UP TO 5 BUSINESS DAYS TO REVIEW AND RETURN OF RFI. ENGINEER WILL ATTEMPT TO EXPEDITE THE REVIEW OF RFI WITHIN A REASONABLE TIME FRAME.
  4. RFI RESPONSES ARE NOT INTENDED TO AUTHORIZE ANY INCREASE IN CONSTRUCTION COST, SCHEDULE OR TIME EXTENSIONS, OR CONSTRUCTION IN CONFLICT WITH ANY APPLICABLE CODES OR SPECIFIED DESIGN STANDARDS. IT IS THE RESPONSIBILITY OF THE CONTRACTOR TO NOTIFY THE DESIGN TEAM IMMEDIATELY OF ANY PERCEIVED SCOPE, SCHEDULE, OR COST IMPACTS OR ADJUSTMENTS. IF CONTRACTOR REQUESTS ANY ADDITIONAL COST, INCREASE IN SCHEDULE OR ADJUSTMENT IN SCOPE, THE CONTRACTOR SHALL NOT PROCEED WITH ADDITIONAL WORK UNTIL APPROVED IN WRITING BY THE CONSTRUCTION ADMINISTRATOR.

2210 DEMOLITION NOTES:

1. THE CONTRACTOR IS REQUIRED TO PROVIDE ALL TEMPORARY SCAFFOLDING, PLATFORMS, BARRICADES, RAILINGS, SCREENING, ETC. NECESSARY TO PROTECT EXISTING FACILITIES, STRUCTURES AND THE PUBLIC DURING DEMOLITION AND ERECTION OF THE NEW CONSTRUCTION, AS WELL AS FOR JOB SAFETY, JOB SAFETY, CONSTRUCTION AND DEMOLITION PROCEDURES AND THE ASSOCIATED BARRICADE REQUIREMENTS WITHIN A MINIMUM OF 7 DAYS PRIOR TO COMMENCING WORK.
2. THE CONTRACTOR IS REQUIRED TO COORDINATE WITH THE OWNER FOR THE TEMPORARY SUSPENSION OF USE OF ANY FACILITY OR PORTION THEREOF.
3. THE CONTRACTOR IS REQUIRED TO PERFORM HIS WORK IN A MANNER, WHICH WILL NOT CONFLICT WITH ANY OPERATION, WHICH IS TO REMAIN IN OPERATION DURING THE COURSE OF THE PROJECT, UNTIL SUCH OPERATION IS SCHEDULED TO BE SHUT DOWN.
4. THE CONTRACTOR IS REQUIRED TO COORDINATE WITH OWNER FOR THE TEMPORARY SUSPENSION OF USE OF ANY UTILITY SYSTEM, A MINIMUM OF 3 DAYS PRIOR TO COMMENCING WORK.
5. AT ALL LOCATIONS WHERE NEW CONSTRUCTION WILL INTERFACE WITH EXISTING ELEMENTS, CUT THROUGH EXISTING STRUCTURE IN STRAIGHT AND TRUE LINES TO INSURE A NEAT INTERFACE.
6. AT ALL LOCATIONS WHERE THE DEMOLITION OF A CONCRETE MEMBER LEAVES THE ENDS OF REINFORCING STEEL EXPOSED, PROVIDE THE FOLLOWING:
  - A. CHIP CONCRETE FROM AROUND THE STEEL TO A DEPTH OF 1".
  - B. CUT OFF REINFORCING STEEL NOT LESS THAN 3/4" BELOW THE CONCRETE SURFACE.
  - C. FILL THE CAVITY FLUSH WITH A HIGH MODULUS GEL EPOXY. SEE SPECIFICATION FOR ACCEPTED MANUFACTURERS.
7. BEFORE DEMOLISHING ANY STRUCTURAL ELEMENT, INSTALL ALL REQUIRED TEMPORARY AND/OR PERMANENT BRACING AND SUPPORTS.
8. PROVIDE TEMPORARY CLOSURE OF ALL ROADS, W. AL. AND OTHER OPENINGS TO PROTECT BUILDING FROM EXPOSURE TO UNDESIRABLE ELEMENTS UNTIL NEW CONSTRUCTION IS WEATHERPROOFED. AT WHICH TIME SUCH TEMPORARY CONSTRUCTION SHALL BE REMOVED. ALL TEMPORARY STRUCTURAL WALLS THAT ARE SUBJECT TO WIND LOADS ARE TO BE DESIGNED BY A DELEGATED ENGINEER.
9. UPON COMPLETION OF NEW CONSTRUCTION UNDER EACH PHASE, ALL DEMOLISHED AREAS SHALL BE RESTORED TO ACCEPTABLE USE ACCORDING TO THE CONTRACT DOCUMENTS AS DETERMINED BY THE A/E.
10. REMOVE COMPLETELY FROM ALL AREAS ALL DEBRIS, INCLUDING ALL DEBRIS GENERATED BY THE DEMOLITION WORK AS THE WORK PROGRESSES. STOCKPILING OF DEBRIS AND BURNING OF DEBRIS ON THE PREMISES IS STRICTLY PROHIBITED.

2220 EXISTING STRUCTURE:

1. INFORMATION SHOWN FOR THE EXISTING STRUCTURE ON THESE DRAWINGS WAS TAKEN FROM THE DRAWINGS THAT WERE PREPARED FOR: PREPARED BY: ZEB V. LACKY AND ASSOCIATES ARCHITECTS ENTITLED: SUWANNEE PRIMARY SCHOOL DATED: DECEMBER 10, 1974
2. WORK SHOWN ON THESE DRAWINGS ASSUMES THAT THE ORIGINAL CONSTRUCTION WAS PERFORMED IN ACCORDANCE WITH THE ABOVE INDICATED ORIGINAL DRAWINGS INCLUDING (BUT NOT LIMITED TO) DIMENSIONS, ELEVATIONS, MEMBER SIZES, MATERIALS, DETAILS, ETC. IT SHALL BE THE RESPONSIBILITY OF THE CONTRACTOR TO VERIFY THE CONDITIONS RELATING TO THE EXISTING STRUCTURE AND TO NOTIFY THE ENGINEER IMMEDIATELY OF ANY DISCREPANCIES OR CONFLICTS.

2300 FOUNDATIONS - W/O SOIL REPORTS:

1. IN THE ABSENCE OF ANY GEOTECHNICAL RECOMMENDATIONS THE FOUNDATIONS ARE DESIGNED FOR AN ANTICIPATED ALLOWABLE SOIL BEARING CAPACITY OF 2,000 PSF ON COMPACTED FILL BATTERED TO DIMENSIONS OUTLINED IN THE EXISTING AND CURRENT CONSTRUCTION DOCUMENTS.
2. REGARDLESS OF WHETHER OR NOT A GEOTECHNICAL INVESTIGATION IS PERFORMED, NO WARRANTIES, EXPRESSED OR IMPLIED, ARE MADE BY TFC FOR THE PERFORMANCE OF THE FOUNDATION RELATED TO THESE ASSUMPTIONS.

1331 SHOP DRAWINGS FOR SPECIALTY ENGINEERED PRODUCTS:

1. THE FOLLOWING SYSTEMS AND COMPONENTS AS A MINIMUM REQUIRE FABRICATION AND ERECTION DRAWINGS PREPARED BY A DELEGATED ENGINEER:
  - A. ARCHITECTURAL PRECAST CONCRETE ELEMENTS
  - B. OPEN WEB STEEL JOISTS
  - C. STRUCTURAL STEEL CONNECTIONS REQUIRING ENGINEERING
  - D. METAL ROOF DECK ASSEMBLIES
2. SUBMITTALS SHALL CLEARLY IDENTIFY THE SPECIFIC PROJECT AND APPLICABLE CODES, LIST THE DESIGN CRITERIA, AND SHOW ALL DETAILS AND DRAWINGS NECESSARY FOR PROPER FABRICATION AND INSTALLATION. CALCULATIONS AND SHOP DRAWINGS SHALL IDENTIFY SPECIFIC PRODUCT UTILIZED. GENERIC PRODUCTS WILL NOT BE ACCEPTED.
3. SHOP DRAWINGS AND CALCULATIONS SHALL BE PREPARED UNDER THE DIRECT SUPERVISION AND CONTROL OF THE DELEGATED ENGINEER.
4. SHOP DRAWINGS AND CALCULATIONS SHALL BE SIGNED AND SEALED BY AN ENGINEER REGISTERED IN THE STATE OF FLORIDA. COMPUTER PRINTS ARE AN ACCEPTABLE SUBSTITUTE FOR MANUAL COMPUTATIONS PROVIDED THEY ARE ACCOMPANIED BY SUFFICIENT DESCRIPTIVE INFORMATION TO PERMIT THEIR PROPER EVALUATION. SUCH DESCRIPTIVE INFORMATION SHALL BE SIGNED AND SEALED BY AN ENGINEER REGISTERED IN THE STATE OF FLORIDA AS AN INDICATION THAT HE/SHE HAS ACCEPTED RESPONSIBILITY FOR THE RESULTS. THE STRUCTURAL ENGINEER WILL RETAIN ONE SIGNED AND SEALED SET FOR THEIR RECORDS.
5. DRAWINGS PREPARED SOLELY TO SERVE AS A GUIDE FOR FABRICATION AND INSTALLATION (SUCH AS REINFORCING STEEL, SHOP DRAWINGS OR STRUCTURAL STEEL ERECTION DRAWINGS) AND REQUIRING NO ENGINEERING, DO NOT REQUIRE THE SEAL OF A DELEGATED ENGINEER.
6. CATALOG INFORMATION ON STANDARD PRODUCTS DOES NOT REQUIRE THE SEAL OF A DELEGATED ENGINEER.
7. REVIEW BY THE STRUCTURAL ENGINEER OF RECORD OF SUBMITTALS IS LIMITED TO VERIFYING THE FOLLOWING:
  - A. THAT THE SPECIFIED STRUCTURAL SUBMITTALS HAVE BEEN FURNISHED.
  - B. THAT THE STRUCTURAL SUBMITTALS HAVE BEEN SIGNED AND SEALED BY THE DELEGATED ENGINEER.
  - C. THAT THE DELEGATED ENGINEER HAS UNDERSTOOD THE DESIGN INTENT AND HAS USED THE SPECIFIED STRUCTURAL CRITERIA. NO DETAILED CHECK OF CALCULATIONS WILL BE MADE.
  - D. THAT THE CONFIGURATION SET FORTH IN THE STRUCTURAL SUBMITTALS IS CONSISTENT WITH THE CONTRACT DOCUMENTS. NO DETAILED CHECK OF DIMENSIONS OR QUANTITIES WILL BE MADE.
  - E. SUBMITTALS NOT MEETING THE ABOVE CRITERIA WILL NOT BE REVIEWED AND WILL BE RETURNED.

3302 CONCRETE:

1. SHALL BE PER AN APPROVED MIX DESIGN PROPORTIONED TO ACHIEVE A STRENGTH AT 28 DAYS AS LISTED BELOW WITH A PLASTIC AND WORKABLE MIX.

LOCATION	STRENGTH	SLUMP	MAX AGGREGATE	W/C RATIO
FOUNDATIONS	4000 PSI	4-6"	3/4"	0.48
SLABS ON GRADE	4000 PSI	4-6"	3/4"	0.48
TIE BEAMS	4000 PSI	4-6"	3/4"	0.48
2. CONCRETE SHALL BE PLACED AND CURED ACCORDING TO ACI STANDARDS AND SPECIFICATIONS.
3. SUBMIT PROPOSED MIX DESIGN WITH RECENT FIELD CYLINDER OR LAB TESTS FOR REVIEW PRIOR TO USE. MIX SHALL BE UNIQUELY IDENTIFIED BY MIX NUMBER OR OTHER POSITIVE IDENTIFICATION. MIX SHALL MEET THE REQUIREMENTS OF ASTM C39 FOR COARSE AGGREGATE.
4. CONCRETE SHALL COMPLY WITH THE REQUIREMENTS OF ASTM STANDARD C94 FOR MEASURING, MIXING, TRANSPORTING, ETC. CONCRETE TESTS SHALL BE TIME STAMPED WHEN CONCRETE IS BATCHED.
5. THE MAXIMUM TIME ALLOWED FROM THE TIME THE MIXING WATER IS ADDED UNTIL IT IS DEPOSITED IN ITS FINAL POSITION SHALL NOT EXCEED ONE AND ONE HALF (1-1/2) HOURS. IF FOR ANY REASON THERE IS A LONGER DELAY THAN THAT STATED ABOVE, THE CONCRETE SHALL BE DISCARDED. IT SHALL BE THE RESPONSIBILITY OF THE TESTING LAB TO NOTIFY THE OWNER'S REPRESENTATIVE AND THE CONTRACTOR OF ANY NONCOMPLIANCE WITH THE ABOVE.
6. SLABS SHALL BE CURED USING A DISSIPATING CURING COMPOUND MEETING ASTM STANDARD C309 TYPE 1-CLASS D AND SHALL HAVE A FUGITIVE DYE. THE COMPOUND SHALL BE PLACED AS SOON AS THE FINISHING IS COMPLETED OR AS SOON AS THE WATER HAS LEFT THE UNFINISHED CONCRETE. SCUFFED OR BROKEN AREAS IN THE CURING MEMBRANE SHALL BE RECOATED DAILY.
7. CALCIUM CHLORIDES SHALL NOT BE UTILIZED; OTHER ADMIXTURES MAY BE USED ONLY WITH THE APPROVAL OF THE ENGINEER.
8. CONCRETE MIX DESIGNS SHALL INCLUDE A WRITTEN DESCRIPTION INDICATING WHERE EACH PARTICULAR MIX IS TO BE PLACED WITHIN THE STRUCTURE.
9. CONDUITS, PIPES AND SLEEVES SHALL BE PLACED AND SPACED IN ACCORDANCE WITH ACI 318.9.
10. CONCRETE DESIGN MIX SUBMITTALS SHALL INCLUDE TESTED, STATISTICAL BACK-UP DATA AS PER CHAPTER 5 OF ACI 318.
11. ALL COLUMNS AND BEAMS INTERGRATED IN CMU WALLS ARE 8" AND 12" NOMINAL AND 7.5-8" AND 11-5/8" ACTUAL DIMENSIONS.
12. CONCRETE SLABS ON GRADE SHALL BE REINFORCED WITH SYNTHETIC FIBERS AT A MINIMUM RATE OF 1.5 LBS/CY, OR AS RECOMMENDED BY THE FIBER MANUFACTURER FOR CONTROL OF TEMPERATURE AND SHRINKAGE/CRACKING, WHICH EVER IS GREATER.
13. WHEN TOTAL WIDTH OF PIPES OR DUCTS CAST INTO A SLAB EXCEED 12" IN A 24" WIDTH THEN THE CONTRACTOR SHALL ADD A LAYER OF #4 @ 12" ABOVE AND PERPENDICULAR TO THE DUCT/PIPE RUNS EXTENDING 12" BEYOND THE LAST DUCT/PIPE ON EACH SIDE.
14. WHEN WATER-BASED ADHESIVE ARE BEING USED ON CONCRETE SURFACES, THE CONTRACTOR SHALL VERIFY THAT THE WATER CONTENT OF THE CONCRETE IS WITHIN THE ALLOWABLE RANGE BEFORE INSTALLATION.
15. WHERE SPECIFIED CONCRETE STRENGTH OF COLUMN IS GREATER THAN THE SPECIFIED SLAB CONCRETE STRENGTH, HIGHER STRENGTH CONCRETE SHALL BE PUDDLED AT THE COLUMN. THE STRENGTH OF PUDDLED CONCRETE SHALL BE AT LEAST 0.72 TIMES THE STRENGTH OF COLUMN CONCRETE PER ACI 318.10.15.

3310 REINFORCING STEEL:

1. SHALL BE ASTM A615 GRADE 60 DEFORMED BARS, FREE FROM OIL, SCALE AND RUST AND PLACED IN ACCORDANCE WITH THE TYPICAL BENDING DIAGRAM AND PLACING DETAILS OF ACI STANDARDS AND SPECIFICATIONS.
2. PROVIDE CONCRETE COVER OVER PRIMARY REINFORCEMENT, TIES, AND STIRRUPS, AS FOLLOWS, UNLESS OTHERWISE NOTED:

LOCATION AND CONDITION	MINIMUM COVER
A. CONCRETE CAST AGAINST AND PERMANENTLY EXPOSED TO EARTH	ALL BARS 3"
B. CONCRETE EXPOSED TO EARTH OR WEATHER	#6 OR GREATER 2"
C. CONCRETE NOT EXPOSED TO WEATHER OR IN CONTACT WITH GROUND	#5 OR SMALLER 1.5"
3. SECURE APPROVAL OF SHOP DRAWINGS PRIOR TO COMMENCING FABRICATION.
4. PROVIDE STANDARD HOOKS AT DISCONTINUOUS ENDS OF ALL TOP BARS.
5. WHERE REINFORCING IS SHOWN CONTINUOUS, SPLICE BOTTOM BARS OVER SUPPORTS AND TOP BARS AT CENTER OF SPAN. ALL OTHER LAP SPLICES SHALL BE IN ACCORDANCE WITH SPLICE TABLES AND DETAILS SHOWN ON DRAWINGS.
6. PROVIDE DOWELS INTO FOOTINGS, PILE CAPS, SUPPORT BEAMS, ETC. TO MATCH VERTICAL BARS WITH CLASS B TENSION LAP SPLICES, U.N.O.
7. LENGTH OF LAP SPLICES AND BAR EMBEDMENT SHALL BE AS SHOWN IN TABLE, UNLESS OTHERWISE NOTED:

BAR SIZE	3000 PSI	4000 PSI	5000 PSI
T < 12"	#6 OR LESS 57db	49db	44db
#7 OR MORE	71db	61db	55db
T > 12"	#6 OR LESS 57db	49db	44db
#7 OR MORE	81db	79db	72db
8. WHERE "T" IS DEPTH OF CONCRETE UNDER BARS AND "db" IS BAR DIAMETER.
9. UTILIZE CLASS "B" SPLICE FOR ALL SPLICES, U.N.O. ON PLANS OR DETAILS.
10. AT CHANGES IN DIRECTION OF CONCRETE WALLS AND TIE BEAMS, PROVIDE CORNER BARS OF SAME SIZE AND SPACING AS HORIZONTAL STEEL.

3314 WELDED WIRE FABRIC:

1. SHALL CONFORM TO ASTM A-185. FREE FROM OIL, SCALE AND RUST AND PLACED IN ACCORDANCE WITH THE TYPICAL PLACING DETAILS OF ACI STANDARDS AND SPECIFICATIONS.
2. MINIMUM LAP SHALL BE ONE SPACE PLUS TWO INCHES.
3. USE OF FLAT MANUFACTURED SHEETS IS REQUIRED (NO ROLLS).
4. INSTALL WWF ON BRICKS OR BOLSTERS AT MID DEPTH OF SLAB U.N.O.

3322 CONSTRUCTION JOINTS:

1. ANY DEVIATION OR ADDITION OF CONSTRUCTION JOINTS FROM THAT SHOWN ON THE DRAWINGS MUST BE REVIEWED AND APPROVED IN WRITING BY THE ENGINEER OF RECORD.
2. ALTERNATE OR ADDED CONSTRUCTION JOINT LOCATIONS ARE ACCEPTABLE ONLY AS A CHANGE ORDER, WHICH WILL INCLUDE ENGINEERING CHARGES BY THE ENGINEER OF RECORD FOR REDESIGN OF THE STRUCTURE, SHORING, ETC.

3400 CONCRETE TESTING:

1. AN INDEPENDENT TESTING LABORATORY SHALL PERFORM THE FOLLOWING TESTS ON CAST IN PLACE CONCRETE:
  - A. ASTM C143 - STANDARD TEST METHOD FOR SLUMP OF PORTLAND CEMENT CONCRETE.
  - B. ASTM C39 - STANDARD TEST METHOD FOR COMPRESSIVE STRENGTH OF CYLINDRICAL CONCRETE SPECIMENS.
2. A SEPARATE TEST SHALL BE CONDUCTED FOR EACH CLASS. FOR EVERY 500 CUBIC YARDS (OR FRACTION THEREOF), PLACED PER DAY. REQUIRED CYLINDER(S) QUANTITIES AND TEST AGE AS FOLLOWS:

1 AT 3 DAYS
1 AT 7 DAYS
2 AT 28 DAYS
3. ONE ADDITIONAL RESERVE CYLINDER TO BE TESTED UNDER THE DIRECTION OF THE ENGINEER, IF REQUIRED. IF 28 DAY STRENGTH IS ACHIEVED, THE ADDITIONAL CYLINDER(S) MAY BE DISCARDED.

STRUCTURAL NOTES

3601 CHEMICAL (ADHESIVE) ANCHORS:

1. SHALL BE A TWO PART EPOXY POLYMER INJECTION SYSTEM, SUCH AS HILTI HIT HY150, HILTI RES50, OR SIMPSON SET ADHESIVE SYSTEM, OR ENGINEER APPROVED SUBSTITUTION.
2. EPOXY TYPES AND BRANDS VARY IN THEIR BOND STRENGTH AND SUITABILITY OF USE, DEPENDING ON TYPE OF LOADING, ANCHOR SPACING, ETC. WHEN A PARTICULAR TYPE OF EPOXY IS SPECIFIED IN THESE DRAWINGS, A UNIQUE CALCULATION HAS BEEN MADE BASED ON THE PROPERTIES OF THAT SPECIFIC TYPE OF EPOXY FOR THE SPECIFIC CONDITION SHOWN IN THE DETAIL. SUBSTITUTION OF EPOXY TYPE IS NOT ALLOWED WHERE DETAIL SPECIFIES ONLY ONE TYPE OF EPOXY, WITHOUT PRIOR WRITTEN APPROVAL BY THE ENGINEER OF RECORD. NOT ALL EPOXY BRANDS OR TYPES WILL BE ALLOWED AS SUBSTITUTES.
3. SUBSTITUTION OF EPOXIES IN ONE CONDITION SHALL NOT BE CONSTRUED AS APPROVAL TO MAKE SIMILAR SUBSTITUTION OF EPOXIES IN OTHER DIFFERING CONDITIONS. EACH SUBSTITUTION MUST RECEIVE PRIOR WRITTEN APPROVAL BY THE ENGINEER OF RECORD.
4. INSTALL IN ACCORDANCE WITH MANUFACTURER'S WRITTEN INSTRUCTIONS.
5. THE MANUFACTURER'S REPRESENTATIVE SHALL TRAIN INSTALLERS.
6. THE CONTRACTOR IS RESPONSIBLE TO ENSURE THAT ALL HOLE CLEAN-OUT REQUIREMENTS ARE FULLY COMPLETED BY THE INSTALLERS PRIOR TO INJECTING EPOXY INTO THE HOLES.
7. NO LOAD SHALL BE APPLIED TO THE EPOXY ANCHORS UNTIL THE EPOXY HAS FULLY CURED AND HAS ACHIEVED ITS SPECIFIED STRENGTH.
8. IF DETAIL SHOWS EPOXY ANCHORS IN SLOTTED HOLES, IT IS IMPERATIVE THAT ANY EXCESS EPOXY IS CLEANED UP FROM AROUND THE ANCHOR ROD, SO THAT IT DOES NOT INTERFERE WITH ADJUSTABILITY OF ANCHOR ROD IN SLOTTED HOLE.

3602 MECHANICAL ANCHORS:

1. SHALL BE EITHER HEAVY DUTY CONCRETE SCREW ANCHOR (SUCH AS ANCHOR WEDGE-BOLT, SIMPSON TITEN HD, OR HILTI HUS-H) OR WEDGE TYPE EXPANSION ANCHOR (SUCH AS POWERS POWER-STOP, SIMPSON WEDGE-ALL, OR HILTI KWIK BOLT 3).
2. TYPE OF ANCHOR SHALL BE AS SPECIFIED ON THE DRAWINGS, WHILE BRAND AND MODEL OF ANCHOR MAY BE SELECTED FROM THE ABOVE LISTED ANCHOR TYPES. SUBSTITUTION OF ANCHORS SHALL BE APPROVED IN WRITING FOR REVIEW AND APPROVED IN WRITING BY THE ENGINEER OF RECORD PRIOR TO USE.
3. IN SOME CASES OF CRITICAL LOADING OR GEOMETRIC CONDITIONS, ONLY SPECIFIC ANCHORS WILL BE ALLOWED, AS NOTED ON THE DRAWINGS. IN THESE CASES, THE SPECIFIED BRAND AND MODEL OF ANCHOR MUST BE USED.
4. INSTALL IN ACCORDANCE WITH MANUFACTURER'S INSTRUCTIONS.
5. THE MANUFACTURER'S REPRESENTATIVE SHALL TRAIN INSTALLERS.
6. WHEN EMBEDMENT DEPTH IS 12" AND INSTALLED INTO MASONRY SHALL BE 1.5". SELECT ANCHOR LENGTH AS REQUIRED TO ACHIEVE THE SPECIFIED MINIMUM EMBEDMENT DEPTH.
7. TAPCON SCREWS MAY BE REPLACED W/ 0.157" SHANK DIAMETER PAF ANCHORS (HILTI X-L OR EQUAL) OR SUBSTITUTION AS NOTED. MINIMUM EMBEDMENT DEPTH SHALL BE 1.25" WHEN INSTALLED INTO CONCRETE OR GROUTED MASONRY. FOLLOW MANUFACTURER'S INSTALLATION RECOMMENDATIONS, MINIMUM EDGE DISTANCES, AND PLACEMENT LIMITATIONS (RELATIVE TO MORTAR JOINTS IN MASONRY).

4810 MASONRY WALLS:

1. ALL MASONRY CONSTRUCTION SHALL CONFORM TO ACI 530/ASCE 5/TMS 402 "BUILDING CODE REQUIREMENTS FOR MASONRY STRUCTURES" AND ACI 530.1/ASCE 6/TMS 602 "SPECIFICATION FOR MASONRY STRUCTURES", LATEST EDITION.
2. MASONRY UNITS SHALL MEET ASTM C-90 FOR HOLLOW LOAD BEARING TYPE MASONRY WITH UNIT STRENGTH OF 1900 PSI ON THE NET AREA ( $f_m$  = 1500 PSI). MORTAR SHALL BE TYPE "M" OR "S" AND MEET ASTM C-270.
3. GROUT SHALL BE 3000 PSI MINIMUM COMPRESSIVE STRENGTH AND MEET ASTM C-476 AND HAVE A SLUMP BETWEEN 8" AND 11" WITH WATER CM RATIO OF 0.55 MAXIMUM AND WITH 3/8" MAXIMUM AGGREGATE.
4. PROVIDE HOOKED DOWELS IN FOUNDATIONS FOR VERTICAL REINFORCING ABOVE LAP SPICES AND TENSION DIAMETERS (U.N.O.).
5. BLIND CELLS SHALL BE GROUT FILLED WITH VERTICAL REINFORCING BARS AT CORNERS, INTERSECTIONS, EACH SIDE OF OPENINGS AND AS SHOWN ON THE DRAWINGS.
6. DOWELS SHALL BE USED TO PROVIDE CONTINUITY INTO THE STRUCTURE ABOVE AND/OR BELOW. UNLESS NOTED OTHERWISE.
7. USE METAL LATH, MORTAR OR SPECIAL UNITS TO CONFINE CONCRETE AND GROUT TO AREA AS REQUIRED.
8. MASONRY SHALL BE LAID IN RUNNING BOND PATTERN UNLESS NOTED OTHERWISE. AT FILLED CELLS LAY UNITS WITH FULL BED JOINTS AROUND CELLS.
9. PROVIDE 9 GAGE GALVANIZED HORIZONTAL JOINT REINFORCING (DUR-O-WALL OR ENGINEER APPROVED SUBSTITUTION) AT ALTERNATE BLOCK COURSES. LADDER TYPE IS RECOMMENDED WITH REINFORCED FILLED CELLS. PROVIDE PREFABRICATED "TIE" OR CORNER SECTIONS AT WALL INTERSECTIONS.
10. CONTROL JOINTS SHALL BE CONSTRUCTED IN CONCRETE MASONRY CONSTRUCTION AT A MAXIMUM HORIZONTAL SPACING BETWEEN JOINTS OF 25'-0" AND NOT MORE THAN 12' FROM CORNERS. SEE ARCHITECTURAL DRAWINGS FOR EXACT LOCATIONS. CONSTRUCT INTERIOR CONTROL JOINTS AT A MAXIMUM HORIZONTAL SPACING OF 32'-0" OR 16'-0" FROM CORNERS. NO JOINTS SHALL BE LOCATED WITHIN 2'-0" OF STEEL BEAM BEARINGS. HORIZONTAL WALL REINFORCING SHALL BE STOPPED EACH SIDE OF CONTROL JOINTS. SEE ARCHITECTURAL DRAWINGS FOR SEALANT REQUIREMENTS AT CONTROL JOINTS.
11. SUBMIT PROPOSED GROUT MIX DESIGNS FOR REVIEW PRIOR TO USE. MIX NUMBER OR OTHER POSITIVE IDENTIFICATION SHALL UNIQUELY IDENTIFY MIX.
12. USE OF SUPERPLASTICIZER IS PROHIBITED.
13. CELLS TO BE GROUT FILLED SHALL HAVE VERTICAL ALIGNMENT SUFFICIENT TO MAINTAIN A CLEAR, UNOBSTRUCTED, CONTINUOUS VERTICAL GROUT SPACE.
14. CLEANOUT OPENINGS SHALL BE PROVIDED AT THE BOTTOM OF CELLS TO BE GROUT FILLED IN EACH POUR IN EXCESS OF 5 FEET IN HEIGHT. AFTER INSPECTION AND BEFORE GROUTING, THE REBAR SHALL BE TIED AT THE CLEANOUTS AND THE CLEANOUTS SHALL BE SEALED.
15. ANY OVERHANGING MORTAR OR OTHER CONSTRUCTION OR DEBRIS SHALL BE REMOVED FROM THE INSIDES OF SUCH CELL WALLS.
16. VERTICAL REINFORCEMENT SHALL BE HELD IN POSITION AT TOP AND BOTTOM AND AT INTERVALS NOT EXCEEDING 192 BAR DIAMETERS.
17. CELLS CONTAINING REINFORCEMENT SHALL BE FILLED SOLIDLY WITH GROUT. SAMPLE AND TEST GROUT PER ASTM C-019.
18. GROUT SHALL BE POURED IN LIFTS OF 4 FEET MAXIMUM HEIGHT. GROUT SHALL BE CONSOLIDATED AT TIME OF PLACING BY VIBRATING AND RECONSOLIDATED LATER BY VIBRATING BEFORE PLASTICITY IS LOST.
19. WHEN TOTAL GROUT POUR EXCEEDS 5 FEET IN HEIGHT, (HIGH LIFT GROUTING), THE GROUT SHALL BE PLACED IN 4-FOOT LIFTS WITH A MINIMUM OF A 30 MINUTE DELAY BETWEEN LIFTS. MINIMUM CELL DIMENSION SHALL BE IN ACCORDANCE WITH TABLE 5 OF ACI 530.1 (3' X 3' FOR COARSE GROUT, 12 FT. MAXIMUM POUR HEIGHT).
20. WHEN THE GROUTING IS STOPPED FOR ONE HOUR OR LONGER, HORIZONTAL CONSTRUCTION JOINTS SHALL BE MADE BY STOPPING THE POUR OF GROUT NOT LESS THAN 1-1/2 INCH BELOW THE TOP OF THE UPPERMOST UNIT GROUTED.
21. WHERE CONCRETE BEAMS ARE INSTALLED IN CONCRETE MASONRY WALL, SUPPORT CONCRETE WITH 6" SIDE CONTINUOUS STRIPS OF 1/8 SQUARE MESH SOFFIT SCREENING OR PUR-O-STOP OF EQUAL CENTERED OVER BLOCK WORK. USE OF ROOFING FELT STRIPS WILL NOT BE PERMITTED.
22. MASONRY WALLS MARKED AS "LOAD BEARING" ARE DESIGNED TO CARRY FLOOR GRAVITY LOADS AND MUST BE CONSTRUCTED TO SUPPORT THE CONCRETE FLOOR SLAB CONCURRENTLY WITH CONCRETE COLUMN CONSTRUCTION.
23. MASONRY WALLS INDICATED AS "INFILL" ARE DESIGNED TO RESIST LATERAL LOADS AND MUST BE CONSTRUCTED AFTER THE CONCRETE SLAB IS CAST AND POST TENSIONING OPERATION IS COMPLETED. INFILL WALLS SHALL BE CONSTRUCTED STARTING AT THE FOUNDATION LEVEL AND WORKING UPWARD ONE LEVEL AT A TIME. DO NOT START NEXT HIGHER LEVEL OF WALL PRIOR TO COMPLETION OF WALL BELOW. ALLOW A MINIMUM OF 3 DAYS CURING FOR GROUT OF WALL BELOW PRIOR TO STARTING WALL ABOVE.
24. SINGLE STORY MASONRY WALLS INDICATED AS "PARTITION WALLS" SHALL BE CAST ON THICKENED SLAB FOUNDATIONS AND ARE NOT DESIGNED TO CARRY ANY LOADS FROM THE MAIN BUILDING STRUCTURES. ISOLATE TOP OF PARTITION WALLS FROM UNDERSIDE OF CONCRETE SLAB WITH A MINIMUM 1/2" THICK COMPRESSIBLE MATERIAL.
25. PROVIDE DOVETAIL ANCHORS AT 16" C/C UNLESS NOTED OTHERWISE, WHERE MASONRY WALLS ABUT CONCRETE SURFACES.
26. SUBMIT WRITTEN CONSTRUCTION SEQUENCES AND PROCEDURES PRIOR TO THE START OF MASONRY CONSTRUCTION.

4814 TIE BEAMS:

1. STEEL WALLS WITH THE PREFIX "TB" SHALL BE OF CONCRETE, POURED AFTER THE MASONRY WALLS BELOW ARE IN PLACE.
2. REINFORCING SHALL BE CONTINUOUS THROUGH THE BEAMS WITH MINIMUM LAP SPLICES OF 48 BAR DIAMETERS AND BEND BARS AT CORNERS.
3. PROVIDE ONE END OF EACH TIE BEAM WITH AN ATTACHED STRUT TO AREA REQUIRED, IN ACCORDANCE WITH ACI 530.1 (SOLID METAL OR FELT CAVITY CAPS ARE PROHIBITED).

5120 STRUCTURAL STEEL:


1. STEEL WORK SHALL BE NEW AND CONFORM TO THE ANSI/AISC 360-05 SPECIFICATION FOR STRUCTURAL STEEL BUILDINGS.
2. MATERIAL SHALL CONFORM TO THE FOLLOWING, EXCEPT AS NOTED:

WIDE FLANGE SHAPES	ASTM A36 (Fy=50+KSI)
W AND M SHAPES	ASTM A36 (Fy=36 KSI)
ANGLES, CHANNELS AND PLATES	ASTM A36 (Fy=36 KSI)
HIGH STRENGTH BOLTS	ASTM A325 OR A490
TWIST-OFF TENSION CONTROL BOLTS	ASTM F1552
HEAVY HEX NUTS	ASTM A563
HARDENED STEEL WASHERS	ASTM F436
DIRECT-TENSION-INDICATOR WASHER	ASTM F959
ANCHOR RODS	ASTM F1554 GR. 36 (Fy= 36 KSI)
SHEAR STUD CONNECTORS	ASTM A108 (Fu=65 KSI)



3. CONNECTIONS:
  - A. BOLTS SHALL BE HIGH-STRENGTH, BEARING TYPE IN SNUG TIGHT CONDITION, U.N.O. TIGHTEN BY AN AISC APPROVED METHOD.
  - B. WELDING ELECTRODES SHALL BE PER AWS D1.1. RETURN FILLET WELDS FOR FRAMED CONNECTIONS 1/2" AT EACH END.
  - C. LAP AND CONNECTIONS SHALL BE BOLTED, EXCEPT AS NOTED OTHERWISE.
- D. DETAIL FLOOR AND ROOF FRAMING CONNECTIONS FOLLOWING THE REQUIREMENTS SHOWN IN THE TYPICAL CONNECTION SCHEDULES SHOWN IN THESE DRAWINGS, BASED ON THE BEAM OR GIRDER SIZE.
- E. FOR THE PURPOSE OF CORRECTLY INTERPRETING THE CONNECTION SCHEDULES, GIRDERS SHALL BE CONSIDERED AS ANY FLOOR OR ROOF BEAM WHICH CARRIES OTHER FLOOR OR ROOF BEAMS, OR ANY FLOOR OR ROOF BEAM WHICH CARRIES STEEL COLUMNS.
- F. DETAIL DIAGONAL BRACING CONNECTIONS AS SHOWN IN THE DETAILS. IF NO DETAIL IS PROVIDED, DETAIL CONNECTION TO DEVELOP THE FULL TENSION CAPACITY OF THE DIAGONAL BRACING MEMBER.
- G. DETAIL MOMENT CONNECTIONS AS SHOWN IN THE DETAILS. IF NO DETAIL IS PROVIDED, DETAIL MOMENT CONNECTION USING FULL PENETRATION WELDS AT BEAM FLANGES.
- H. HIGH STRENGTH BOLTS IN BEARING CONDITION SUPPORTING SIMPLE SPAN BEAMS NOT SUBJECT TO AXIAL LOADS MAY BE INSTALLED TO "SNUG TIGHT" CONDITION. SHORT OR SHORT SLOTTED HOLES ARE USED. THE ENGINEER OF RECORD WILL BE THE ULTIMATE AUTHORITY IN THE USE OF "SNUG TIGHT" BOLTS. IF LONG SLOTTED OR OVERSIZED HOLES ARE USED, BOLTS MUST BE FULLY PRETENSIONED AND SLIP CRITICAL. PROPER SURFACE PREPARATION SHALL BE USED TO PREVENT CORROSION. INCLUDING OMISSION OF PRIMER OR FIRE PROOFING, AS APPROPRIATE.
- I. BOLTS SHARING LOAD WITH WELDS IN A CONNECTION SHALL BE FULLY PRETENSIONED AND SLIP CRITICAL.
- J. WHERE THE FULL YIELD STRENGTH OF SLIP CRITICAL BOLTS ARE REQUIRED, TIGHTENING SHALL BE ACHIEVED USING EITHER TWIST-OFF TENSION CONTROL BOLTS OR DIRECT TENSION INDICATING WASHERS.
- K. ALL STRUCTURAL STEEL EXPOSED TO EXTERIOR CONDITIONS SHALL BE HOT DIPPED GALVANIZED PER ASTM A123 AND ALL FASTENERS AND HARDWARE SHALL BE HOT DIPPED GALVANIZED PER ASTM A153.
- L. GROUT UNDER BEARING PLATES SHALL BE NON-METALLIC, NON-SHRINK TYPE WITH A COMPRESSIVE STRENGTH OF AT LEAST 5,000 PSI IN 28 DAYS.

- M. COMPOSITE FLOOR MEMBERS ARE DESIGNED TO BE UNSHORED UNLESS OTHERWISE NOTED. THE WEIGHT OF THE WET CONCRETE WILL RESULT IN DEFLECTIONS OF THE SUPPORTING STEEL DECK, BEAMS, AND GIRDERS. ALL OVERRUNS OF CONCRETE QUANTITIES ARE TO BE ANTICIPATED AND INCLUDED IN THE CONTRACTOR'S BID. THE CONTRACTOR SHALL COORDINATE EMBEDDED ITEMS REQUIRED FOR ARCHITECTURAL, STRUCTURAL, AND MECHANICAL



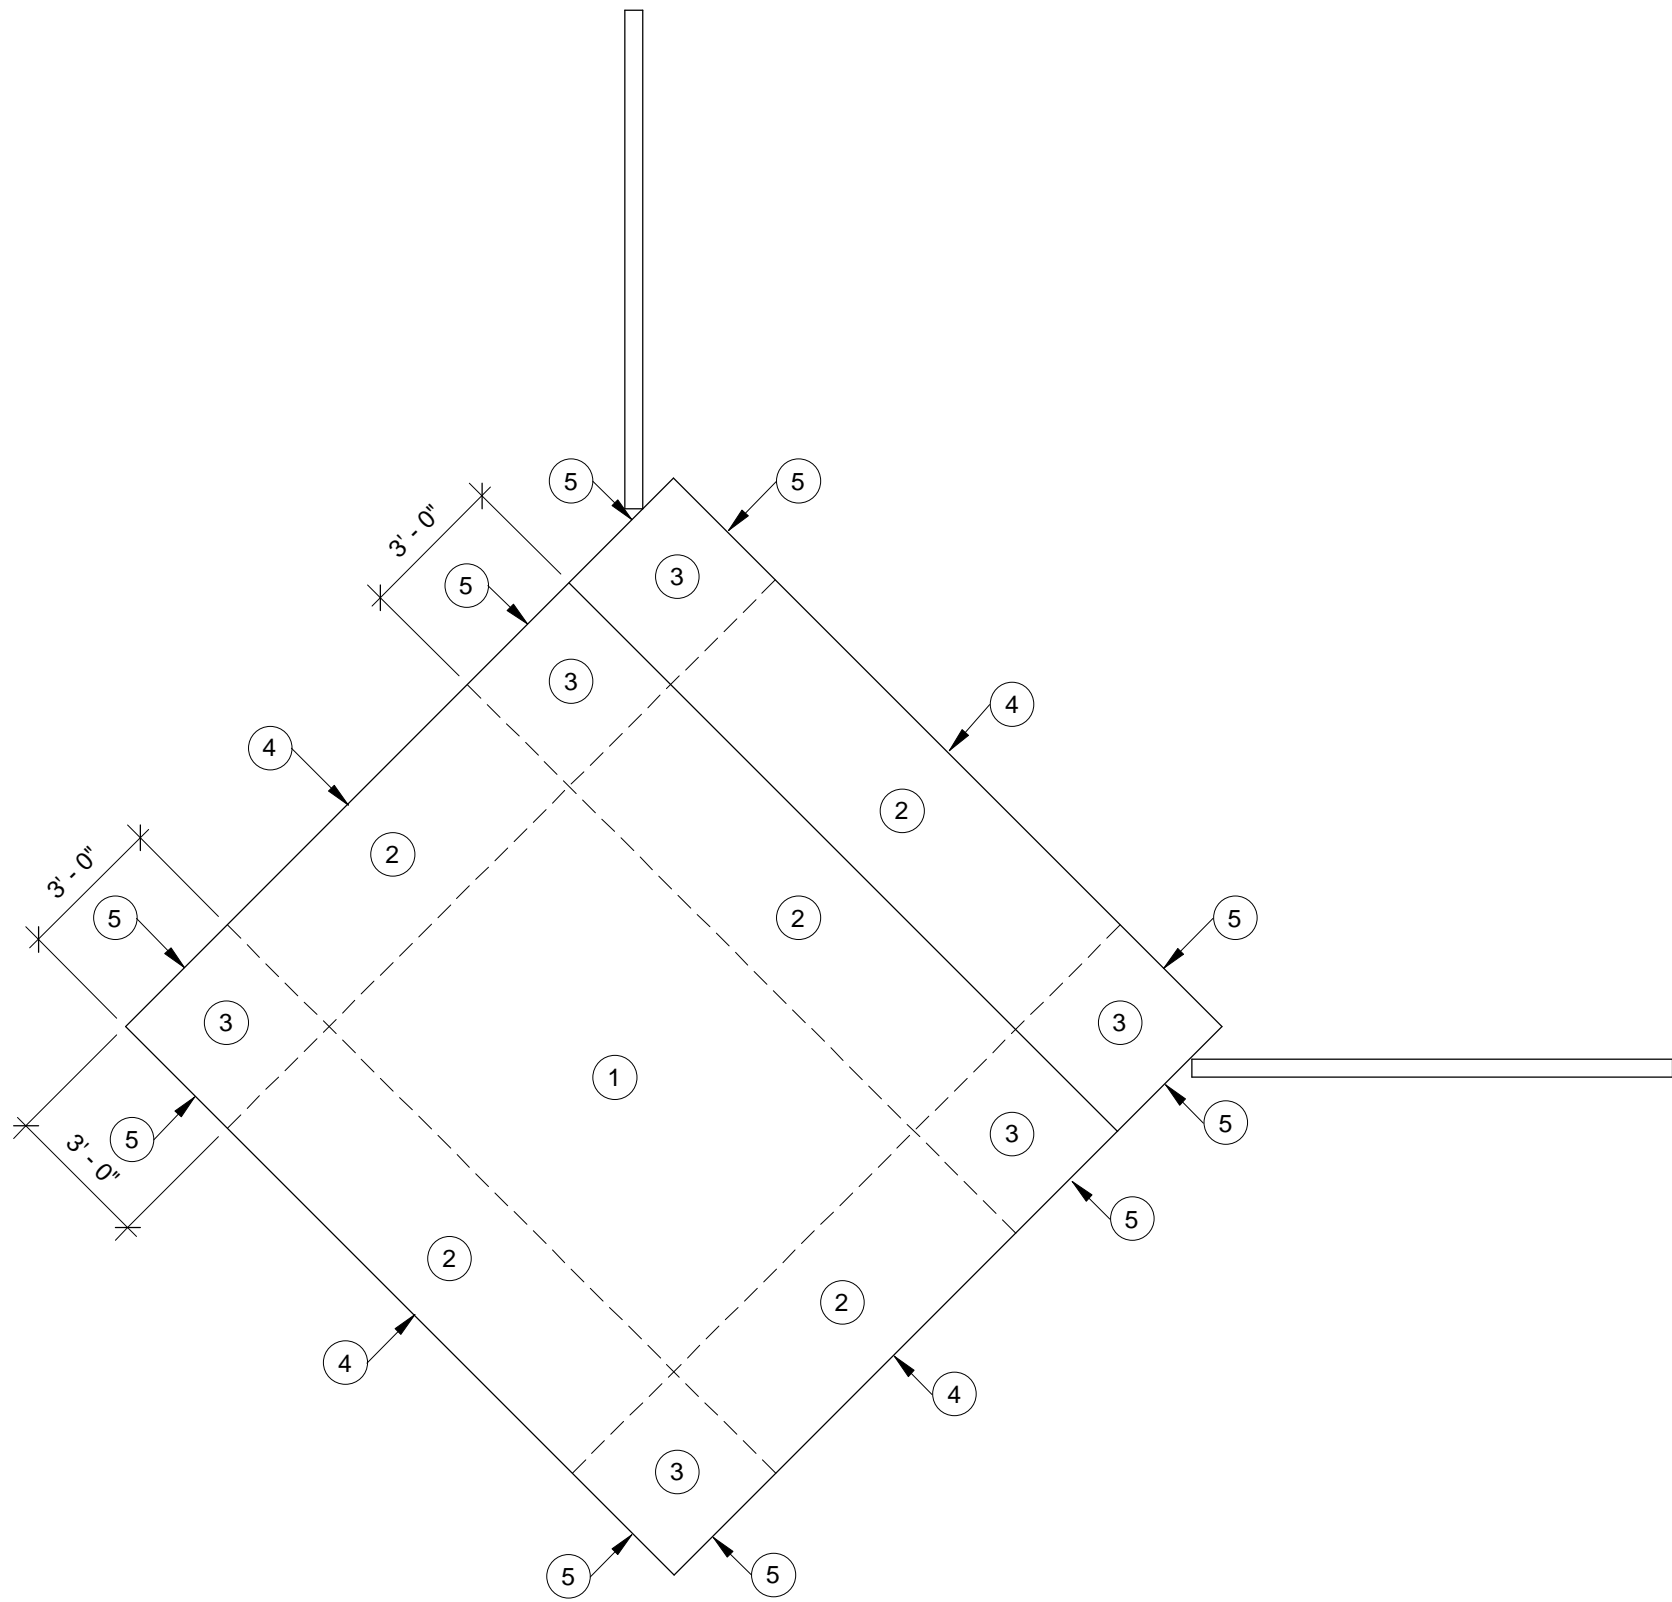

2 WIND LOAD DIAGRAM - ZONE A  
1/4" = 1'-0"

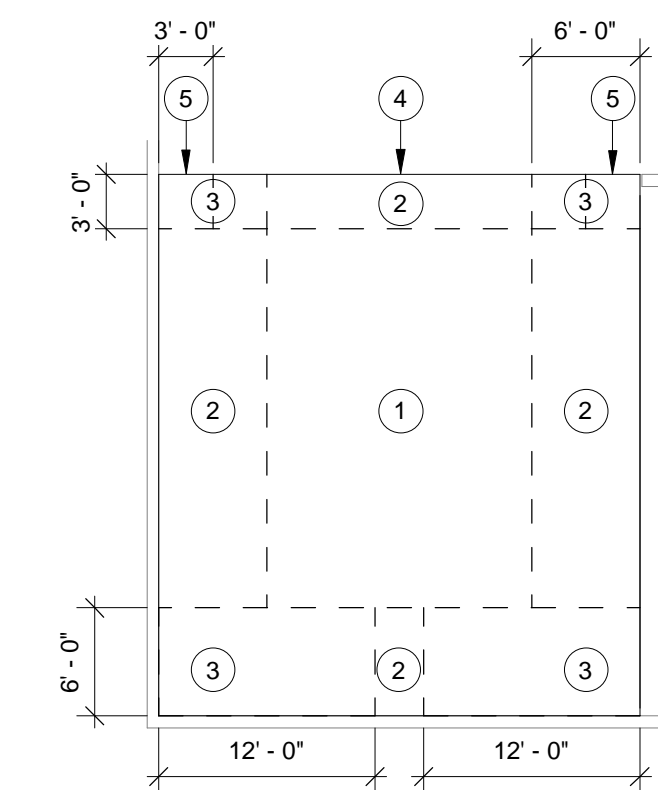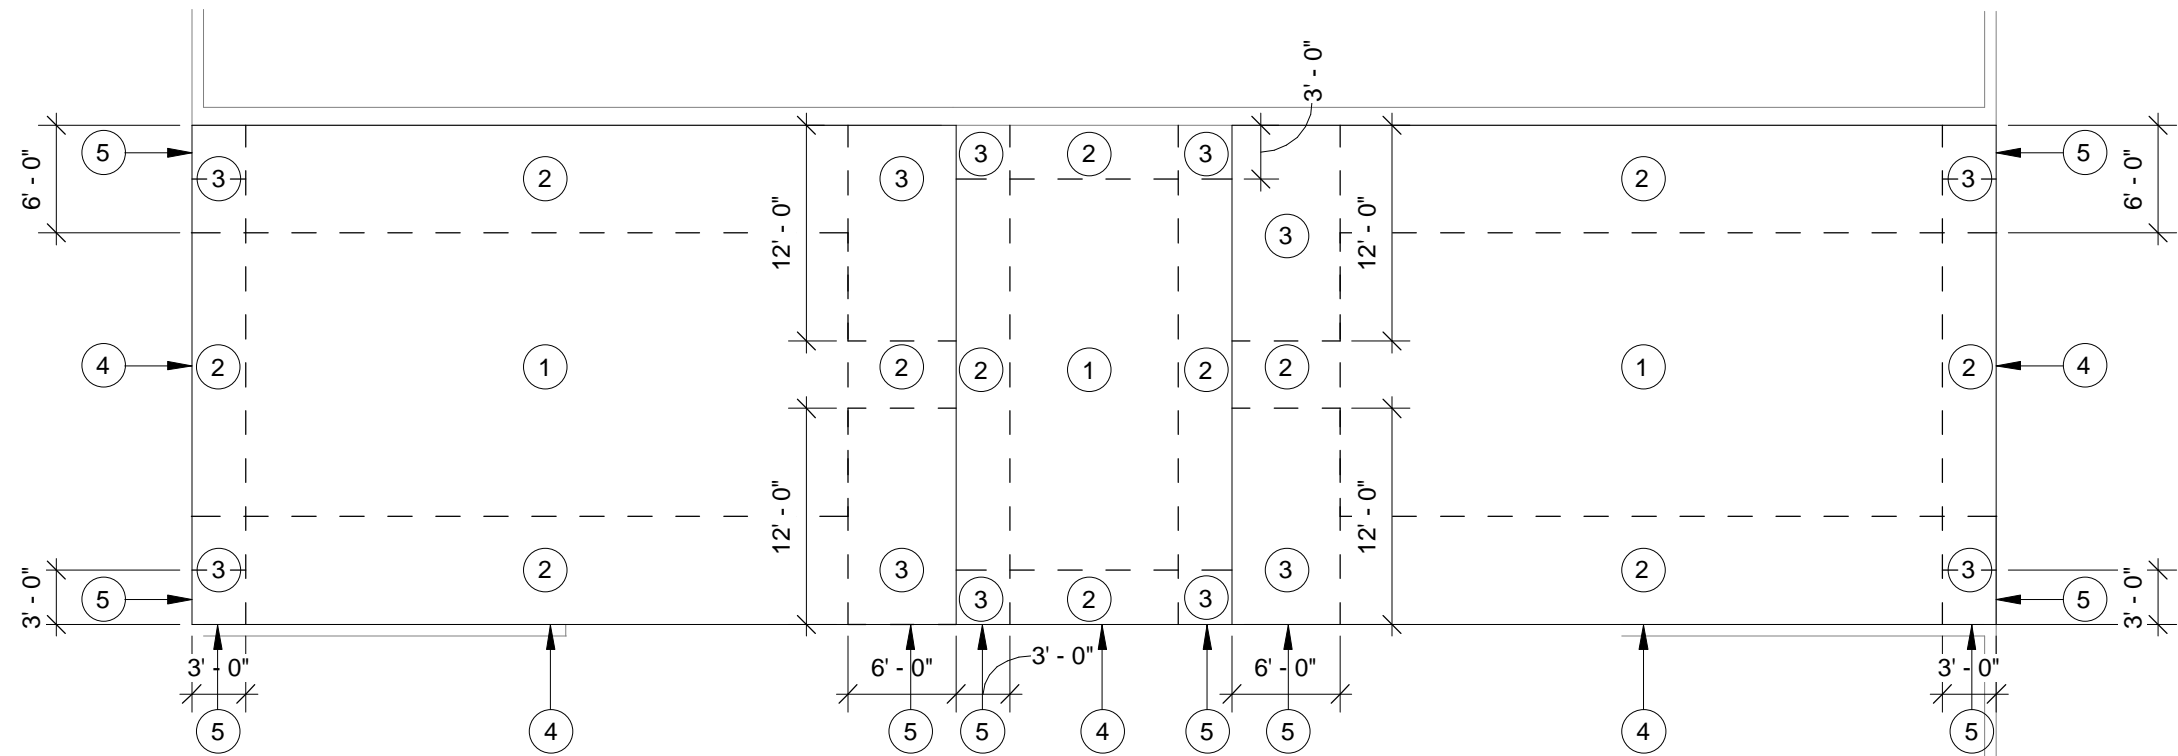


3 WIND LOAD DIAGRAM - ZONE B  
3/32" = 1'-0"


NOMINAL C&C WIND PRESSURES (ASCE 7-10)									
BUILDING	a (FT)	Vult (MPH)	Vasd (MPH)	A (SF)	ZONE 1 (PSF)	ZONE 2 (PSF)	ZONE 3 (PSF)	ZONE 4 (PSF)	ZONE 5 (PSF)
ZONE A	3	140	108	<10	+12.2 -19.4	+12.2 -33.7	+12.2 -49.8	+21.2 -23.0	+21.2 -28.3
				20	+11.1 -18.8	+11.1 -31.0	+11.1 -46.6	+20.2 -22.0	+20.2 -26.4
				50	+9.7 -18.1	+9.7 -27.4	+9.7 -42.3	+18.9 -20.7	+18.9 -26.4
				100+	+9.6 -17.6	+9.6 -24.7	+9.6 -39.1	+18.0 -19.8	+18.0 -22.0
ZONE B	3	140	108	<10	+9.6 -23.0	+9.6 -26.5	+9.6 -35.5	+19.4 -23.0	+19.4 -28.3
				20	+9.6 -23.0	+9.6 -26.0	+9.6 -32.3	+18.5 -22.0	+18.5 -26.4
				50	+9.6 -23.0	+9.6 -25.3	+9.6 -28.0	+17.4 -20.7	+17.4 -23.9
				100+	+9.6 -23.0	+9.6 -24.7	+9.6 -24.7	+16.5 -19.7	+16.5 -22.0

NOMINAL C&C WIND PRESSURE PLAN NOTES:

- PRESSURES SHOWN ABOVE ARE NOMINAL COMPONENTS AND CLADDING PRESSURES, CONVERTED FROM ULTIMATE PRESSURES USING A 0.6 MULTIPLIER FACTOR. NO FURTHER REDUCTION IS ALLOWED.  
A - INDICATES TRIBUTARY AREA IN S.F.  
a - INDICATES END ZONE WIDTH IN FT.  
Vult - INDICATES ULTIMATE DESIGN WIND SPEED IN MPH  
Vasd - INDICATES NOMINAL DESIGN WIND SPEED IN MPH
- GROSS PRESSURES ARE FOR JOISTS, WINDOWS, DOORS, VENEER, LIGHT GAGE METAL FRAMING, METAL DECK ATTACHMENTS, ROOFING, ROOFING ACCESSORIES AND OTHER BUILDING COMPONENTS AND CLADDING.
- GROSS PRESSURES SHALL BE LINEARLY INTERPOLATED FOR (A) NOT SHOWN IN TABLE.
- POSITIVE PRESSURES INDICATE PRESSURES ACTING TOWARD A PROJECTED SURFACE. NEGATIVE PRESSURES INDICATE PRESSURES ACTING AWAY FROM A PROJECTED SURFACE.
- ROOF AND ZONES 1 THRU 3
- WALL ZONES 4 AND 5
- NET DESIGN ROOF PRESSURES SHALL BE CALCULATED USING THE SELFWEIGHT (DEAD LOAD) OF THE MATERIALS. HOWEVER, THE MAXIMUM REDUCTION OF WIND UPLIFT PRESSURES SHALL BE LIMITED TO THE SELF WEIGHT OF THE ROOF SYSTEM PLUS 5 PSF FOR SUPERIMPOSED DEAD LOADS.
- INTERNAL PRESSURE COEFFICIENT FOR ENCLOSED BUILDING EQUALS +0.18 AND -0.18  
INTERNAL PRESSURE COEFFICIENT FOR OPEN STRUCTURE EQUALS +/- 0.00  
INTERNAL PRESSURE COEFFICIENT FOR PARTIALLY ENCLOSED STRUCTURE EQUALS +/- 0.55
- ROOF TOP EQUIPMENT SHALL BE DESIGNED FOR A LATERAL PRESSURE OF 67.3 PSF AND A SIMULTANEOUS UPLIFT PRESSURE OF 32.6 PSF (ROOF TOP EQUIPMENT PER FBC SECTION 1620.6 WITH Qh = 21.7 PSF)
- AT ALCOVES AND CANOPIES, THE TOTAL UPLIFT PRESSURE ON THE ALCOVE SOFFIT OR CANOPY SHALL EQUAL THE WALL PRESSURE IN THAT AREA.
- PARAPET DESIGN WIND PRESSURE LOAD CASES: ZONE B  
LOAD CASE 1: OUTSIDE FACE: +23.4 PSF (ZONE 4) AND +23.4 PSF (ZONE 5)  
INSIDE FACE: -53.7 PSF (ZONE 2) AND -73.3 PSF (ZONE 3)  
LOAD CASE 2: OUTSIDE FACE: -23.4 PSF (ZONE 4) AND -42.9 PSF (ZONE 5)  
INSIDE FACE: +23.4 PSF  
NOTE THAT CASE 1 & CASE 2 WIND PRESSURES ARE APPLIED INDEPENDENTLY.

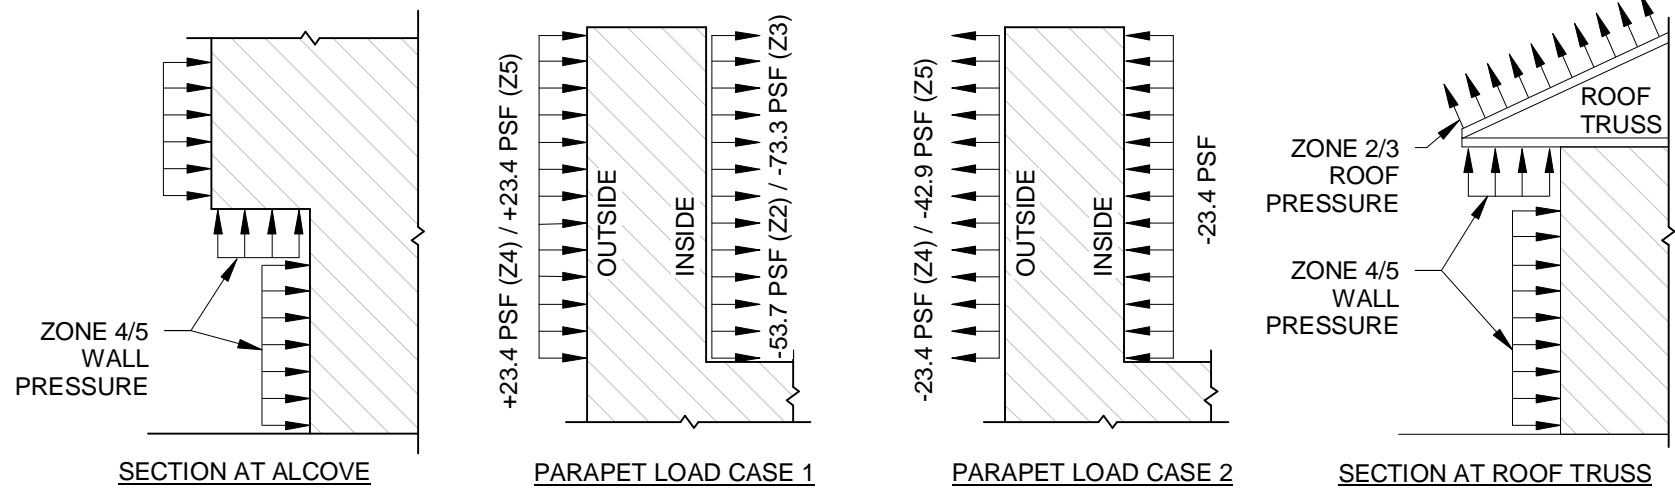

KEY PLAN

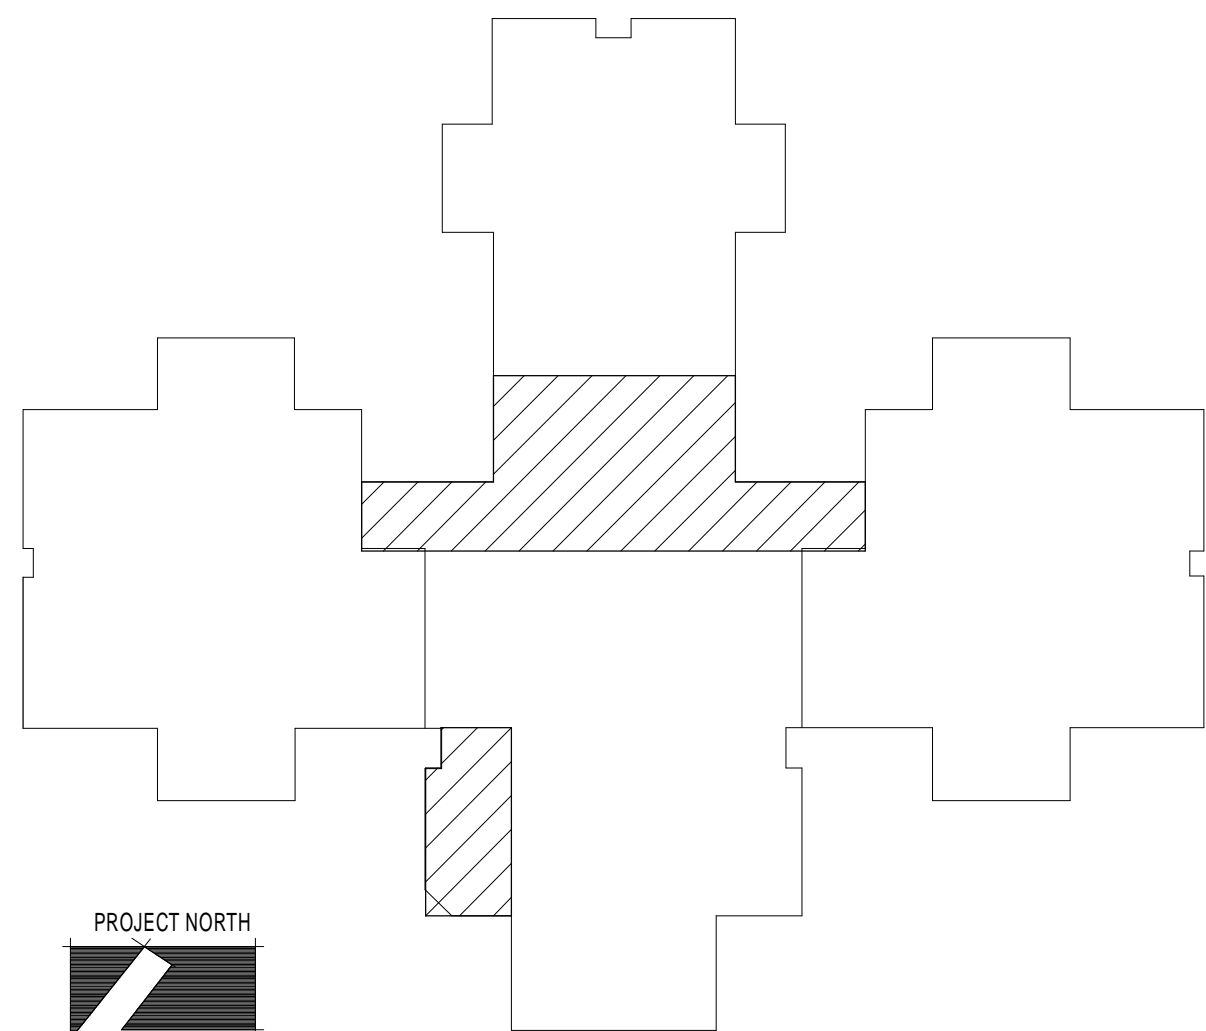


REVISIONS AND UPDATES

02/14/14	CONSTRUCTION DOCUMENTS FOR BID/PERMIT

SUWANNEE COUNTY SCHOOL BOARD  
SUWANNEE PRIMARY SCHOOL  
ADDITIONS AND REMODELING  
1625 WALKER AVE., SW LIVE OAK, FLORIDA

WIND LOAD DIAGRAM


drawn SES checked GCK approved GCK

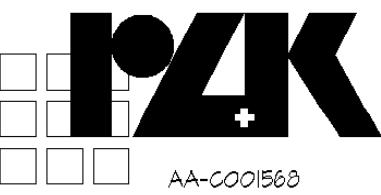

job no. 2012.51

S-0.3


ARCHITECTS RZK, INC.  
600 FLORIDA AVENUE SUITE 202 COCOA, FLORIDA 32922 TELEPHONE (321) 631-8039

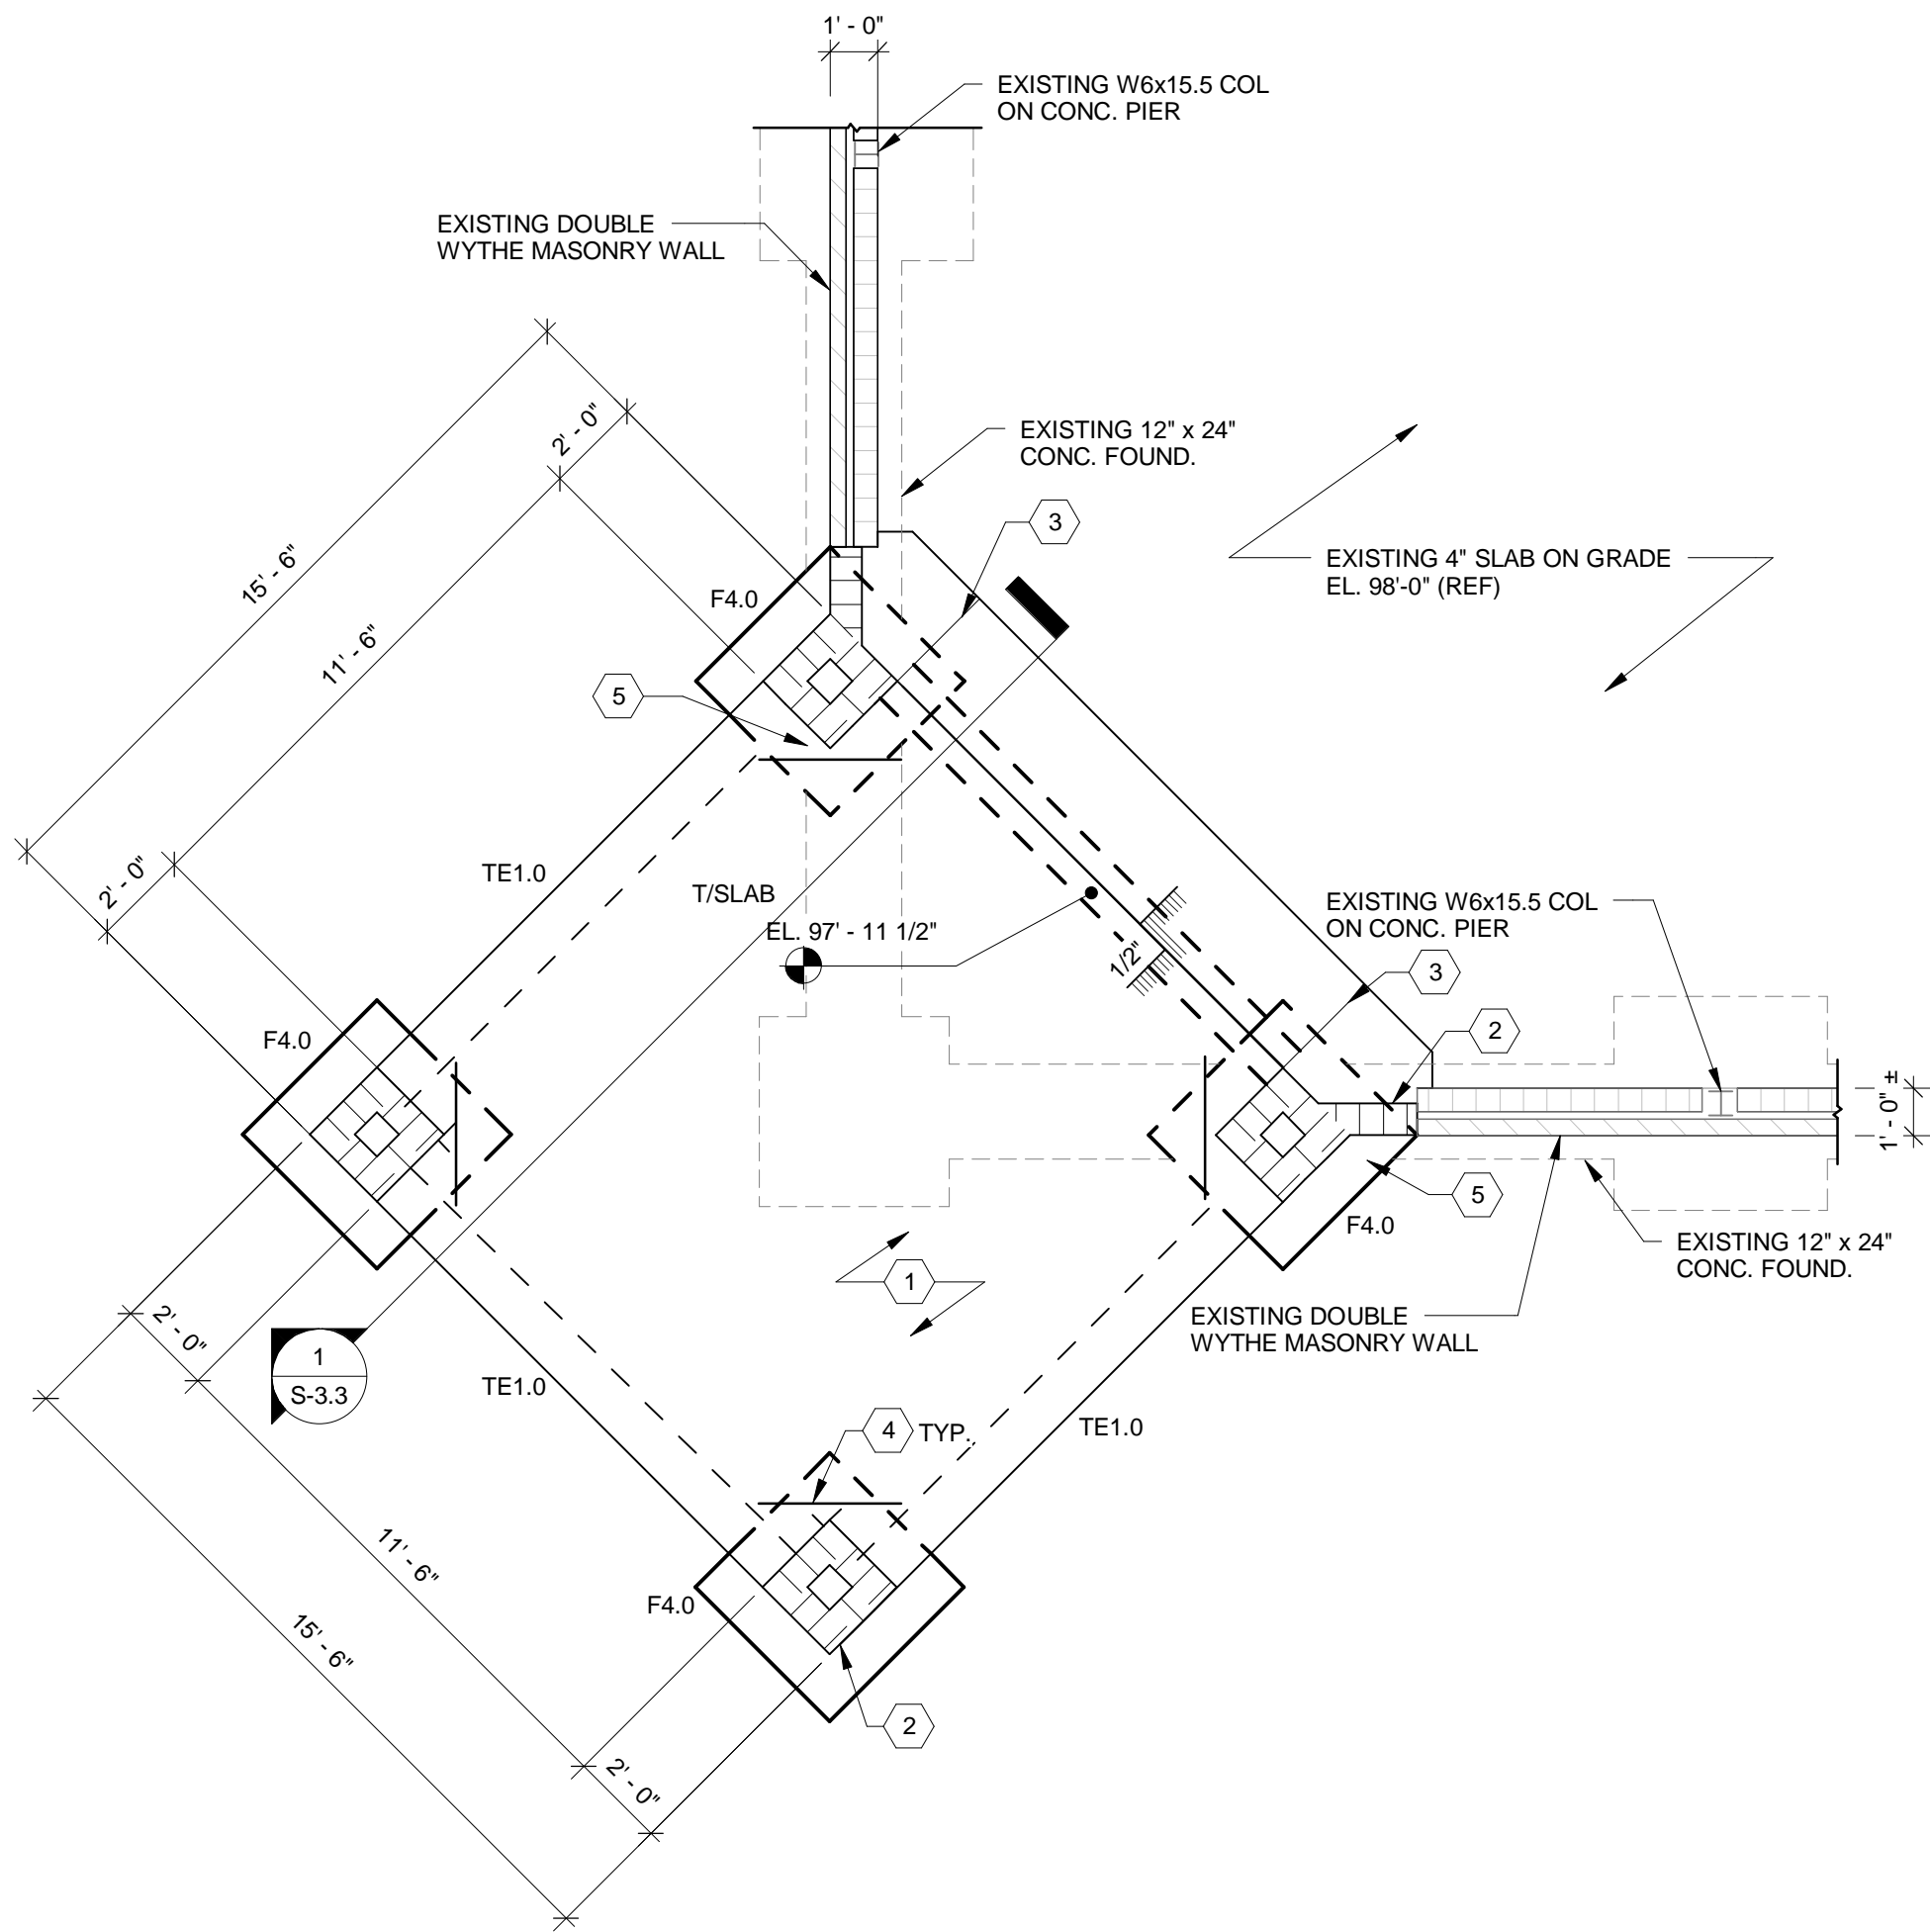

1 FOUNDATION PLAN - ZONE A  
1/4" = 1'-0"  
T / SLAB EL. 98'-00" MATCH EXISTING TYP. U.N.O.  
T / FDN EL. 96'-00" MATCH EXISTING

FOUNDATION PLAN NOTES

- 1 4" CONCRETE SLAB ON GRADE REINFORCED W/ 6X6-W2.9XW2.9 WWF ON 15 MIL GLASS A VAPOR RETARDER ON COMPACTED FILL. SLOPE PER ARCHITECTURAL PLANS.
- 2 8" CMU LOAD BEARING WALL REINFORCED WITH #5 AT 24" O.C. AND AT WALL CORNERS, TERMINATIONS, DOOR JAMBS, AND INTERSECTIONS IN GROUT FILLED CELLS.
- 3 PROVIDE SAW CUT CONTROL JOINTS (C.J.) AT LOCATIONS INDICATED ON PLANS THROUGHOUT ENTIRE SLAB ON GRADE. SEE TYPICAL SLAB ON GRADE CONTROL JOINT DETAIL.
- 4 #4 x 3'-0" CRACK CONTROL REINFORCING AT MID DEPTH OF SLAB
- 5 DEMOLISH AND REMOVE EXISTING FOUNDATION AS REQUIRED TO ACCOMMODATE NEW CONSTRUCTION.

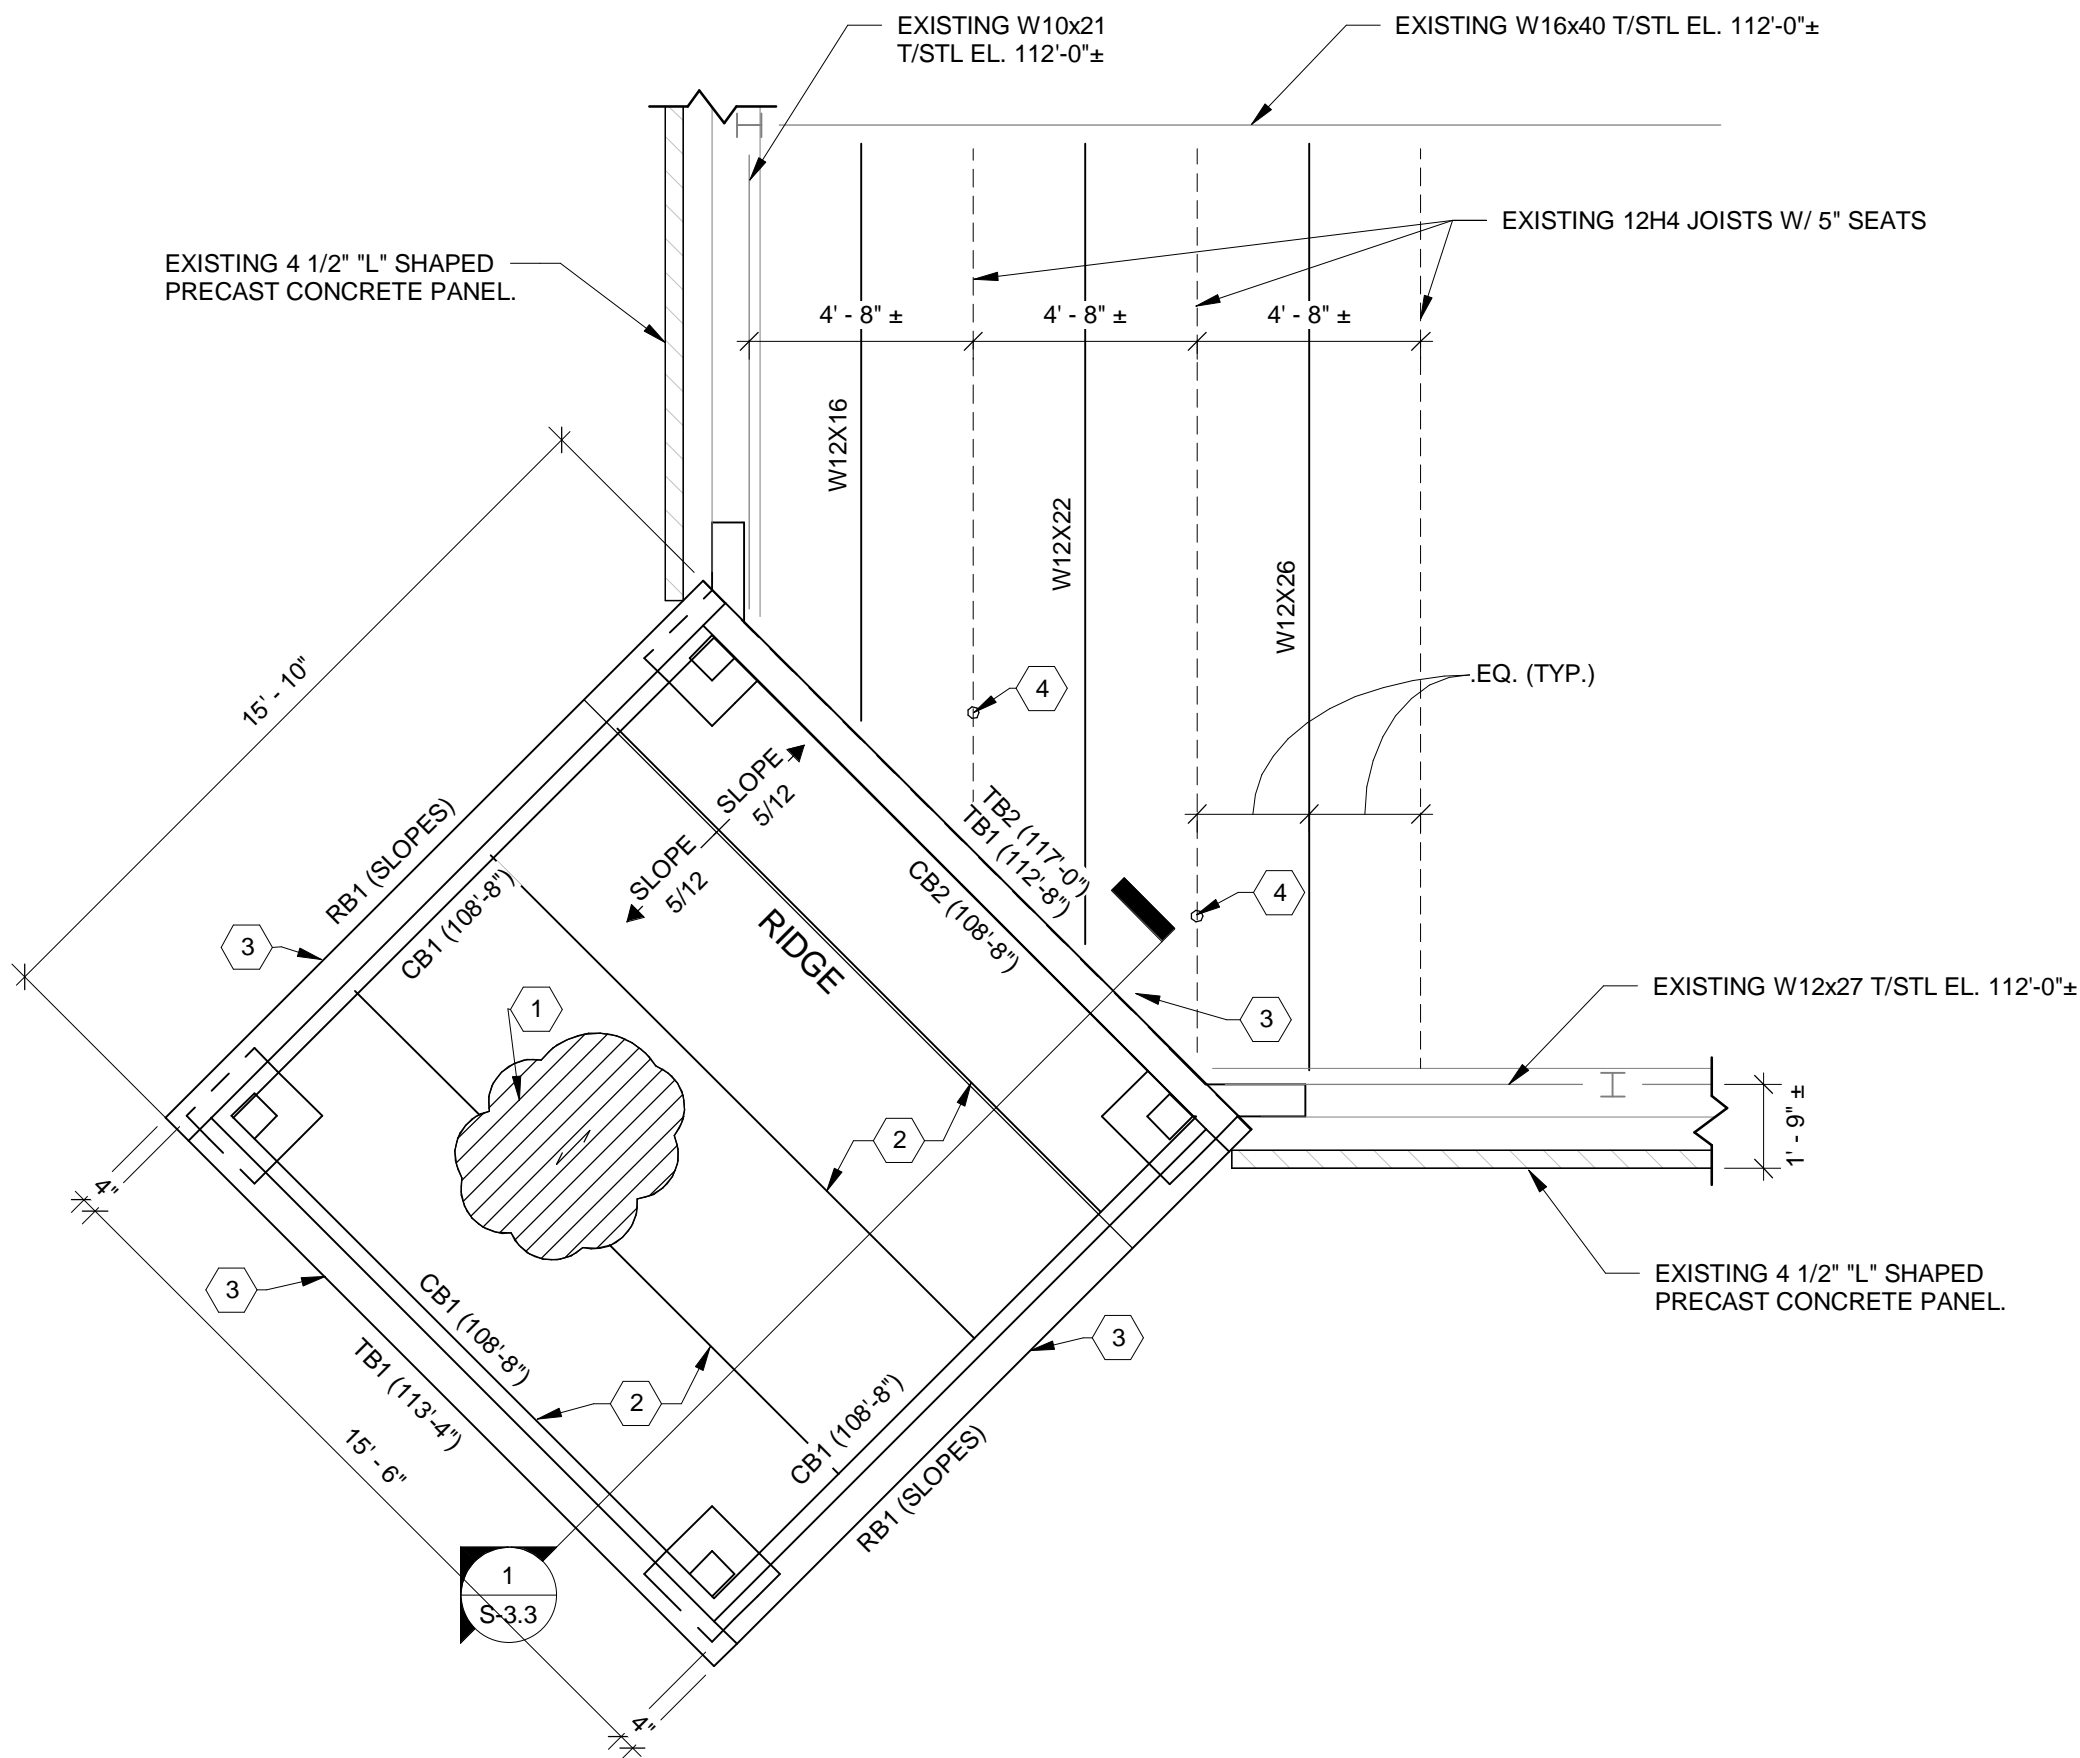


2 ROOF FRAMING PLAN - ZONE A  
1/4" = 1'-0"  
T / TB1 EL. VARIES  
T / STL EL. 112'-5"± (MATCH EXISTING)

ROOF FRAMING PLAN NOTES

- 1 1 1/2", 22 GA G60 GALVANIZED ROOF DECK (VULCRAFT TYPE B OR APPROVED EQUAL)
- 2 C8x11.5 PURLINS @ 5' - 0" O.C. MAX. TO SUPPORT ROOF DECK AND SOFFIT. INCLINE C8'S TO MATCH ROOF SLOPE. REFER TO SECTION FOR ADDITIONAL INFORMATION.
- 3 8" CMU LOAD BEARING WALL REINFORCED WITH #5 AT 32" O.C. AND AT WALL CORNERS, TERMINATIONS, DOOR JAMBS, AND INTERSECTIONS IN GROUT FILLED CELLS.
- 4 TEMPORARILY SHORE EXISTING 12H4 ROOF JOISTS AT BOTTOM PANEL POINTS UNTIL NEW W12 BEAMS ARE INSTALLED.
- 5 INSTALL NEW W12 BEAMS EQUIDISTANT BETWEEN EXISTING JOISTS. (3 LOCATIONS) INSTALL TIGHT TO UNDERSIDE OF DECK PRIOR TO REMOVAL OF JOIST SHORES.

KEY PLAN

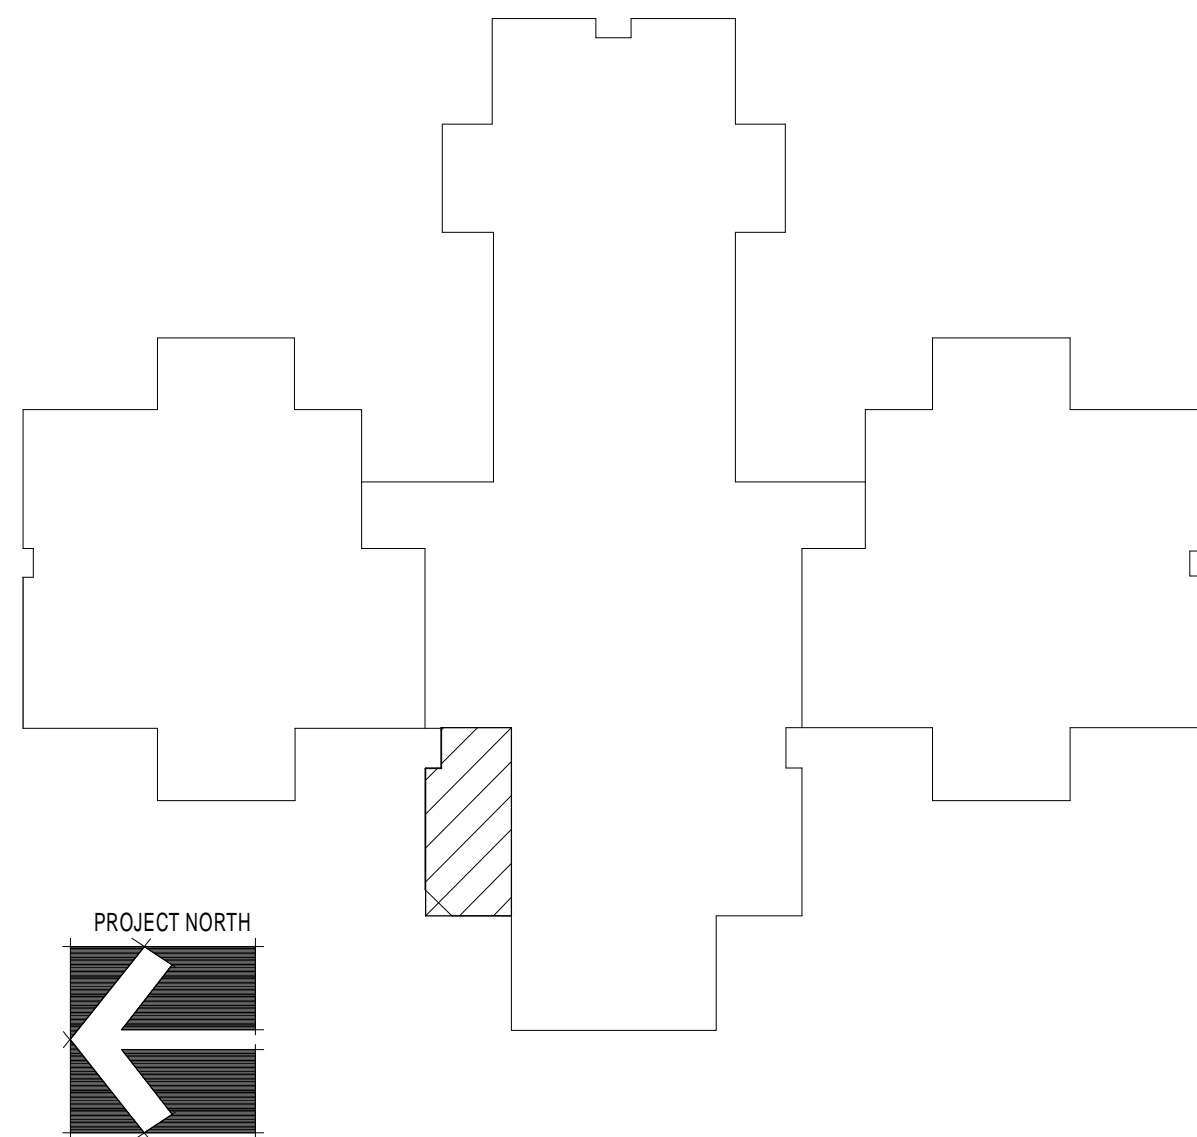


REVISIONS AND UPDATES

DATE	DESCRIPTION
02/14/14	CONSTRUCTION DOCUMENTS FOR BID/PERMIT

SUWANNEE COUNTY SCHOOL BOARD  
SUWANNEE PRIMARY SCHOOL  
ADDITIONS AND REMODELING  
1625 WALKER AVE., SW      LIVE OAK, FLORIDA  
FOUNDATION AND FRAMING ZONE A

drawn SES      checked GCK      approved GCK

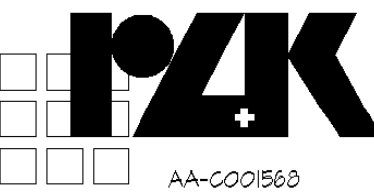


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job no. 2012.51

S-1.1





Seal

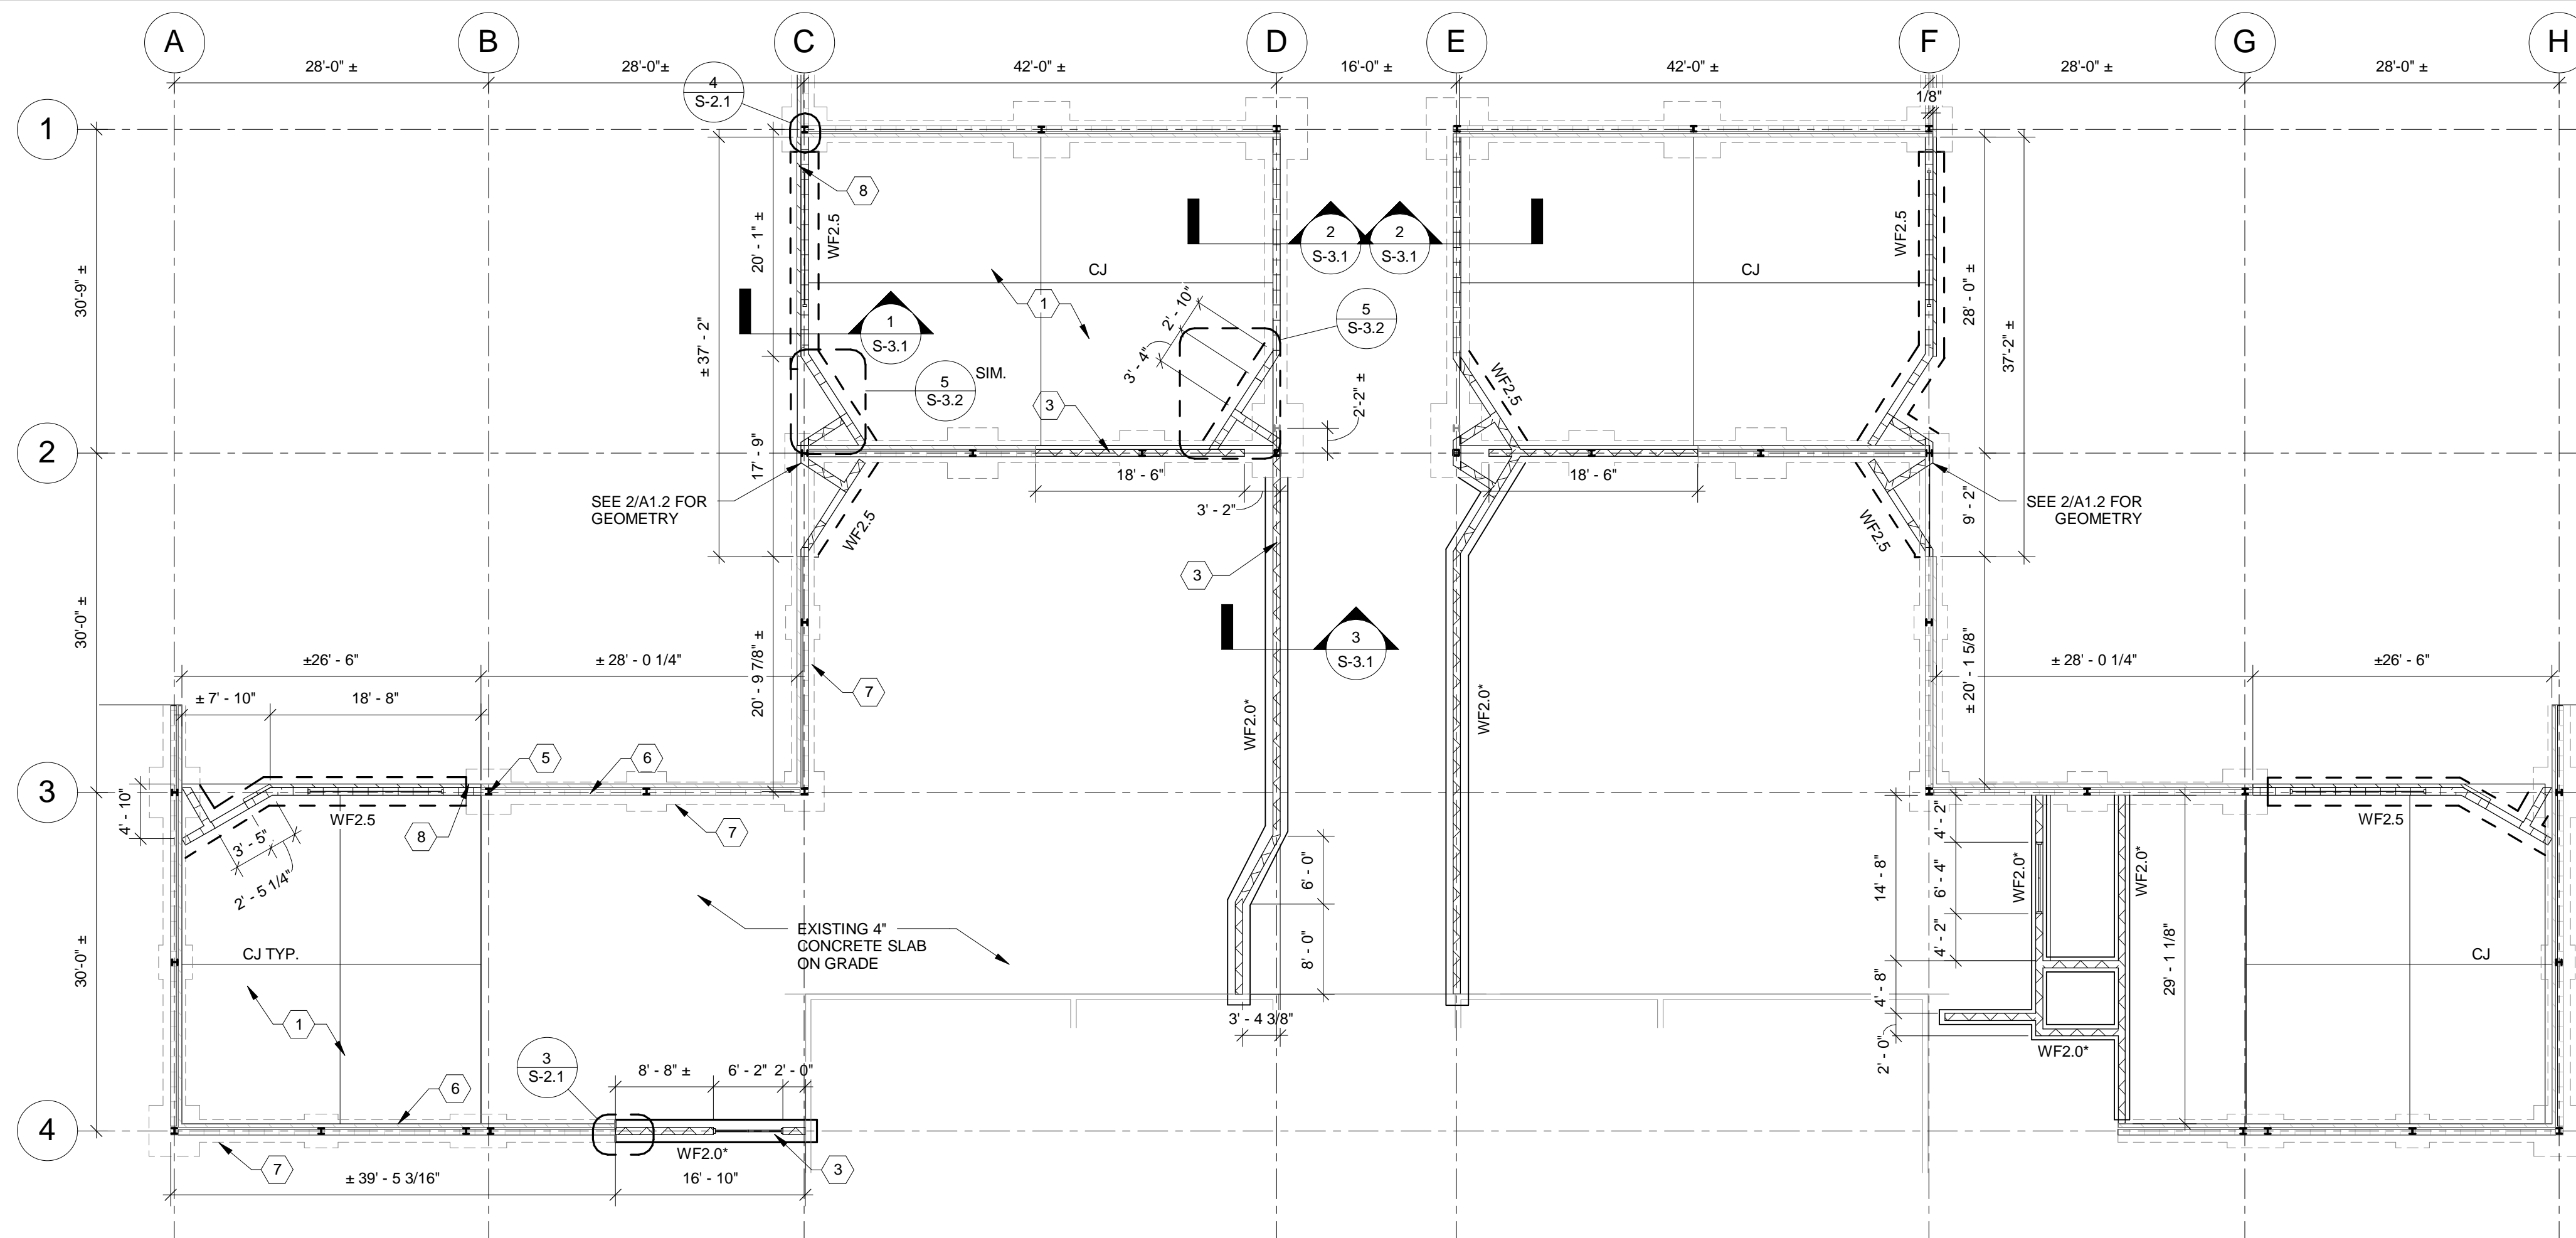





FOUNDATION PLAN - ZONE B



- ① 4" CONCRETE SLAB ON GRADE REINFORCED W/ 6X6-  
20.9X2W.9 WWF ON 15 MIL CLASS A VAPOR BARRIER ON  
COMPACTED FILL.
- ②  8" LOAD BEARING CMU WALL REINFORCED W/ #5 AT  
32" O.C. AND AT WALL CORNERS, TERMINATIONS, DOOR  
JAMBS, AND INTERSECTIONS IN GROUT FILLED CELLS.
- ③  8" NON LOAD BEARING CMU WALL REINFORCED W/ #5  
AT 8" O.C. AND AT WALL CORNERS, TERMINATIONS,  
DOOR JAMBS, AND INTERSECTIONS IN GROUT FILLED CELLS.
- ④ PROVIDE SAW CUT CONTROL JOINTS (C.J.) AT LOCATIONS  
INDICATED ON PLANS THROUGHOUT ENTIRE SLAB ON GRADE,  
SEE TYPICAL SLAB ON GRADE CONTROL JOINT DETAIL.
- ⑤ **I** EXISTING W/6 STRUCTURAL COLUMN (TYP.) SET ON  
12" SQ CONCRETE PIER AND SPREAD FOUNDATION.
- ⑥  EXISTING DOUBLE WYTHE CMU WALL (4" BRICK + 6"  
CMU - 12" TOTAL).
- ⑦ EXISTING 12" X 24" CONTINUOUS STRIP FOUNDATION.
- ⑧  BRICK VENEER, SEE ARCHITECTURAL DRAWINGS.

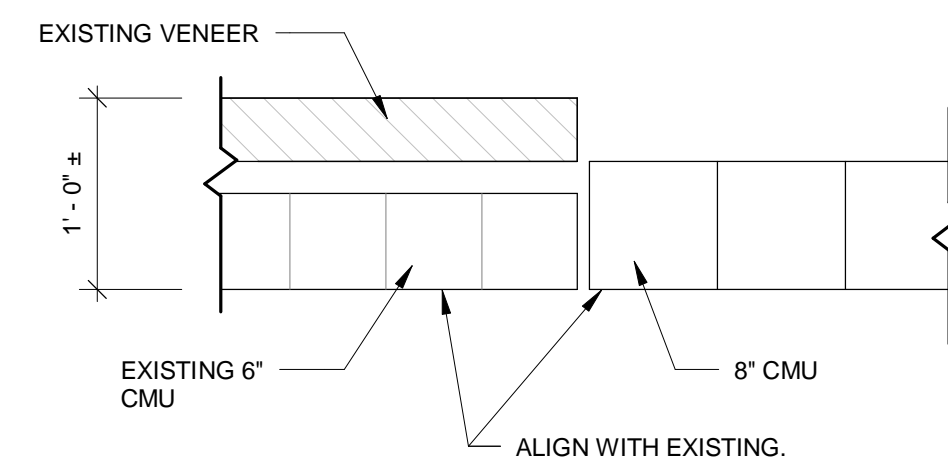


③ EXISTING TO NEW WALL  
1" = 1'-0"

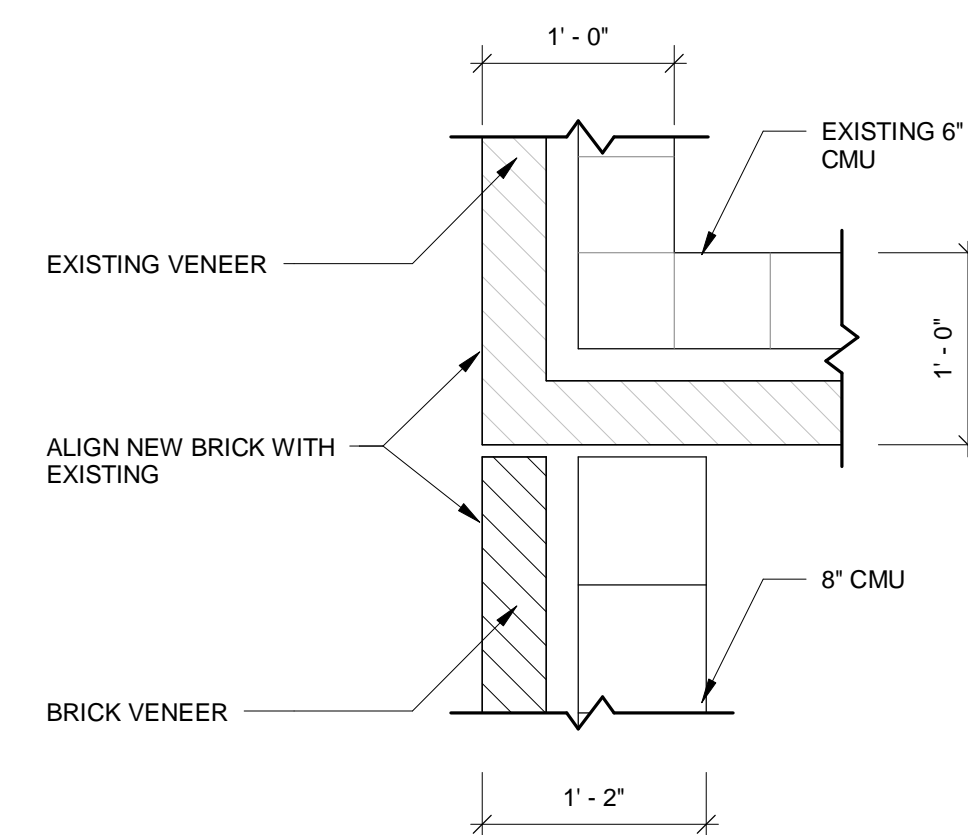

4 WALL CORNER  
1" = 1'-0"

## KEY PLAN

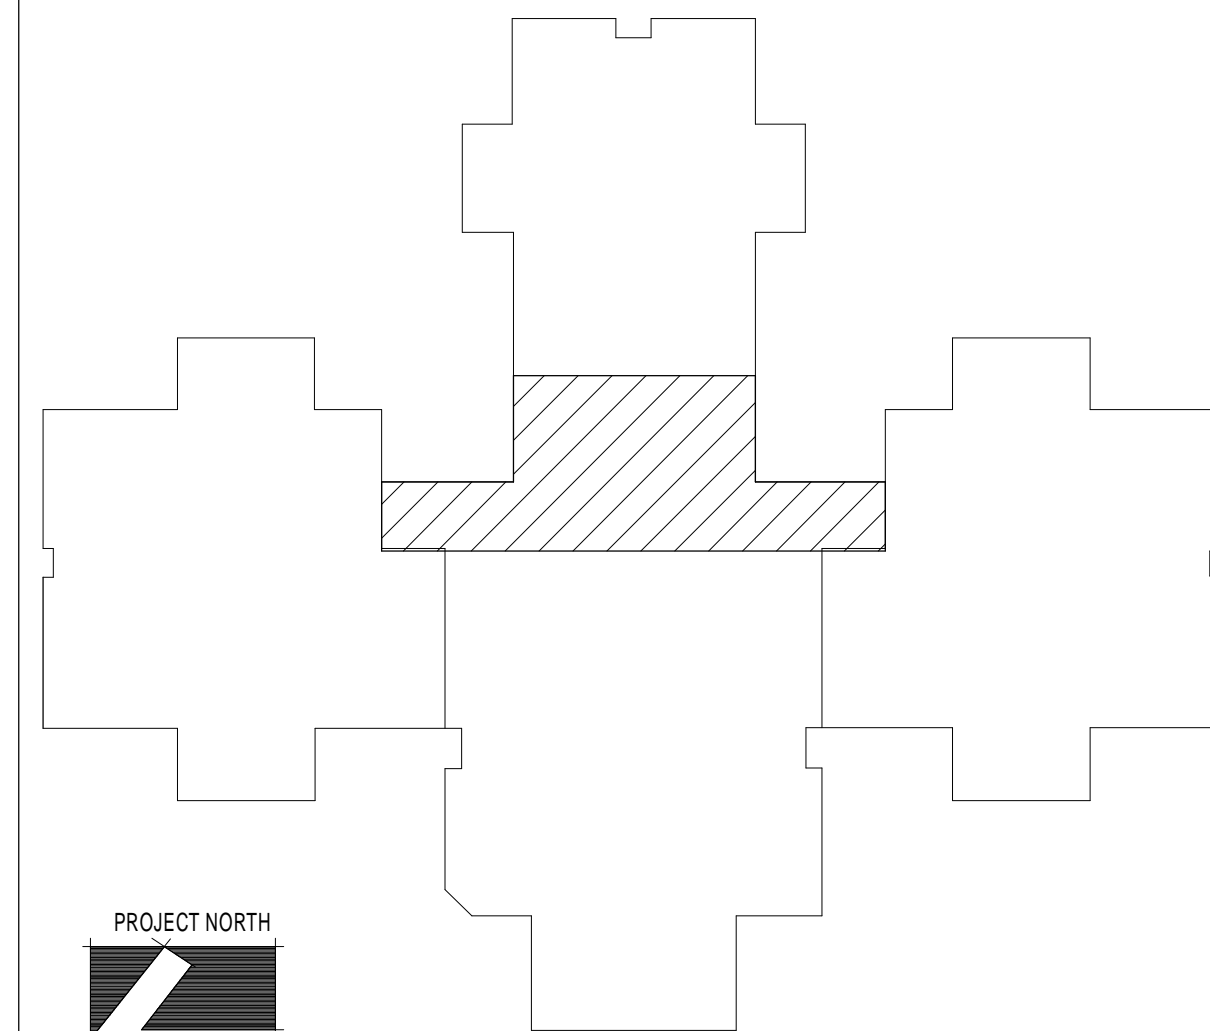

## REVISIONS AND UPDATES

02/14/14		CONSTRUCTION DOCUMENTS FOR BID/PERMIT

SUWANNEE COUNTY SCHOOL BOARD <b>SUWANNEE PRIMARY SCHOOL</b> <b>ADDITIONS AND REMODELING</b> 1625 WALKER AVE., SW <span style="float: right;">LIVE OAK, FLORIDA</span>	
<b>FOUNDATION AND FRAMING ZONE B</b>	


drawn SES checked GCK approved GCK

**PAK**  
AA-C001568

job no. 2012.51

S-2.1

**ARCHITECTS RZK, INC.**  
600 FLORIDA AVENUE SUITE 202 COCOA, FLORIDA 32922 TELEPHONE (321) 631-8039

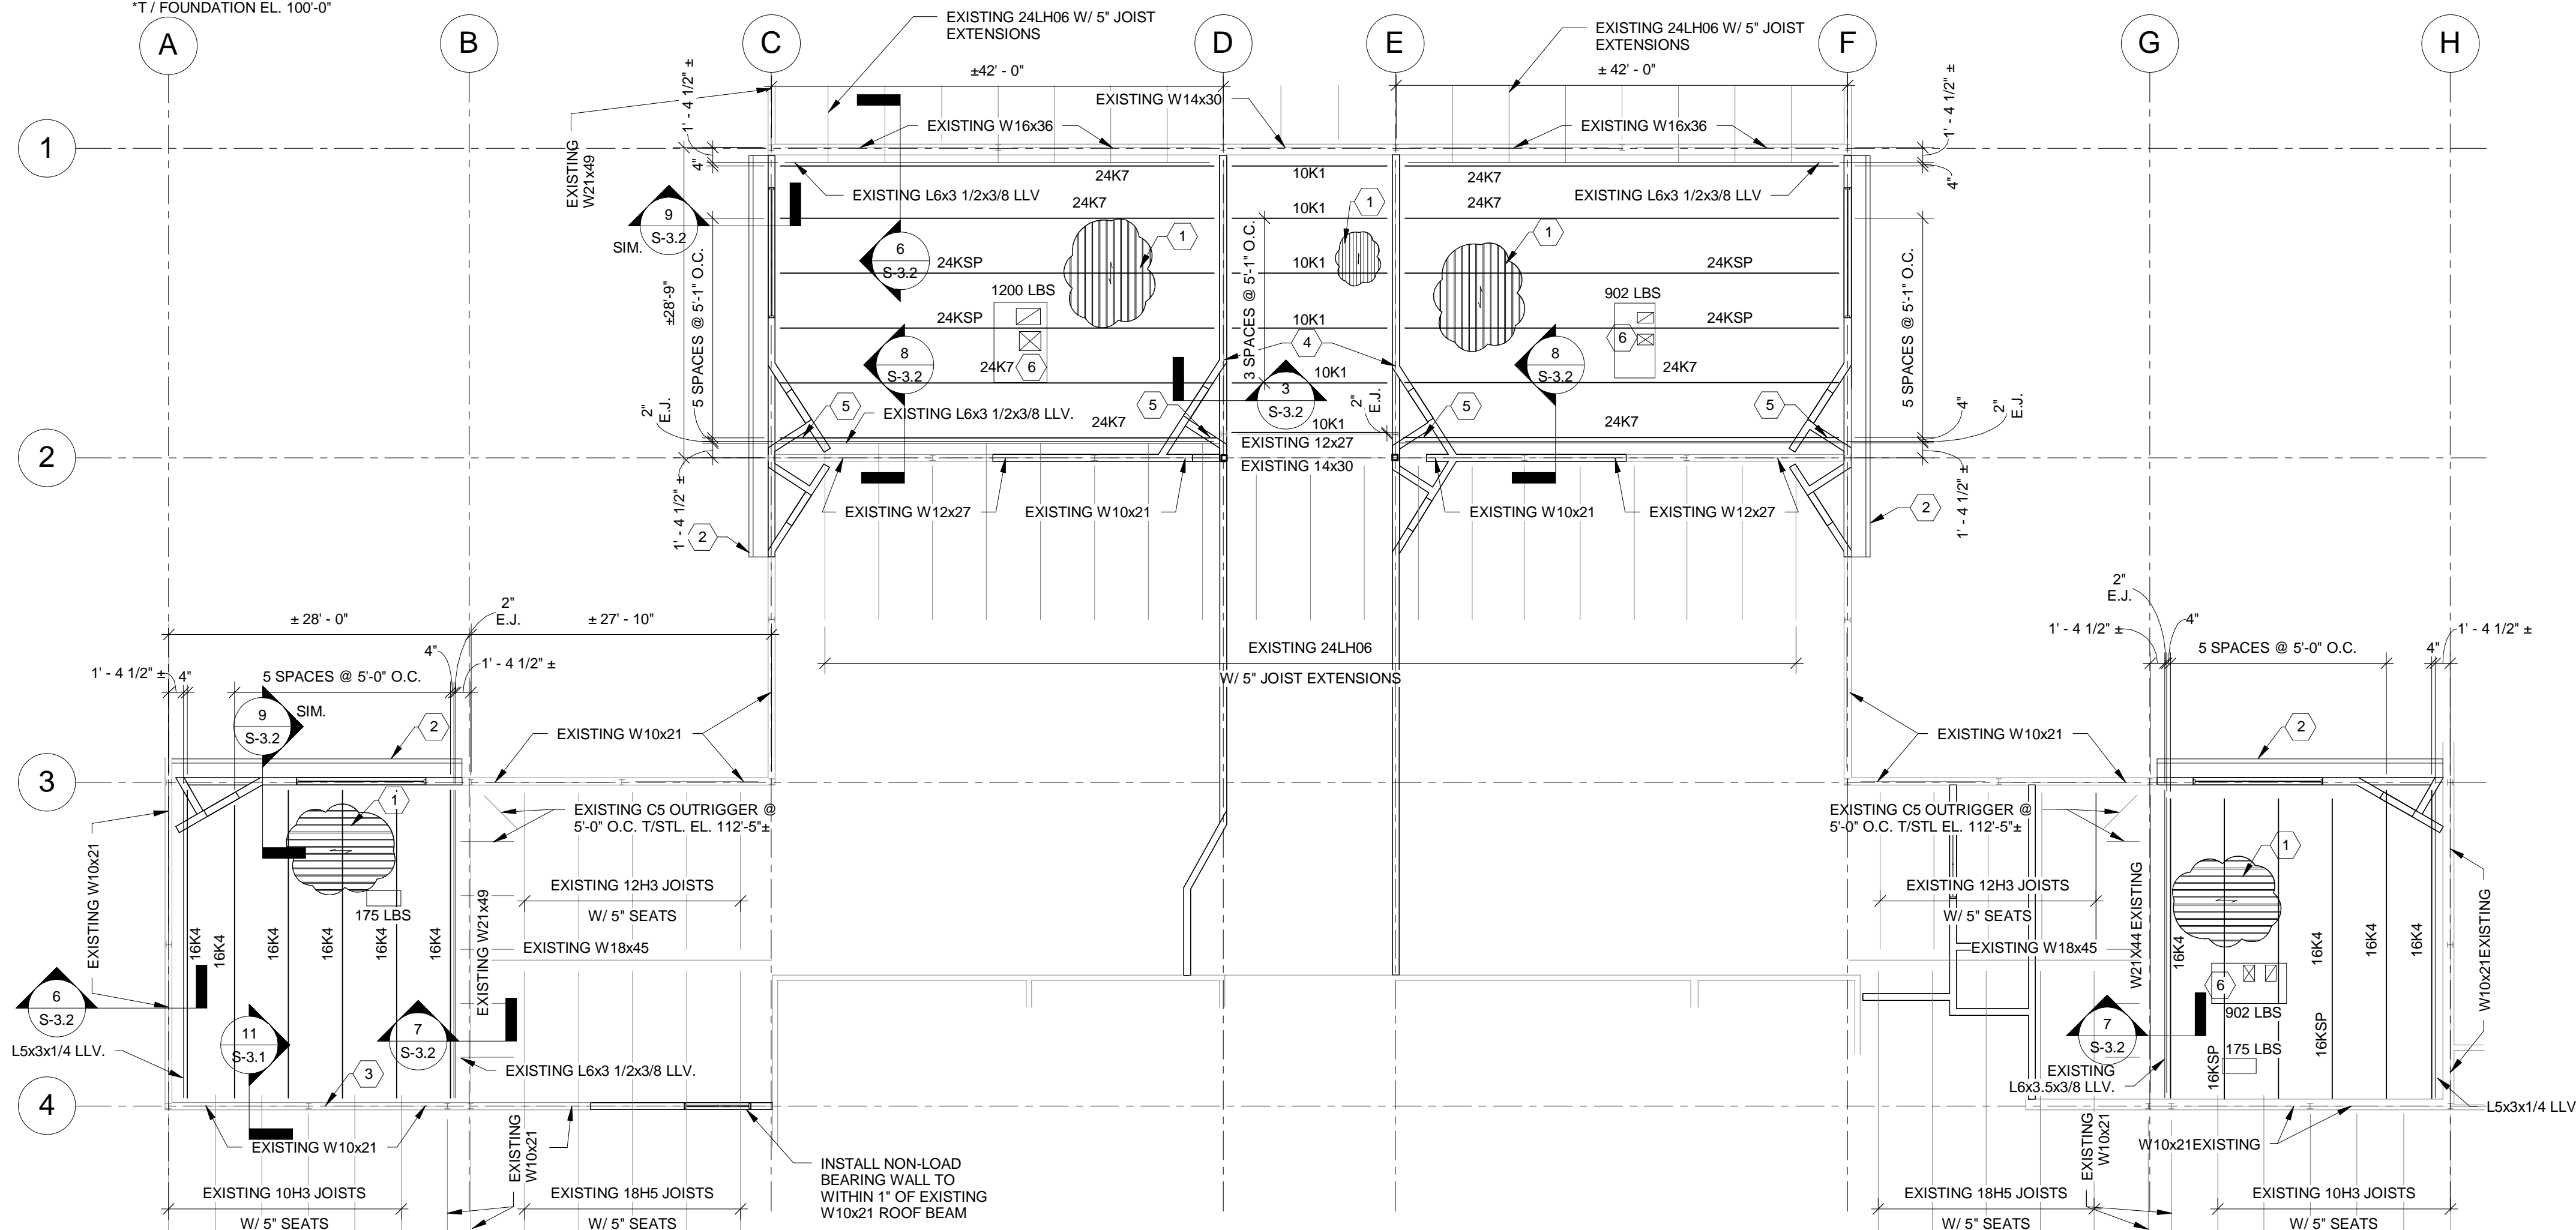


ROOF FRAMING PLAN - ZONE B

### ROOF FRAMING PLAN NOTES

- 1 11/2" 20 GA. G90 GALVANIZED ROOF DECK. VULCRUF TYPE "CVS" OR APPROVED EQUAL W/ LIGHTWEIGHT CONC. TOPPING.
- 2 EXISTING PRECAST CONCRETE PANEL (RELOCATED)
- 3 COVER PLATE EXISTING W10x21 BEAM, SEE DETAIL 11/S-3.1 PRIOR TO ROOF INSTALLATION.
- 4 REMOVE EXISTING ROOF DECK AND W14x30 ROOF BEAMS.
- 5 PROVIDE JOIST EXTENDER AS REQUIRED.
- 6 ROOF TOP EQUIPMENT, 1200 LB MAXIMUM. SEE JOIST LOADING DIAGRAM BELOW FOR REQUIRED LOADS, WHICH ARE PRESENTED IN PRIMARY LOAD CASES AND MUST BE COMBINED USING FBC LOAD COMBINATIONS. WIND LOADS SHOWN ARE IN ASD UNITS.

16/24KSP JOIST LOADING @ EQUIPMENT

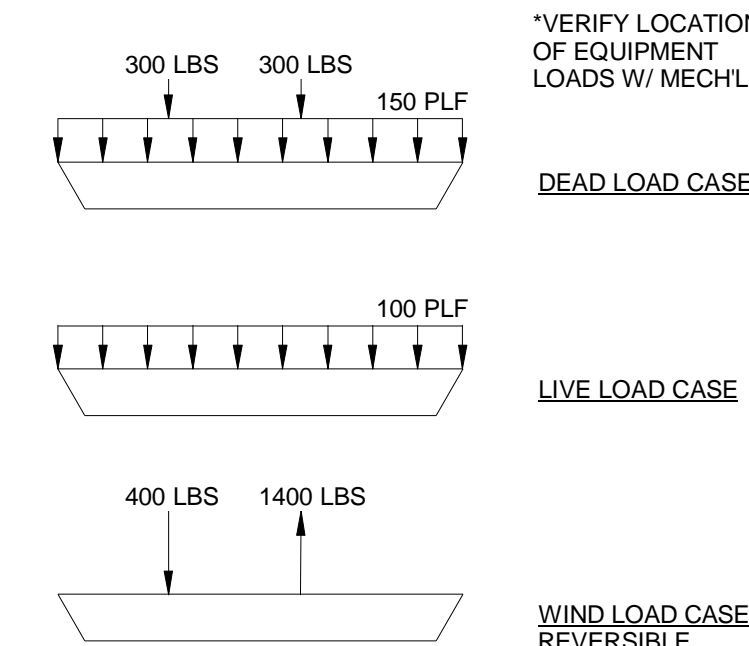

\*VERIFY LOCATION  
OF EQUIPMENT  
LOADS W/ MECH'L


DEAD LOAD CASE

LIVE LOAD CASE


WIND LOAD CASE  
REVERSIBLE

Sea




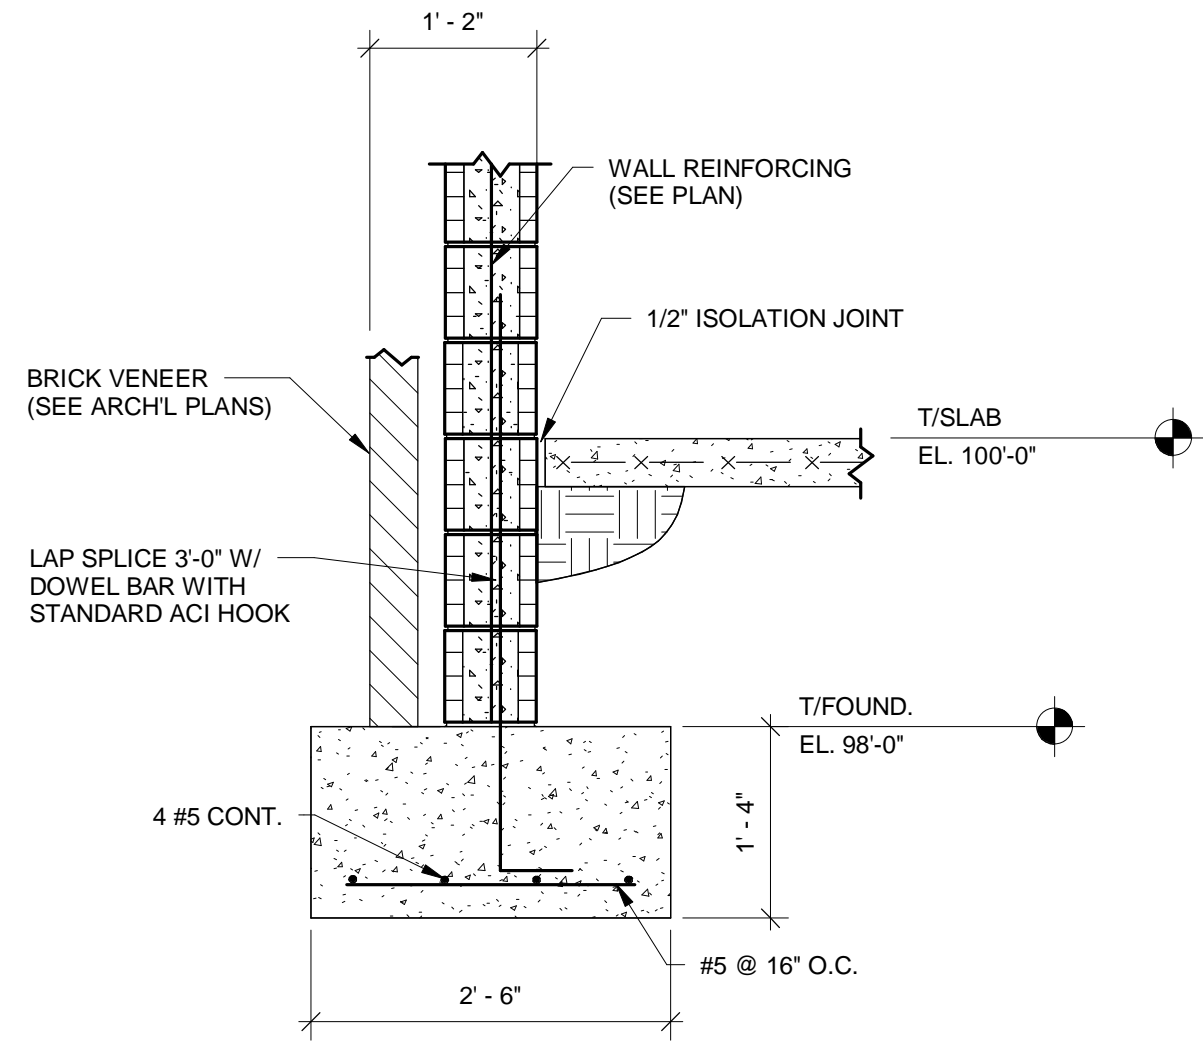


1 WF2.5 FOUNDATION AND WALL SECTION  
3/4" = 1'-0"

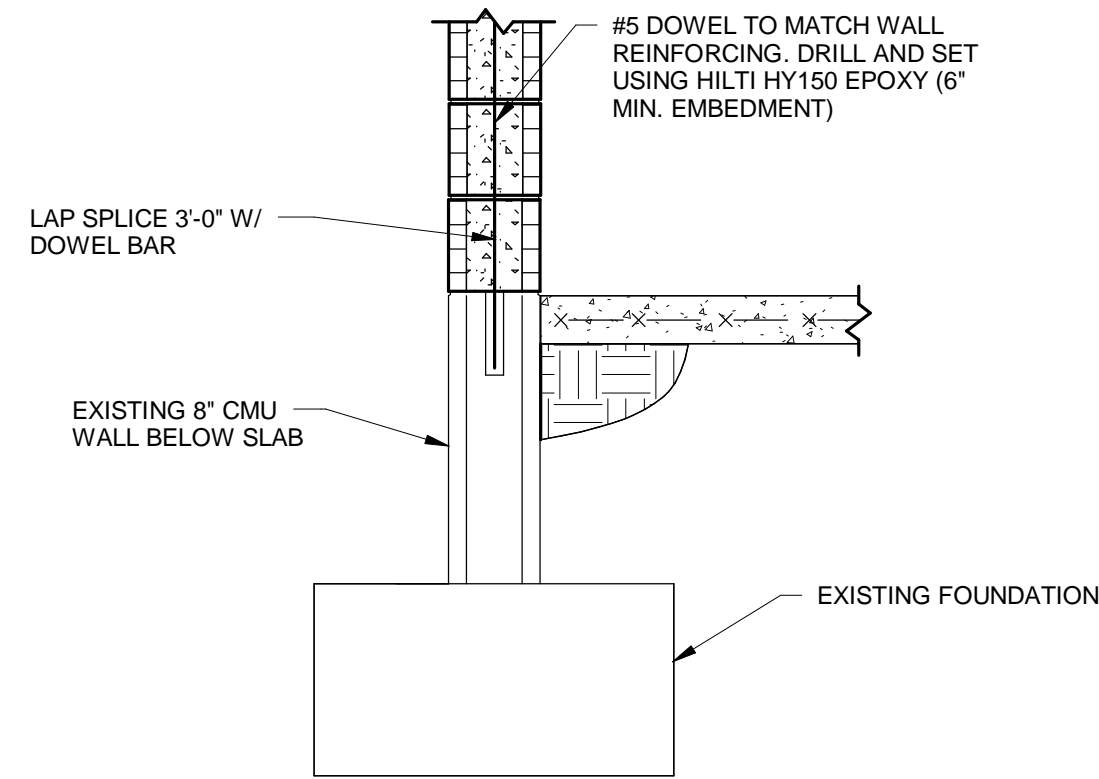


2 WALL ON EXISTING FOUNDATION  
3/4" = 1'-0"

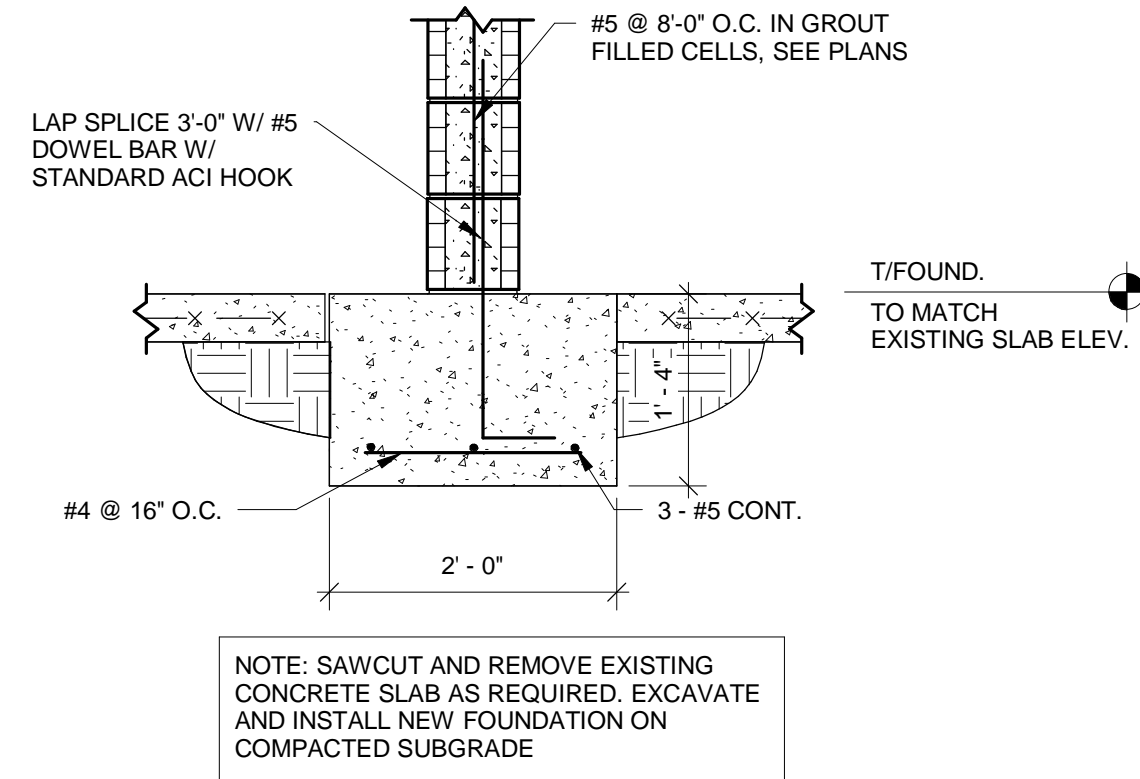


3 WF2.0\* TYPICAL FOUNDATION  
3/4" = 1'-0"

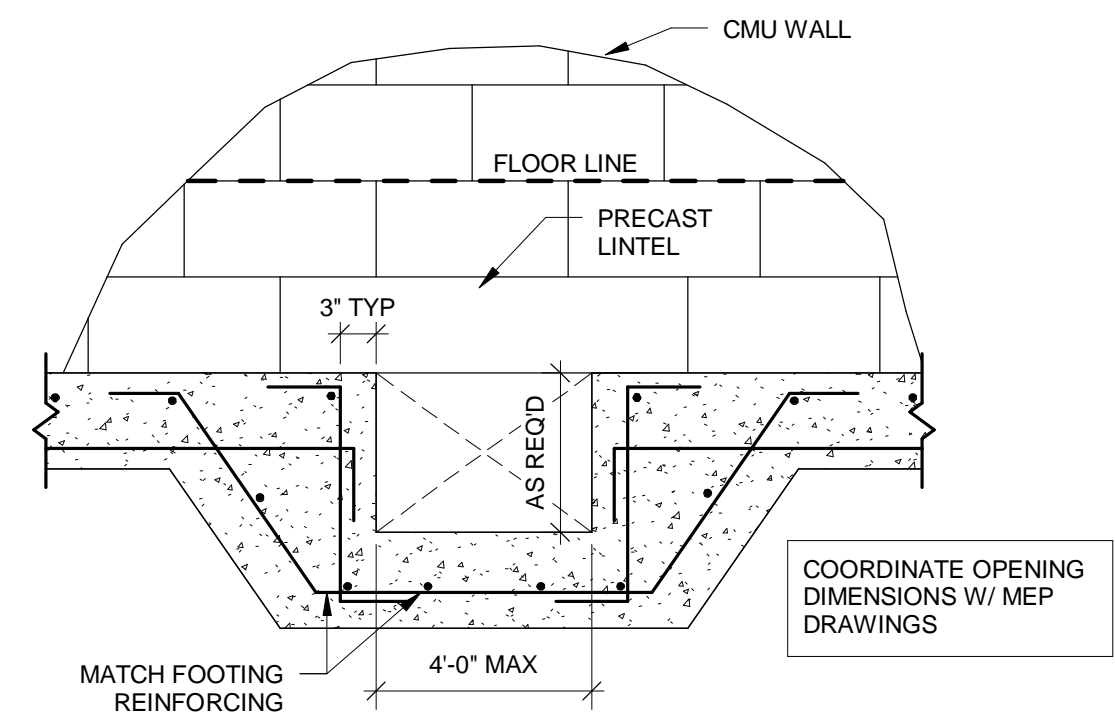


4 TYPICAL STEP FOOTING FOR UTILITIES  
3/4" = 1'-0"

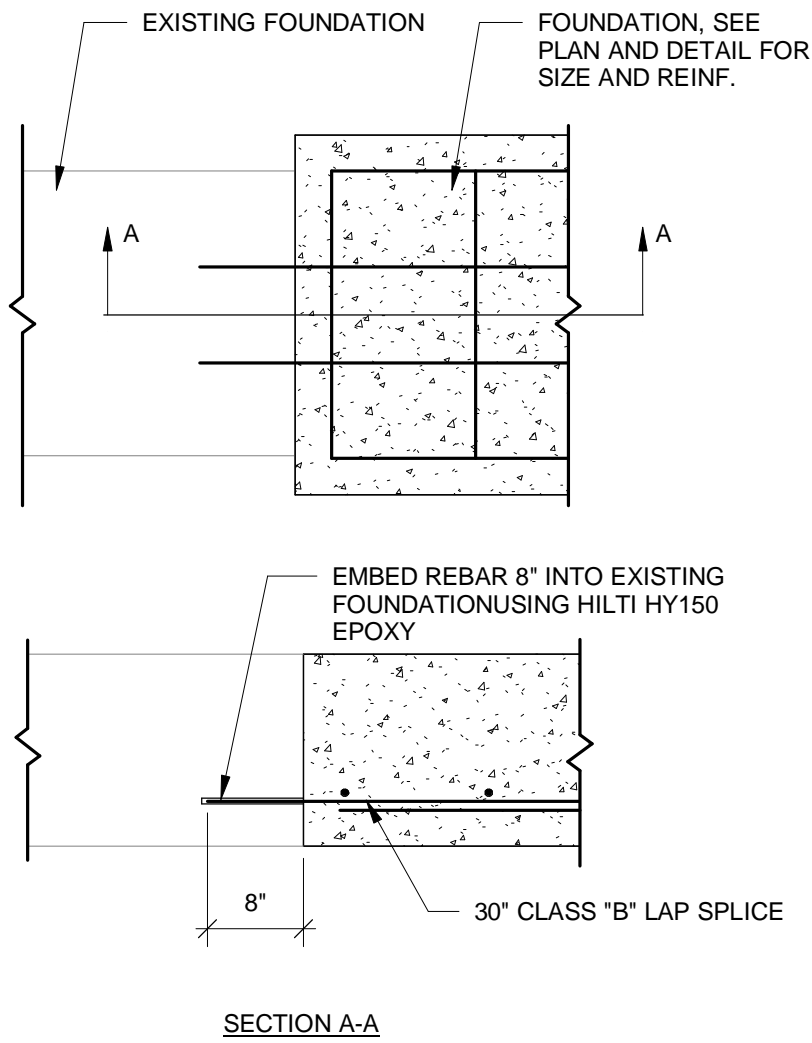


5 NEW TO EXISTING FOUNDATION  
3/4" = 1'-0"

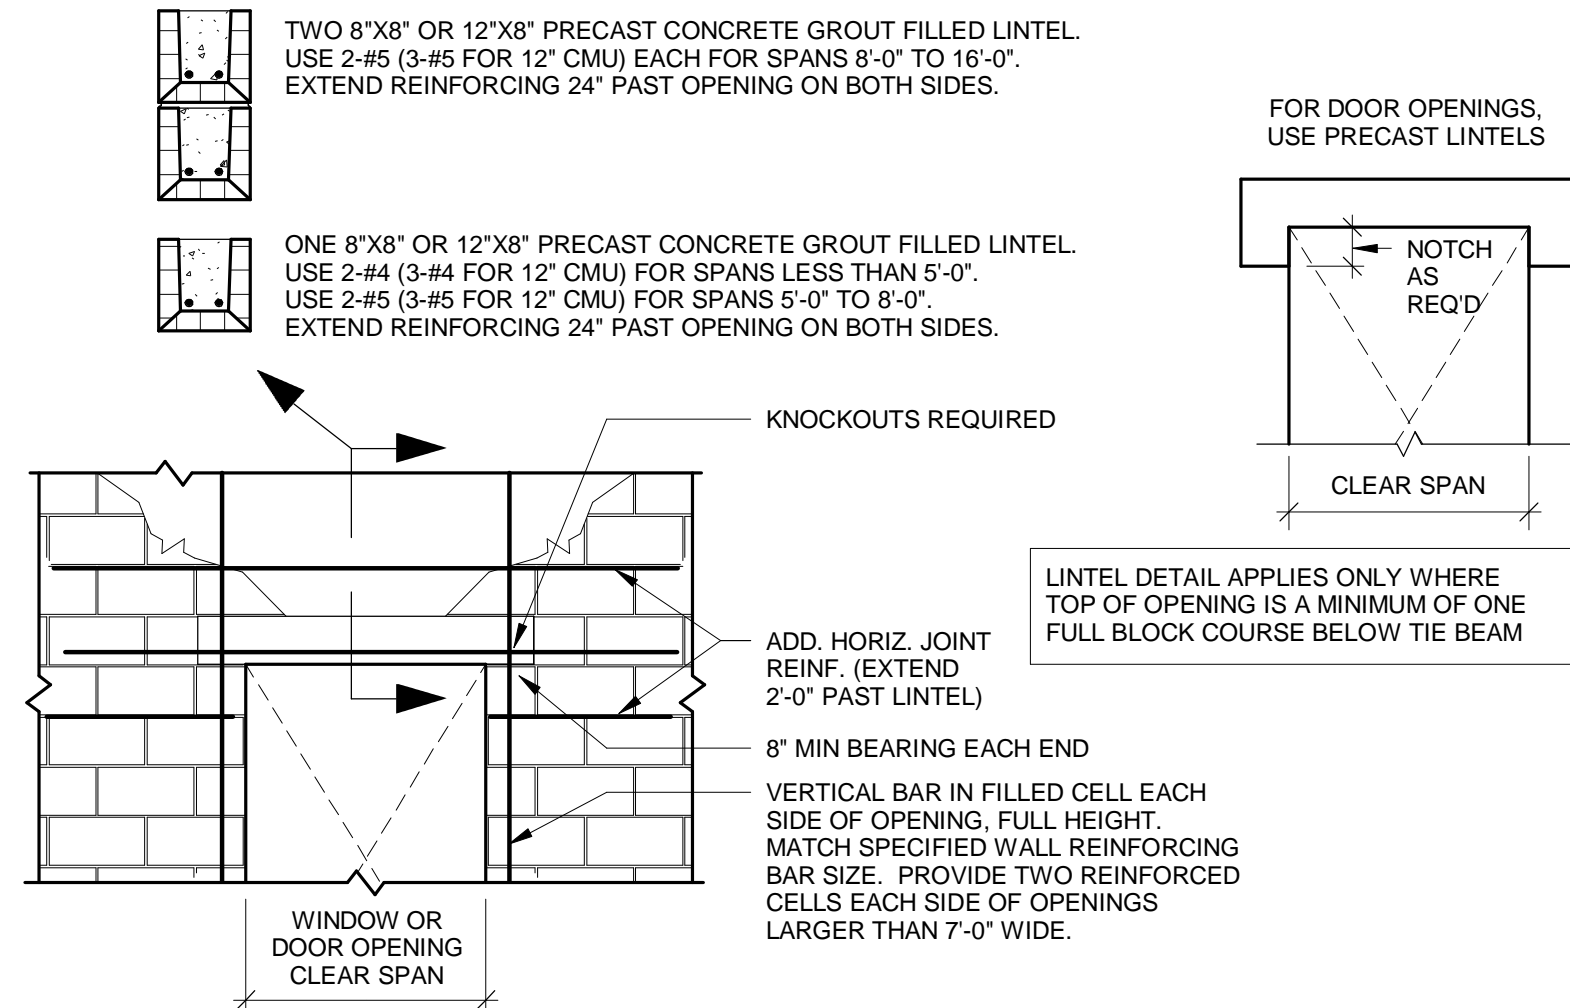


6 TYPICAL MASONRY WALL OPENING LINTEL DETAIL  
3/4" = 1'-0"

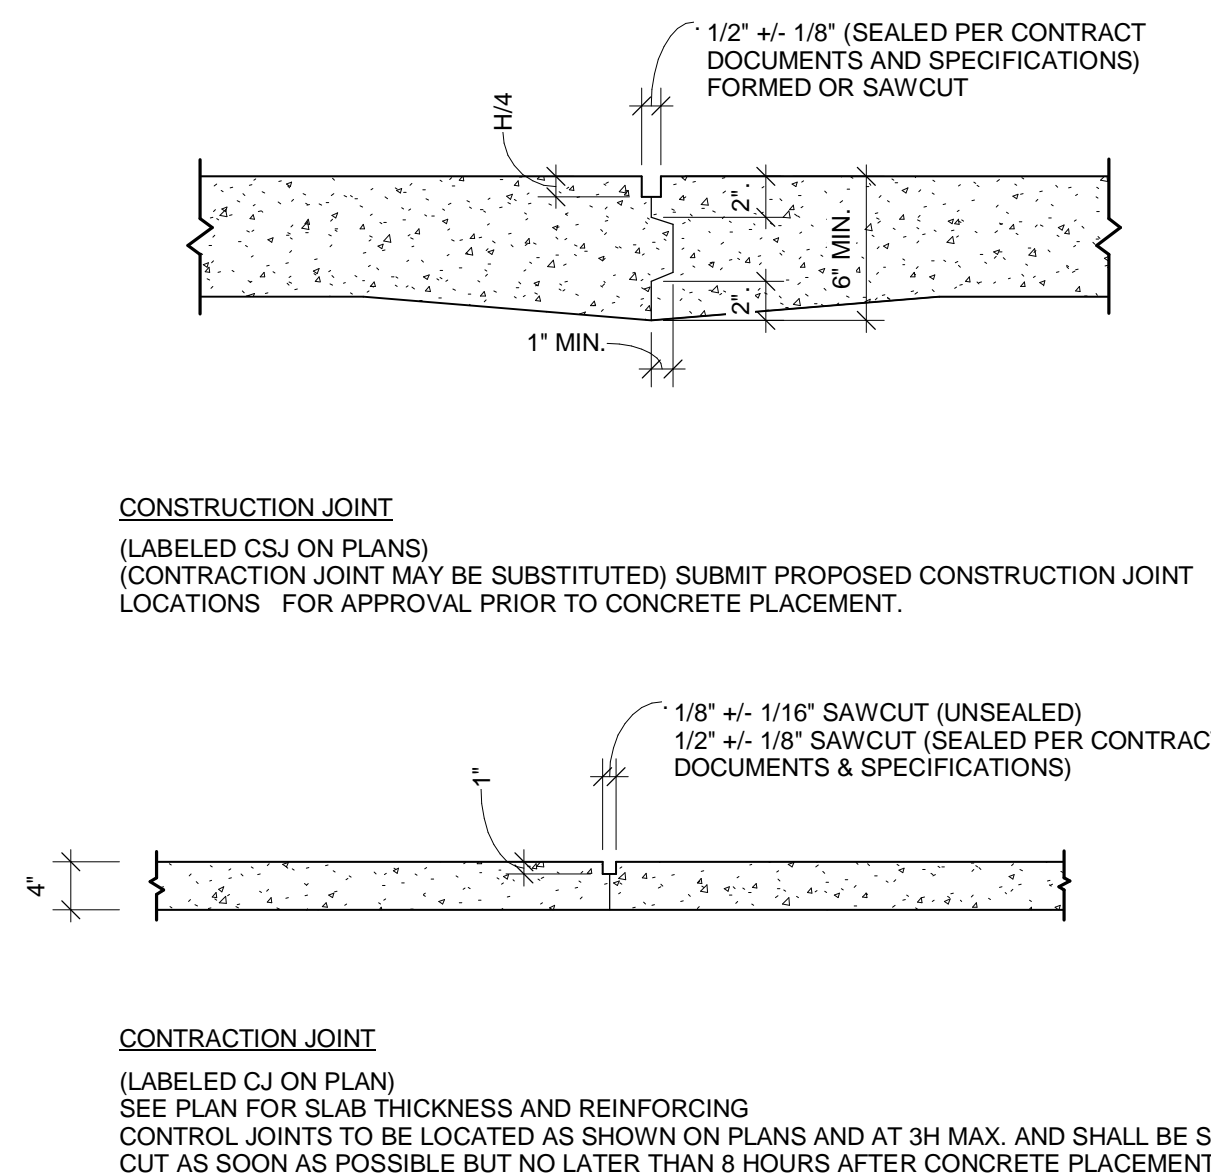


7 TYPICAL SLAB ON GRADE CONTROL JOINTS  
3/4" = 1'-0"

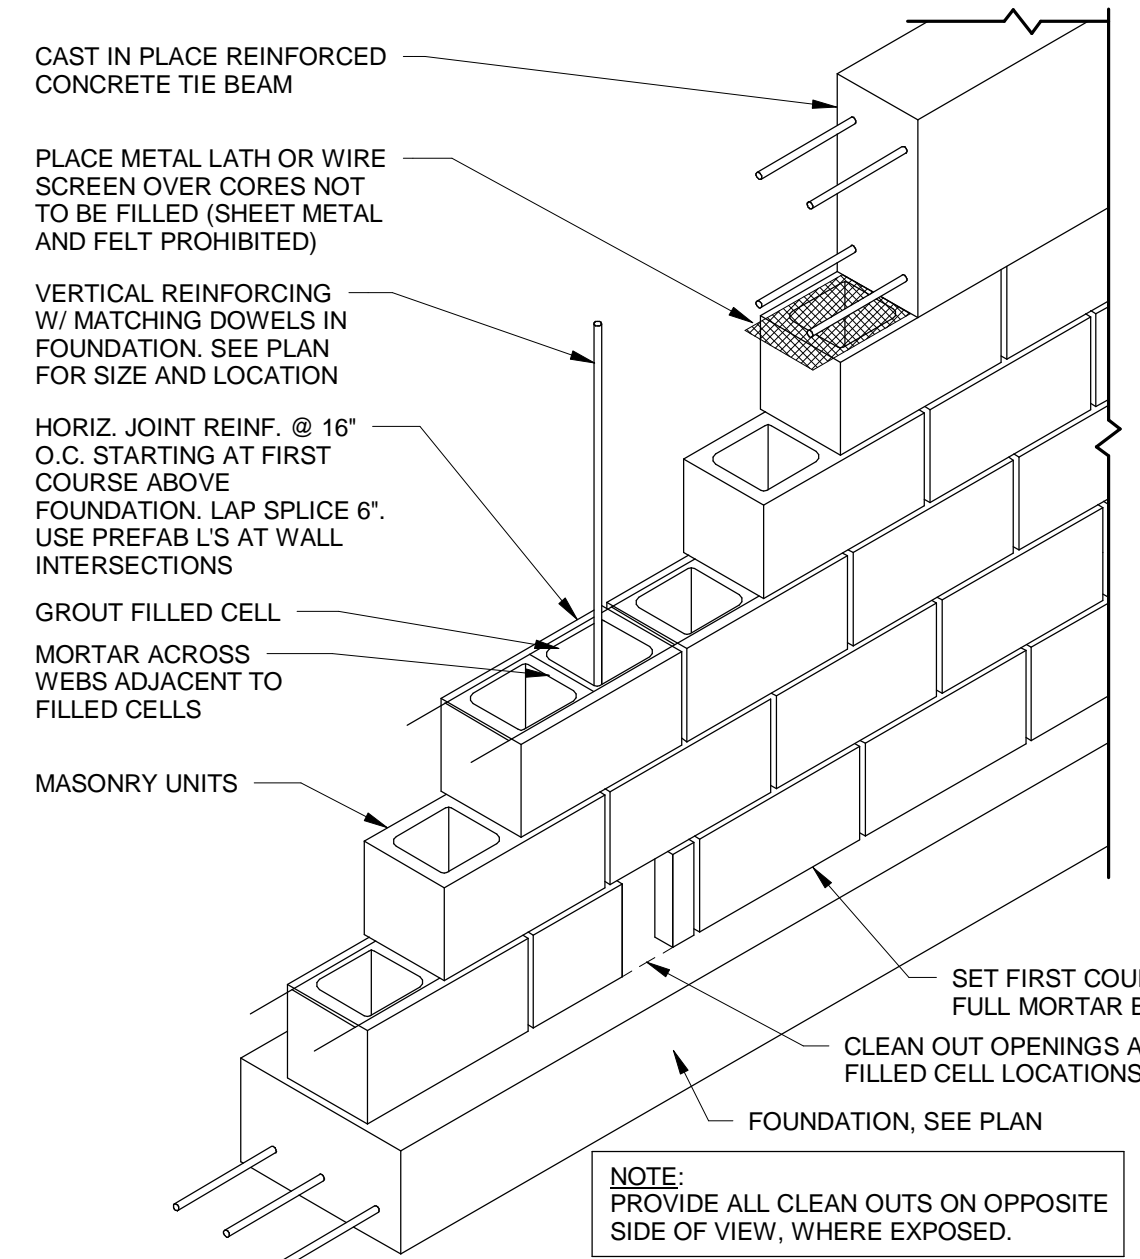


8 TYPICAL MASONRY WALL CONSTRUCTION  
3/4" = 1'-0"

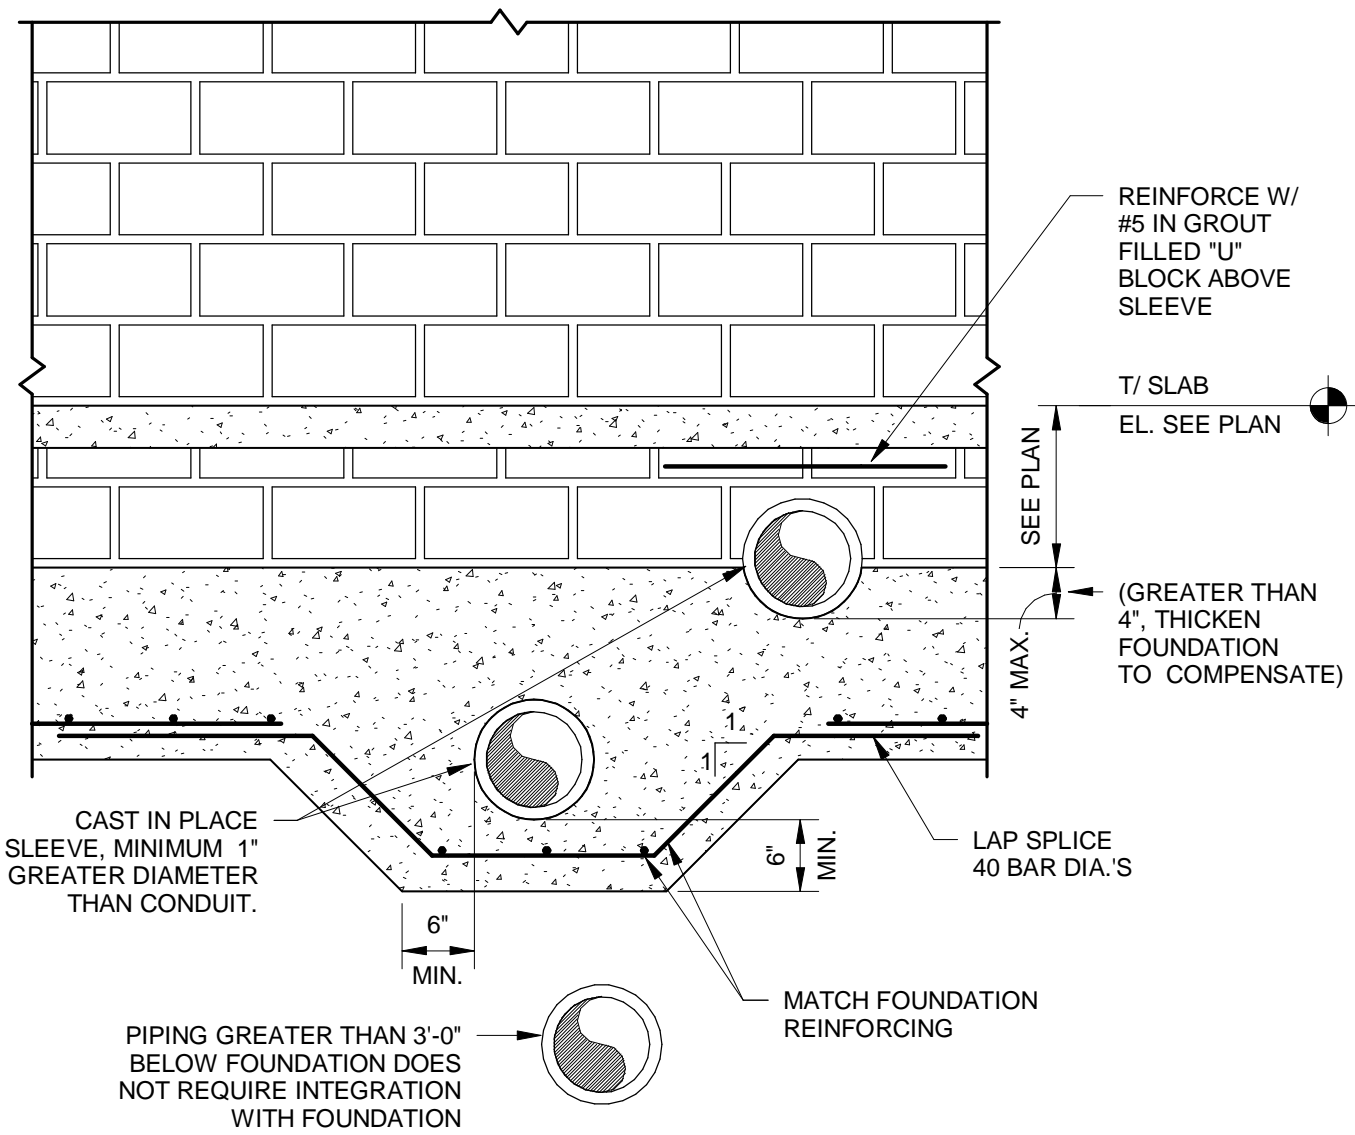


9 TYPICAL FOUNDATION CONDUIT SLEEVE  
3/4" = 1'-0"

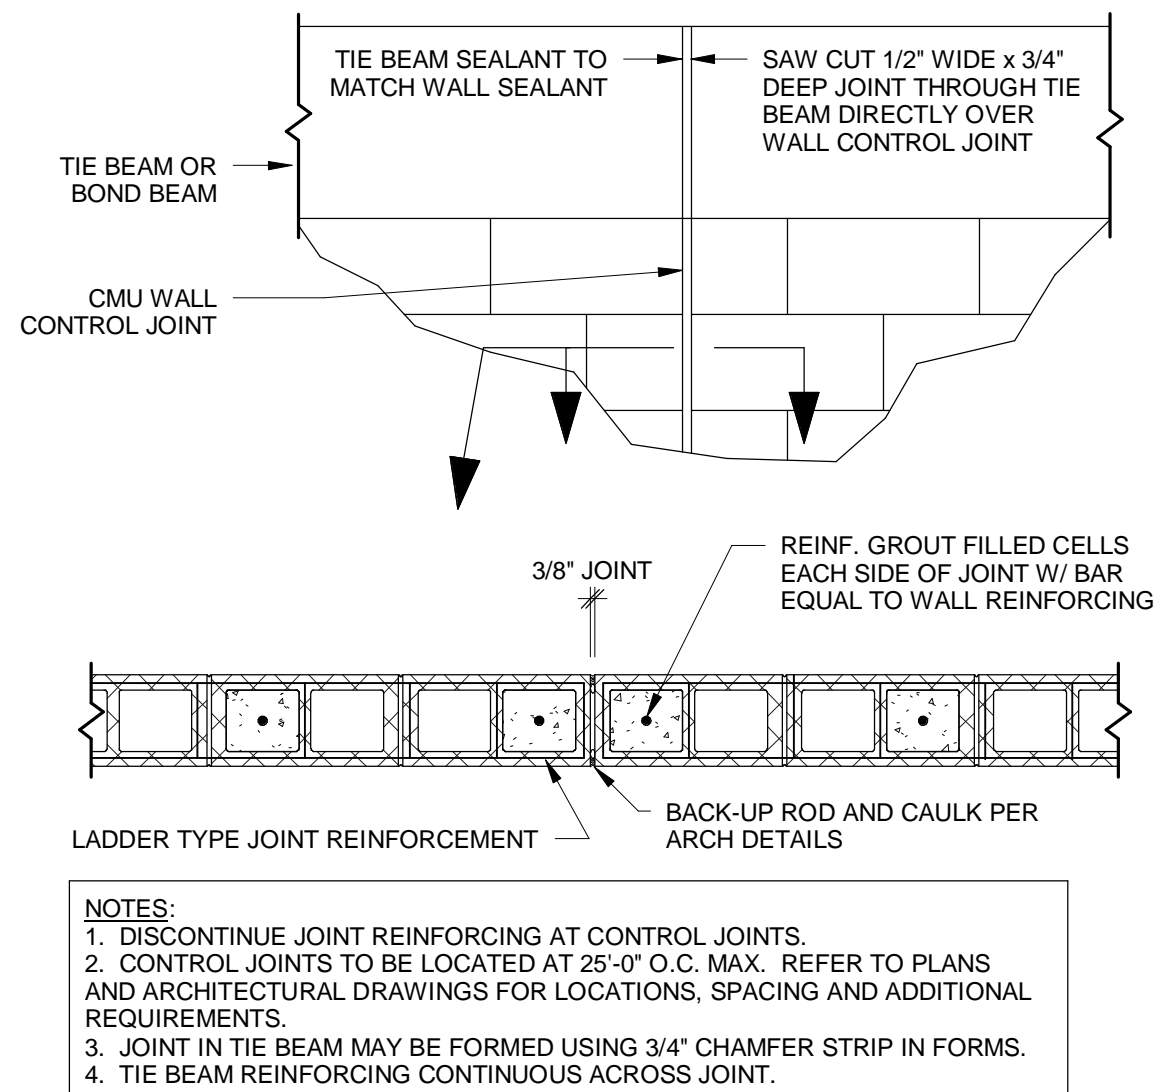


10 TYPICAL MASONRY CONTROL JOINT  
3/4" = 1'-0"

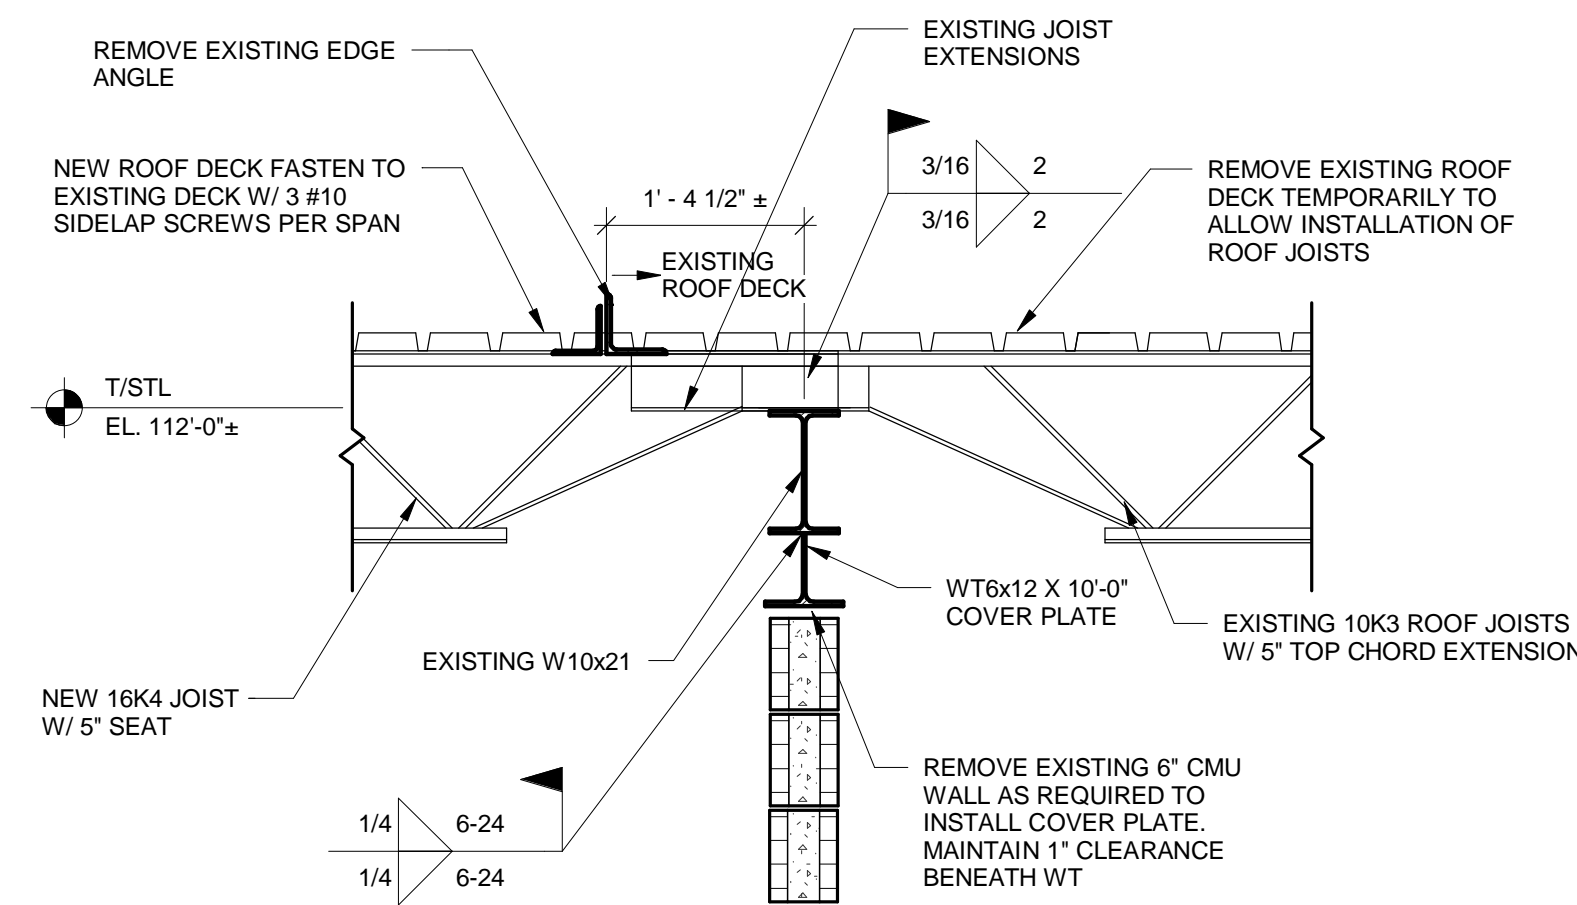


11 "K" JOIST BEARING OVER EXISTING STEEL BEAM  
3/4" = 1'-0"

REVISIONS AND UPDATES		
02/14/14	CONSTRUCTION DOCUMENTS FOR BID/PERMIT	
<div>SUNWANNEE COUNTY SCHOOL BOARD SUNWANNEE PRIMARY SCHOOL ADDITIONS AND REMODELING 1625 WALKER AVE., SW LIVE OAK, FLORIDA</div>		
SECTIONS AND DETAILS		
drawn SES	checked GCK	approved GCK
<div> AA-C001560</div>		<div>job no. 2012.51 S-3.1</div>
ARCHITECTS RZK, INC. 600 FLORIDA AVENUE SUITE 202 COCOA, FLORIDA 32922 TELEPHONE (321) 631-8039		




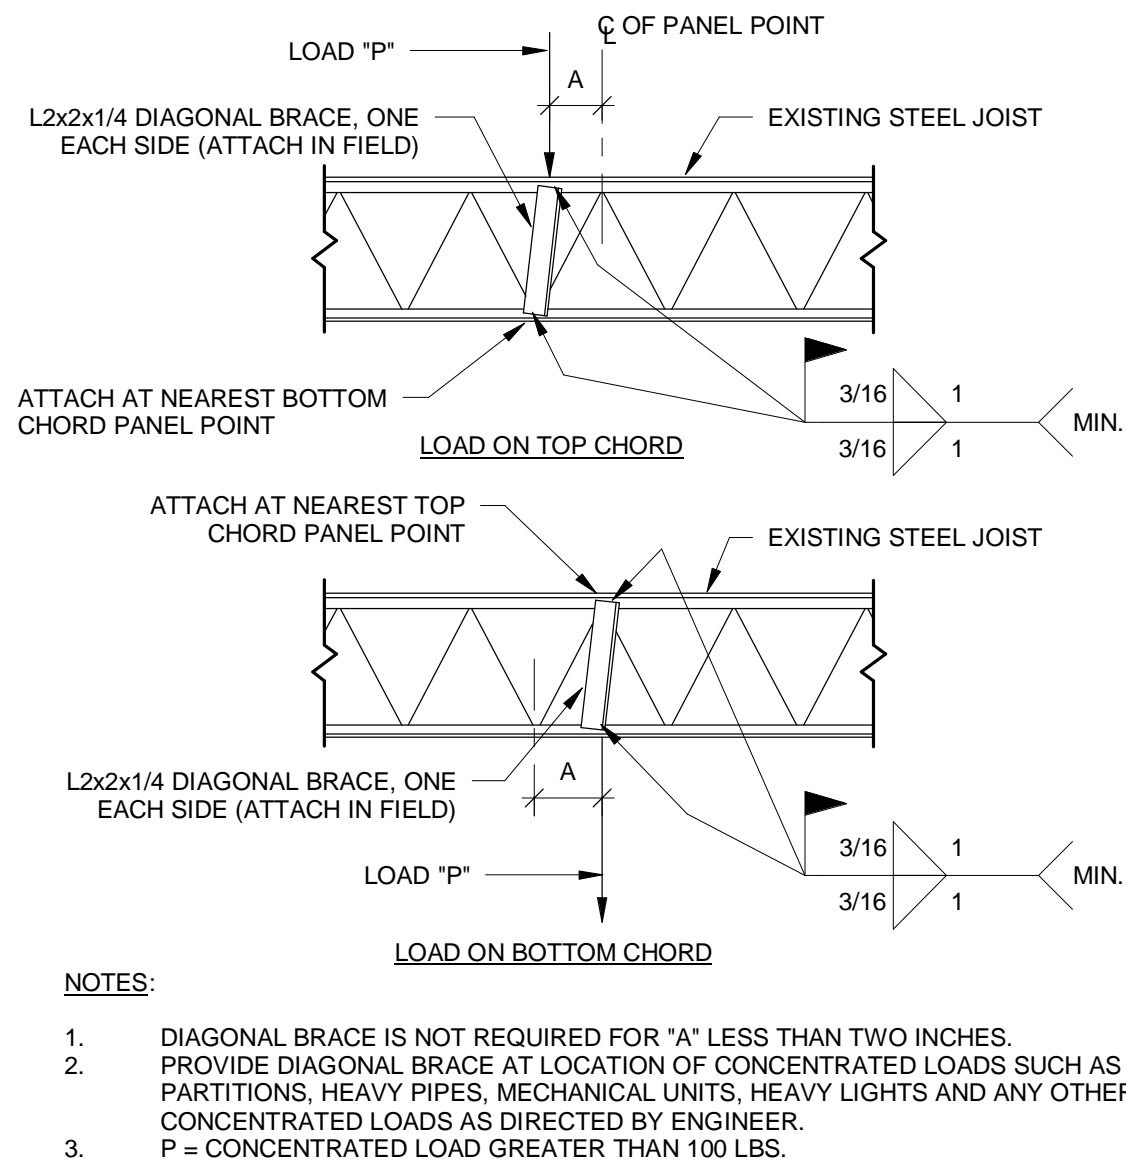


1 TYPICAL JOIST REINFORCING  
3/4" = 1'-0"

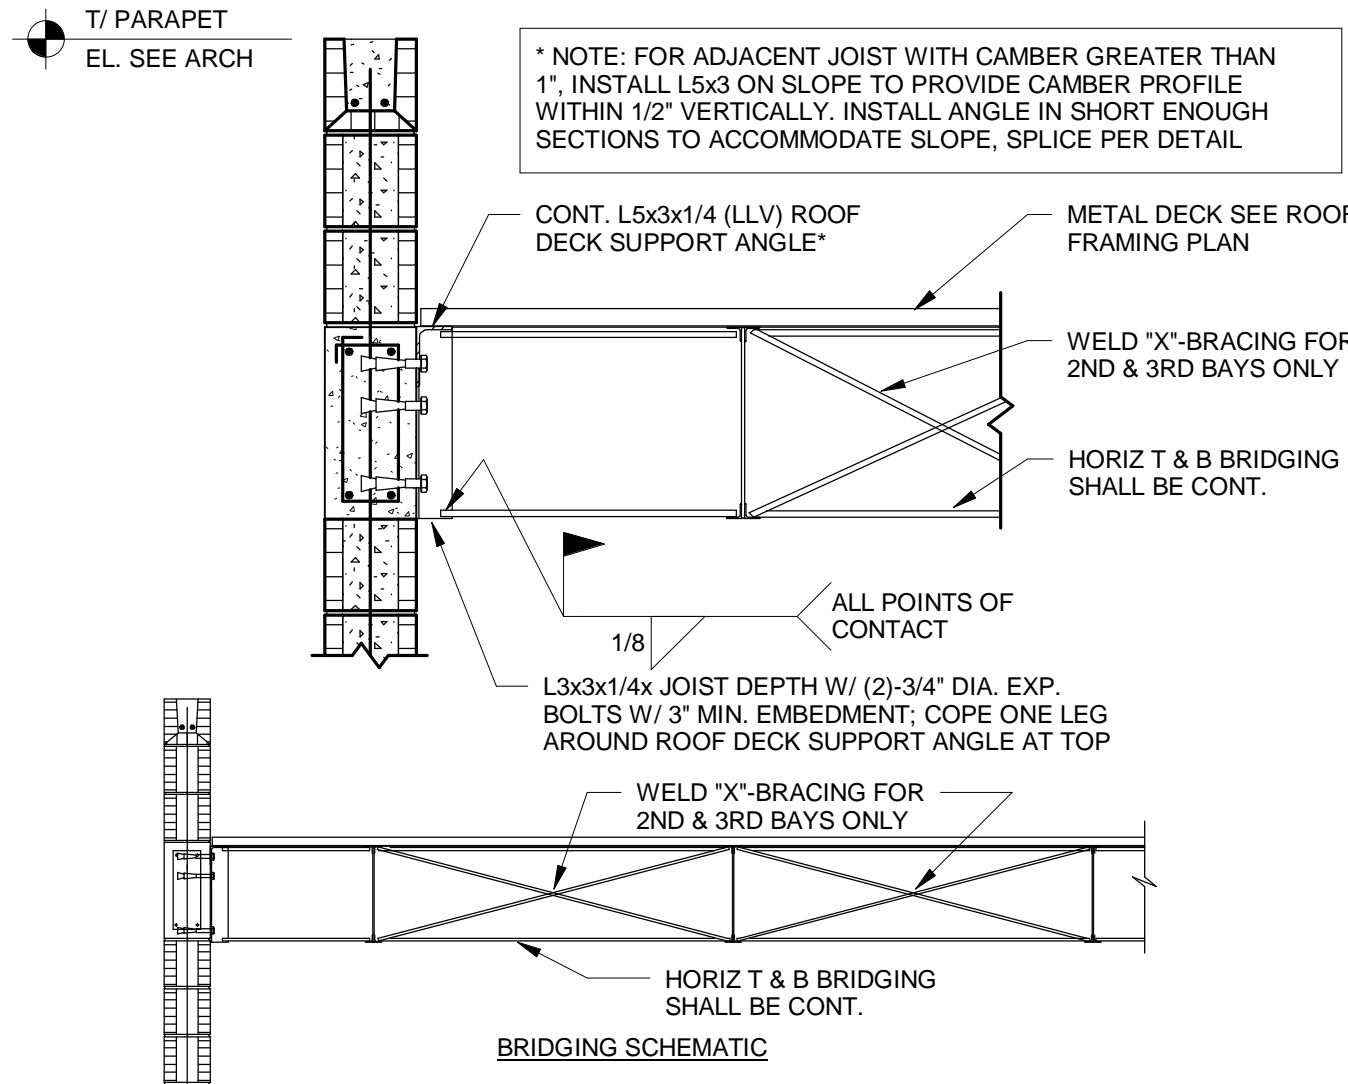


2 TYPICAL BRIDGING DETAIL AT MASONRY  
3/4" = 1'-0"

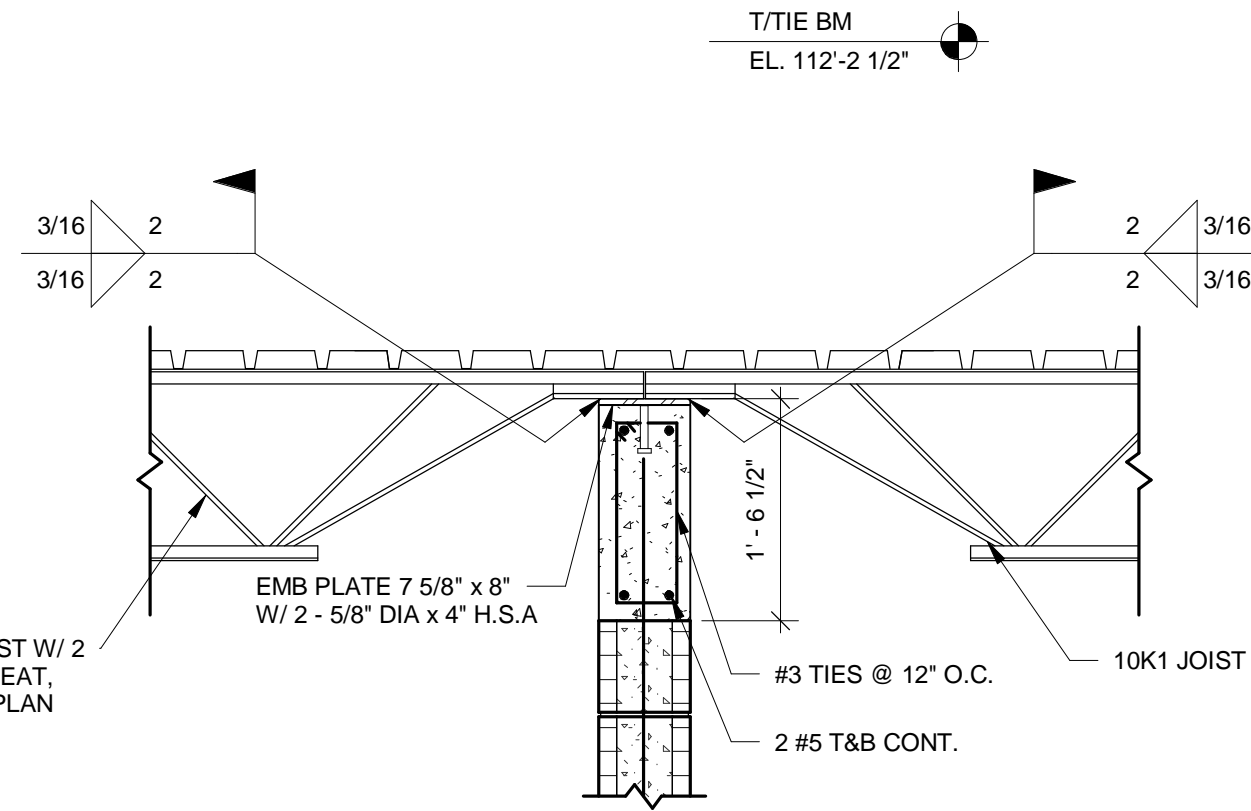


3 JOIST W/ CMU SUPPORT  
3/4" = 1'-0"

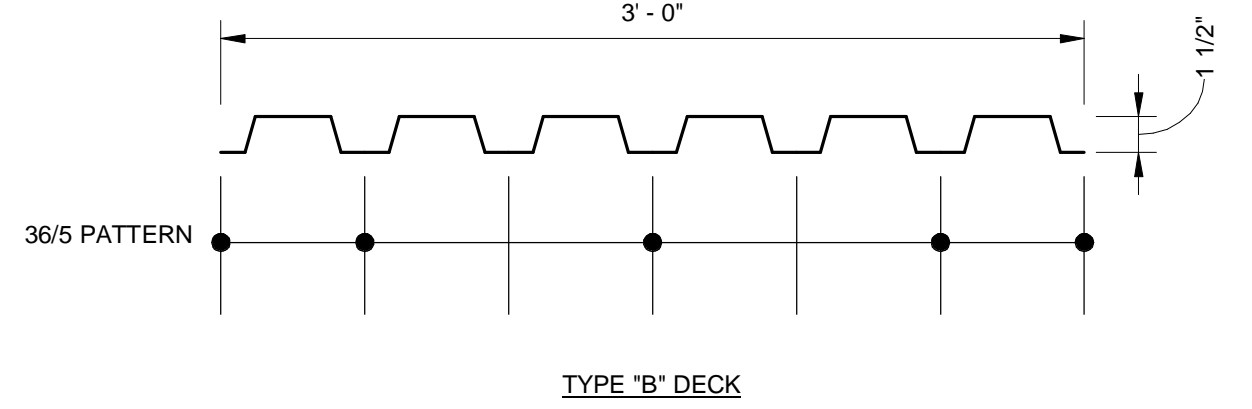


4 ROOF DECK FASTENING PATTERN  
1 1/2" = 1'-0"

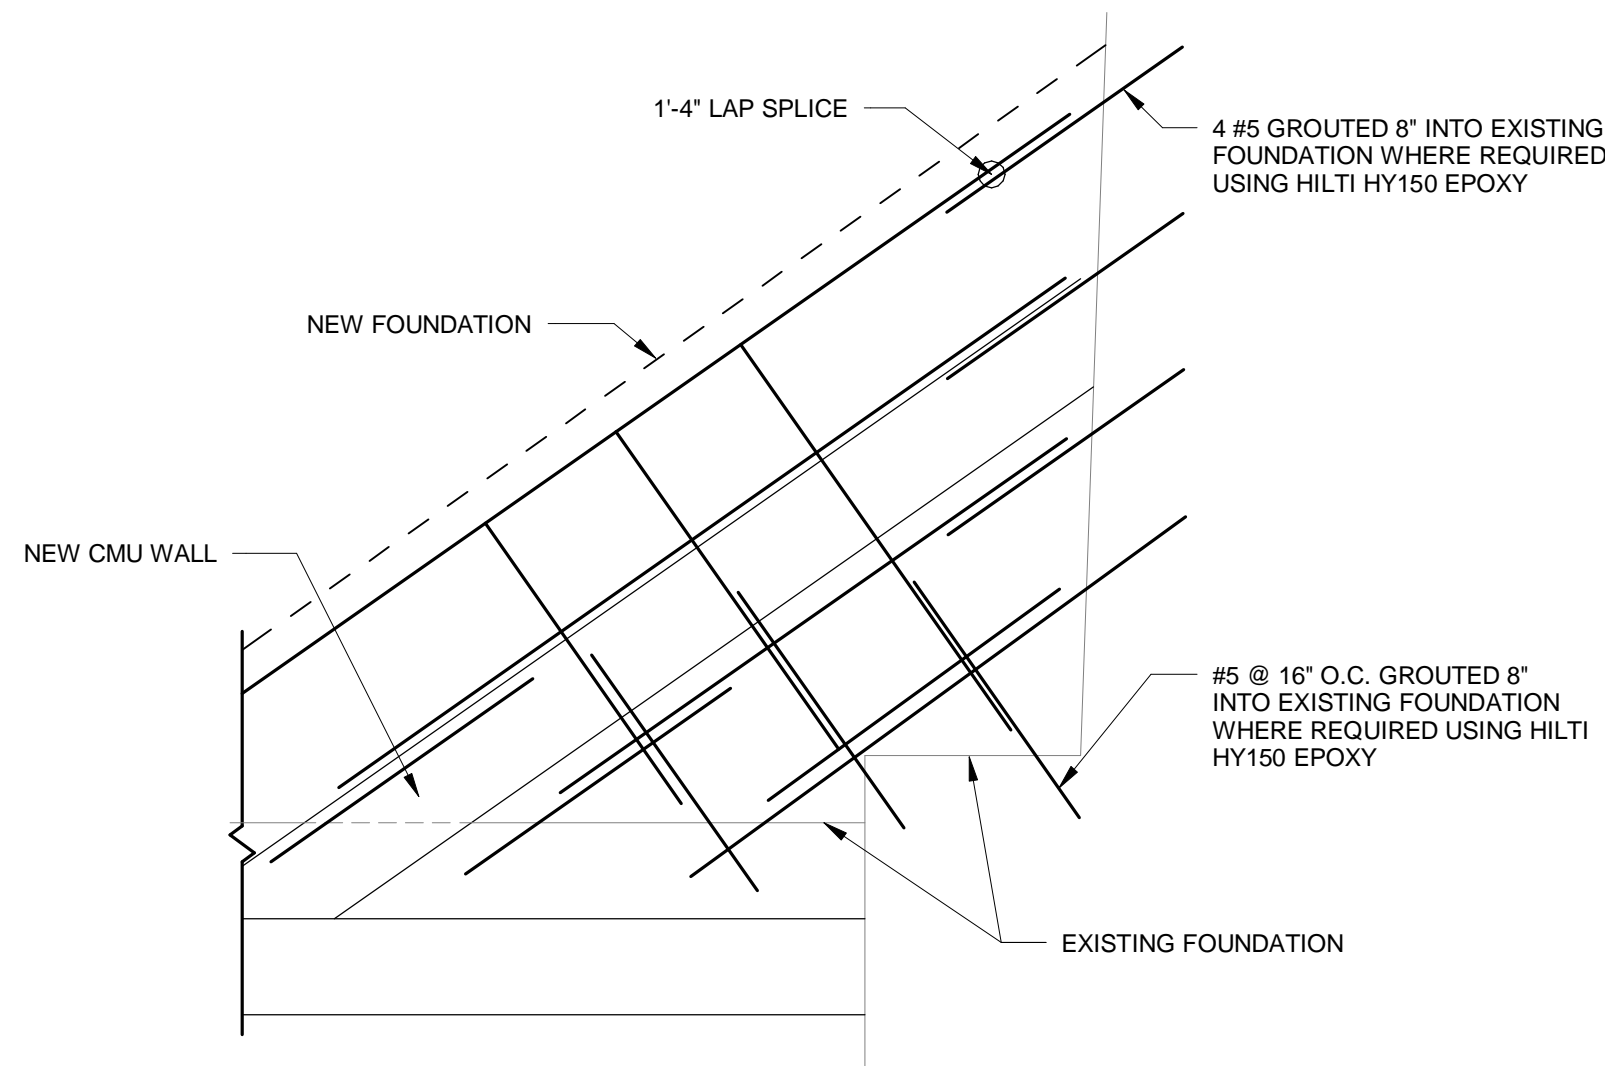


5 EXISTING FOUNDATION EXTENSION  
3/4" = 1'-0"

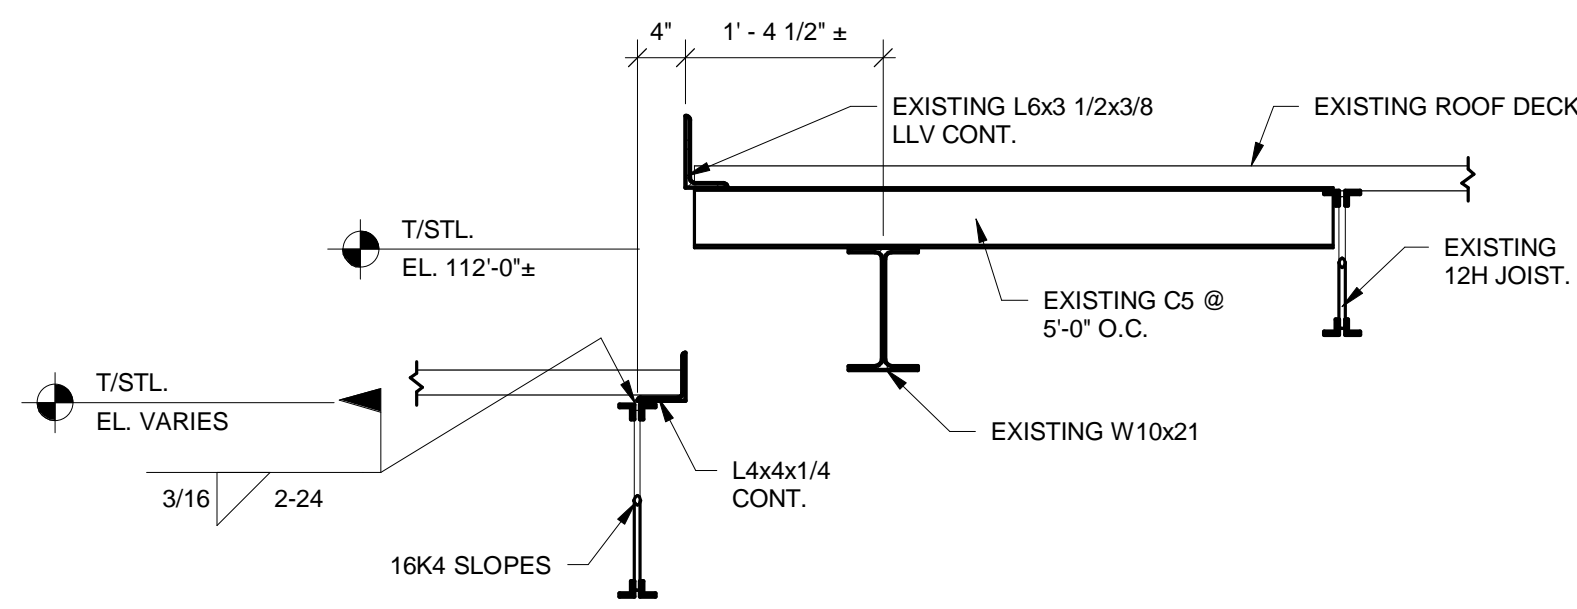


6 ROOF SECTION  
3/4" = 1'-0"

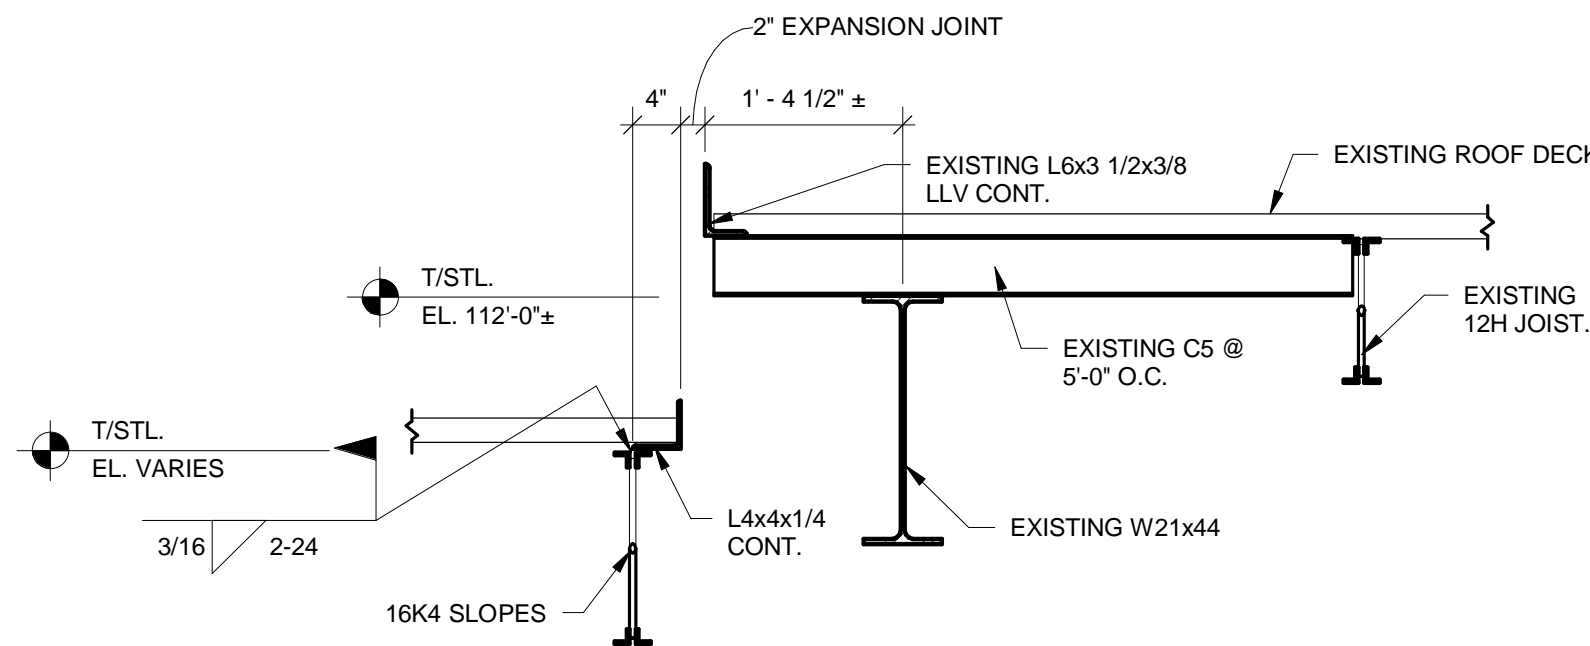


7 ROOF SECTION AT EXPANSION JOINT  
3/4" = 1'-0"

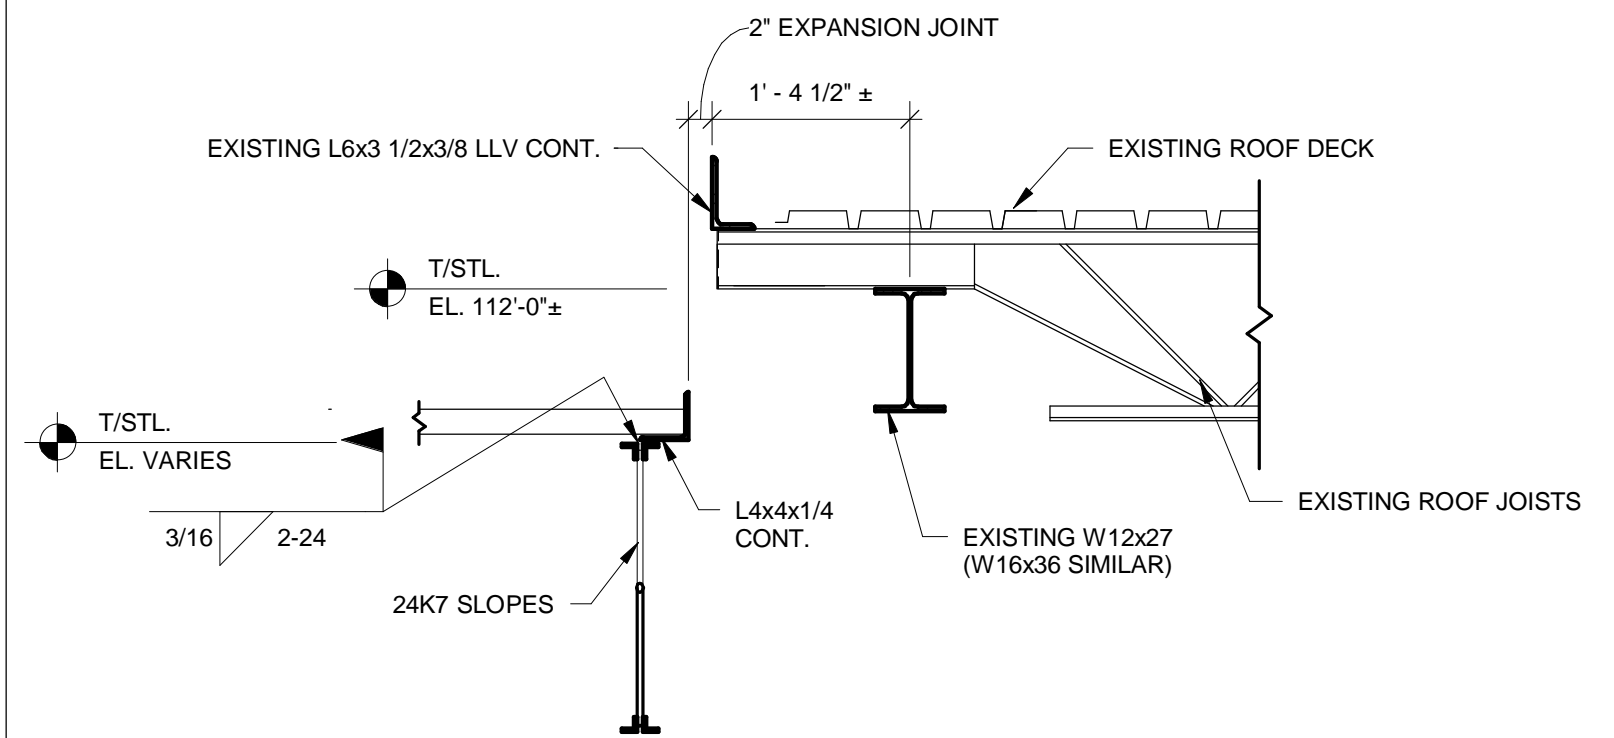

8 ROOF SECTION AT EXPANSION JOINT W/ FRAMING DIRECTION CHANGE  
3/4" = 1'-0"

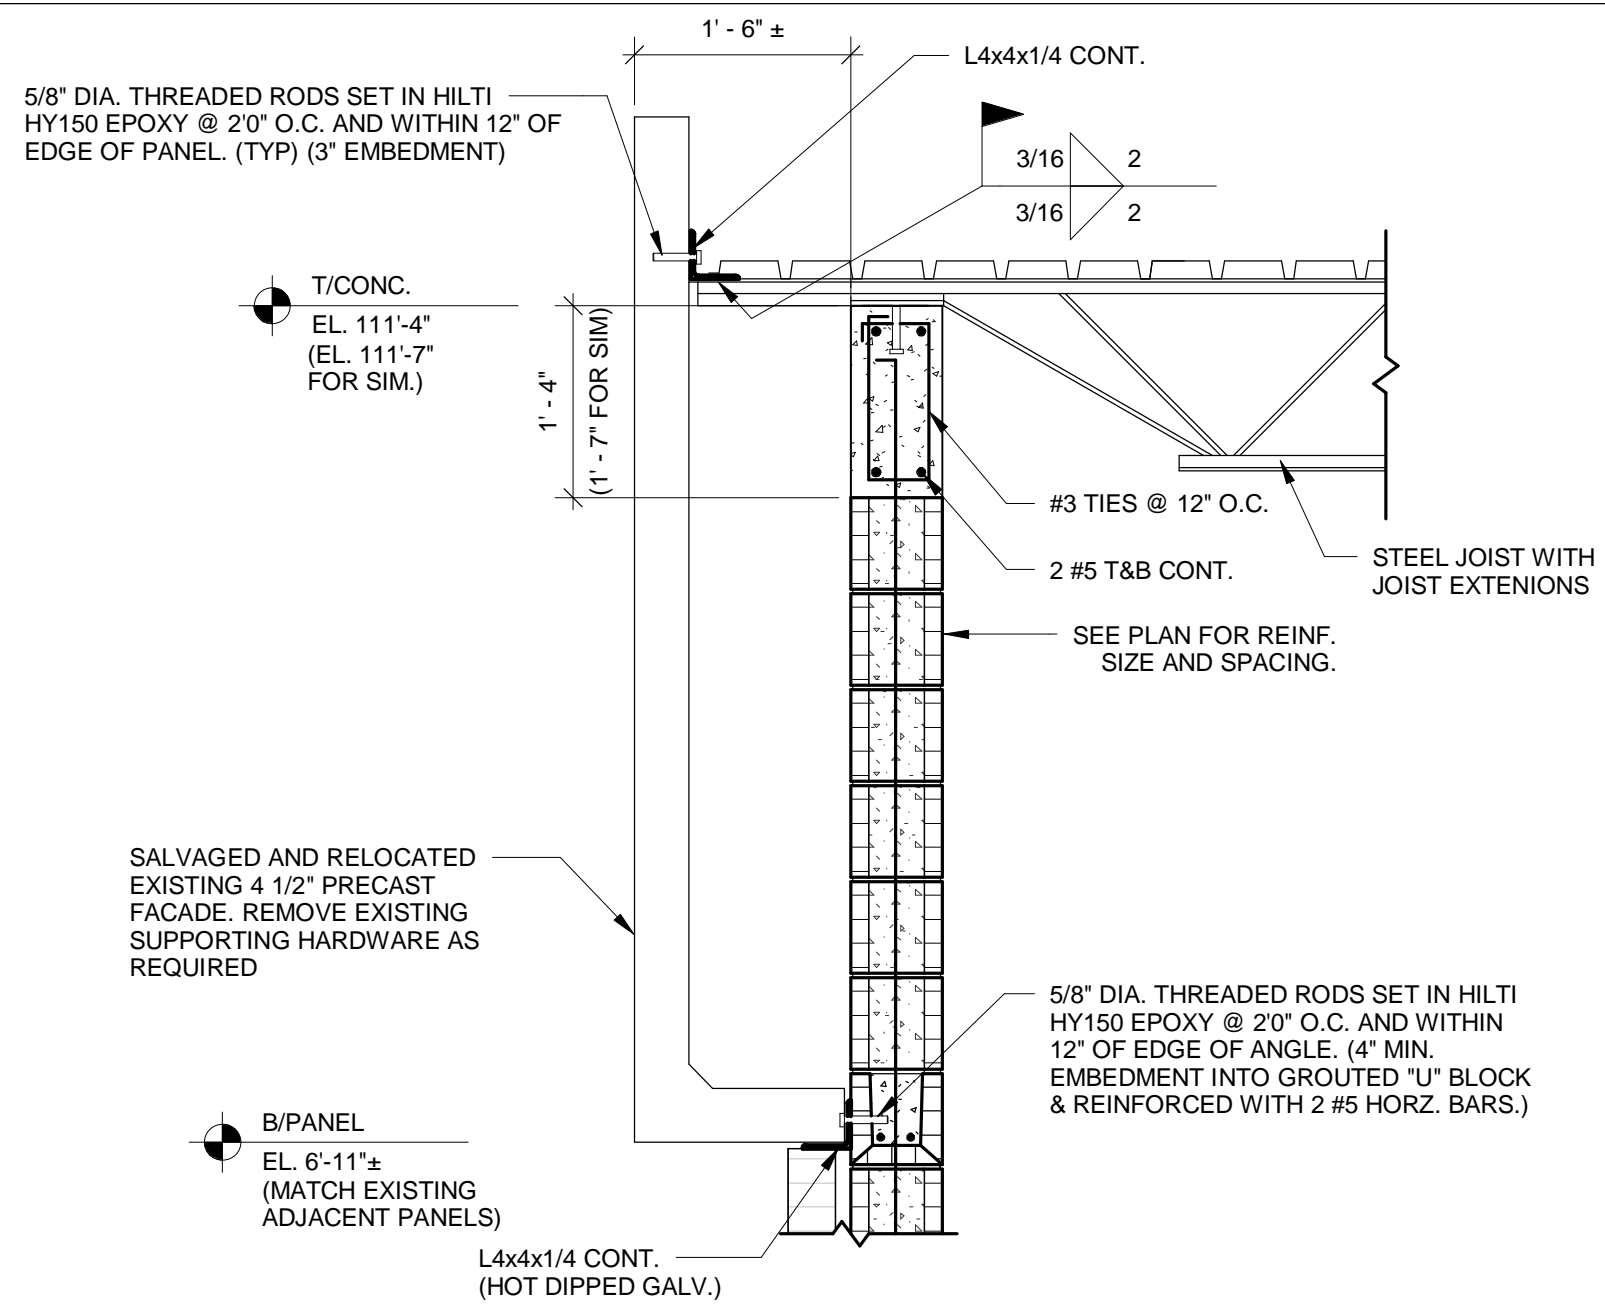

9 TYPICAL WALL SECTION WITH PRECAST FASCIA  
3/4" = 1'-0"

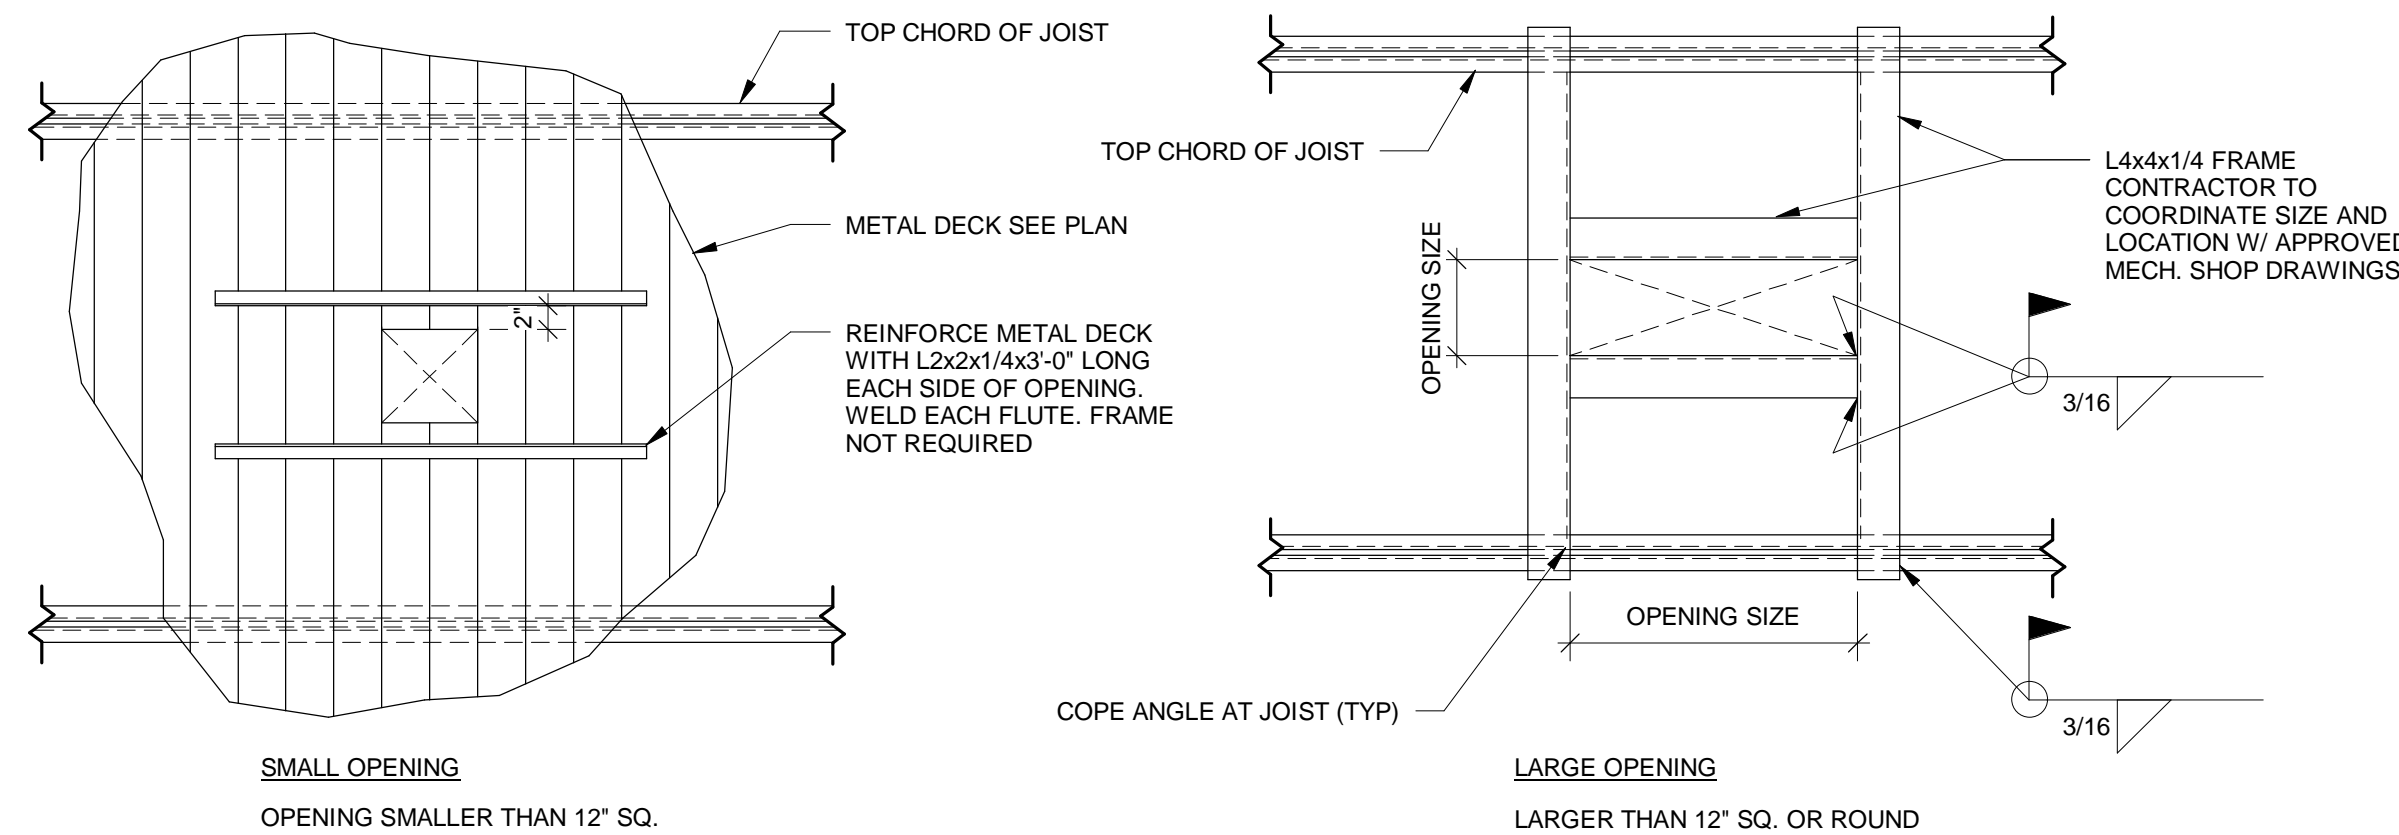

10 TYPICAL ROOF OPENING DETAIL  
3/4" = 1'-0"


## REVISIONS AND UPDATES

02/14/14 CONSTRUCTION DOCUMENTS FOR BID/PERMIT

SUWANNEE COUNTY SCHOOL BOARD  
SUWANNEE PRIMARY SCHOOL  
ADDITIONS AND REMODELING  
1625 WALKER AVE., SW LIVE OAK, FLORIDA

## SECTIONS AND DETAILS

drawn SES checked GCK approved GCK


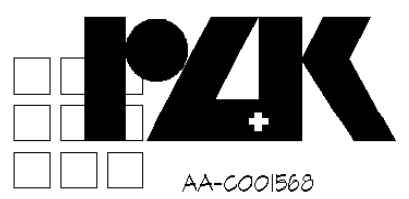


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600 FLORIDA AVENUE SUITE 202 COCOA, FLORIDA 32922 TELEPHONE (321) 631-8039

job no. 2012.51

S-3.2

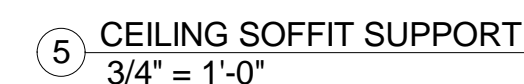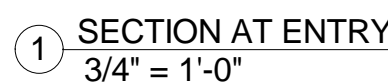

Seal



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PLUMBING SYMBOL LEGEND		PLUMBING ABBREVIATION		GENERAL NOTES
SYMBOL	DESCRIPTION	SYMBOL	DESCRIPTION	
----- AV -----	- ACID VENT	AFF	- ABOVE FINISH FLOOR	1. REFERENCE THE SPECIFICATIONS FOR MATERIAL AND EQUIPMENT INSTALLATION STANDARDS.  2. THE PLUMBING INSTALLATION SHALL COMPLY WITH ALL STATE AND LOCAL CODES.  3. PLANS ARE NOT COMPLETELY TO SCALE. PIPE ROUTING SHOWN IS SCHEMATIC AND IS NOT INTENDED TO INDICATE EXACT ROUTING. CONTRACTOR SHALL PROVIDE ANY CLEARANCES, VERIFY STRUCTURAL, MECHANICAL AND ELECTRICAL INSTALLATIONS AND OTHER POTENTIAL OBSTRUCTIONS AND ROUTE PIPING TO AVOID INTERFERENCES.  4. PROVIDE ALL OFFSETS AND FITTINGS AND MAKE CONNECTION TO SITE UTILITIES.  5. CONCEAL PIPING ABOVE CEILINGS, WITHIN WALLS OR CHASES EXCEPT IN MECHANICAL ROOMS OR AS SPECIFICALLY NOTED.  6. PROVIDE ACCESS PANELS FOR ALL VALVES CONCEALED IN WALLS OR ABOVE NON-ACCESSIBLE CEILINGS.  7. SLEEVE AND/OR FIRESTOP ALL PENETRATIONS THROUGH RATED WALLS, CEILINGS, AND FLOORS WITH UL LISTED ASSEMBLIES. FIRESTOP ASSEMBLIES SHALL BE EQUAL TO OR EXCEED THE RATING OF THE WALL, CEILING OR FLOOR. SEE ARCHITECTURAL DRAWINGS FOR FINAL FINISHES.  8. FLASH AND COUNTER-FLASH ROOF PENETRATIONS.  9. PROVIDE FOUNDATION PAD PENETRATION SLEEVES. ALLOW 1" MINIMUM CLEARANCE BETWEEN SLEEVE INSIDE SURFACE AND PIPE EXTERIOR.  10. SEE ARCHITECTURAL DRAWINGS FOR FIXTURE LOCATIONS AND MOUNTING HEIGHTS.  11. PROVIDE AUTOMATIC TRAP PRIMERS FOR ALL FLOOR DRAIN TRAP SEALS.  12. PROVIDE AN AIR GAP, WHEN REQUIRED BY CODE, SERVING INDIVIDUAL FIXTURES, DEVICES, APPLIANCES AND APPARATUS.  13. ALL EXPOSED PIPE AND FITTINGS IN FINISHED AREAS SHALL BE CHROME PLATED.  14. MOUNT WALL HYDRANTS 24" ABOVE FINISHED GRADE.  15. PROVIDE CLEANOUTS IN ACCORDANCE WITH ALL STATE AND LOCAL CODES. INSTALL CLEANOUT WITH COVER FLUSH TO FINISH SURFACE. PROVIDE WALL CLEANOUTS AT BASE OF EACH SANITARY AND STORM RISER. MOUNT CLEANOUT 24" AFF.  16. COORDINATE EXACT FLOOR DRAIN LOCATIONS WITH ARCHITECTURAL DRAWINGS. SET FLOOR DRAINS BELOW FINISHED FLOOR TO ALLOW FOR FLOOR SLOPING TO THE DRAIN.  17. COORDINATE PIPING WITH ALL ELECTRICAL EQUIPMENT (PANELS, TRANSFORMERS, ETC.) PRIOR TO ANY INSTALLATION. DO NOT ROUTE ANY PIPING OVER ANY ELECTRICAL PANELS UNDER ANY CIRCUMSTANCES. ANY PIPING RUN OVER PANELS SHALL BE RE-ROUTED AT NO ADDITIONAL COST.  18. ALL WALL MOUNTED LAVATORIES SHALL BE ATTACHED TO FLOOR MOUNTED CARRIER DESIGNED TO WITHSTAND A VERTICAL LOAD OF 250 POUNDS ON THE FRONT OF THE FIXTURE.  19. CONTRACTOR SHALL BE RESPONSIBLE FOR LOCATING AND VERIFYING ALL EXISTING UTILITIES BELOW GRADE PRIOR TO CONSTRUCTION. CONTRACTOR SHALL COORDINATE WITH THE UTILITY COMPANIES TO RELOCATE ANY EXISTING UTILITIES THAT MAY INTERFERE WITH THE PROPOSED CONSTRUCTION. CONTRACTOR SHALL CALL "FLORIDA ONE CALL" AT 1-800-SUN-SHINE 48 HOURS BEFORE DIGGING.  20. ROOF DRAINAGE FOR BUILDING IS PROVIDED BY GUTTERS AND DOWNSPOUTS. SEE ARCHITECTURAL DRAWINGS FOR ADDITIONAL INFORMATION.
----- AW -----	- ACID WASTE	AW	- ACID WASTE	
----- AW -----	- ACID WASTE	AV	- ACID VENT	
----- AW -----	- BELOW GROUND ACID WASTE	CA	- COMPRESSED AIR	
----- CD -----	- ABOVE GROUND CONDENSATE DRAIN	CD	- CONDENSATE DRAIN	
----- CD -----	- BELOW GROUND CONDENSATE DRAIN	CFH	- CUBIC FEET PER HOUR	
----- CA -----	- COMPRESSED AIR	CO	- CLEANOUT	
----- SW -----	- SOFTEN WATER	CONT	- CONTINUATION	
----- -----	- DOMESTIC COLD WATER	CW	- DOMESTIC COLD WATER	
----- -----	- DOMESTIC HOT WATER	DN	- DOWN	
----- -----	- DOMESTIC HOT WATER RECIRCULATING	DS	- DOWNSPOUT	
G	- GAS	DWG	- DRAWING	
GR	- KITCHEN WASTE (GREASE)	EXIST	- EXISTING	
S	- ABOVE GROUND SANITARY	°F	- DEGREE FAHRENHEIT	
S	- BELOW GROUND SANITARY	FCO	- FLOOR CLEANOUT	
----- -----	- SANITARY VENT	FD	- FLOOR DRAIN	
ST	- ABOVE GROUND STORM	FS	- FLOOR SINK	
ST	- BELOW GROUND STORM	G	- GAS	
STO	- OVERFLOW STORM DRAIN	GPH	- GALLONS PER HOUR	
STO	- BELOW GROUND OVERFLOW STORM	GPM	- GALLONS PER MINUTE	
M	- WATER METER	GR	- KITCHEN WASTE (GREASE)	
H-G	- HOSE BIBB OR WALL HYDRANT	HB	- HOSE BIBB	
CO I	- CLEAN OUT PLUG	HD	- HUB DRAIN	
CO I	- WALL CLEANOUT	HW	- DOMESTIC HOT WATER	
CO	- FLOOR CLEAN OUT	HWR	- DOMESTIC HOT WATER RECIRCULATING	
FD	- FLOOR DRAIN	IE	- INVERT ELEVATION	
FS	- ROOF DRAIN	IW	- INDIRECT WASTE	
FS	- FLOOR SINK	KW	- KILOWATT	
FS	- SHUT-OFF VALVE IN VALVE BOX	LBS	- POUNDS	
FS	- SHUTOFF VALVE	MH	- MANHOLE	
FS	- BALL VALVE	NC	- NORMALLY CLOSED	
FS	- CALIBRATED BALANCING VALVE	NIC	- NOT IN CONTRACT	
FS	- CHECK VALVE (SWING)	NO	- NORMALLY OPEN	
FS	- PRESSURE REDUCING VALVE	OD	- OUTSIDE DIAMETER	
FS	- SOLENOID OPERATED VALVE	PSI	- POUNDS PER SQUARE INCH	
FS	- REDUCED PRESSURE BACKFLOW PREVENTER	PVC	- POLYVINYL CHLORIDE PIPE	
FS	- RELIEF OR SAFETY VALVE	RD	- ROOF DRAIN	
FS	- GAS COCK	RBPB	- REDUCED PRESSURE BACKFLOW PREVENTOR	
FS	- GAS PRESSURE REGULATOR	SAN	- SANITARY	
FS	- SHUTOFF VALVE ON RISER	SD	- STORM DRAIN	
FS	- GAS COCK ON RISER	SF	- SQUARE FEET	
FS	- CONNECTION, TOP	SH	- SHEET	
FS	- CONNECTION, BOTTOM	ST	- STORM	
FS	- ELBOW, TURNED DOWN	STO	- OVERFLOW STORM DRAIN	
FS	- ELBOW, TURNED UP	SW	- SOFTEN WATER	
FS	- TEE, TURNED UP	VAC	- VACUUM	
FS	- TEE, TURNED DOWN	VTR	- VENT THRU ROOF	
FS	- CAP	WCO	- WALL CLEANOUT	
FS	- DIRECTION OF FLOW	WTR	- WATER	
FS	- REVISION REFERENCE			

NOTE: SOME SYMBOLS SHOWN ON THIS LEGEND MAY NOT PERTAIN TO THIS PROJECT

WC-1 FLOOR MOUNTED ACCESSIBLE WATER CLOSET

VITREOUS CHINA, 1.28 GALLON, FLOOR MOUNTED, ACCESSIBLE HEIGHT, SIPHON JET, ELONGATED CLOSET BOWL WITH 1-1/2" TOP SPUD.

1.28 GALLON CHROME PLATED FLUSH VALVE (EXPOSED), 1-INCH I.P.S. SCREW DRIVER ANGLE STOP WITH PROTECTIVE CAP, ADJUSTABLE TAILPIECE, VACUUM BREAKER FLUSH CONNECTION AND SPUD COUPLING FOR 1-1/2" TOP SPUD, DIE CAST WALL FLANGE WITH SET SCREW, SPUD FLANGE, SOLID RING PIPE SUPPORT AND ADA HANDLE.

SEAT SHALL BE EXTRA HEAVY SOLID PLASTIC WITH STAINLESS STEEL SELF SUSTAINING CHECK HINGE, OPEN FRONT LESS COVER.

NOTE: FLUSH VALVE HANDLE SHALL FACE WIDE SIDE OF STALL OR ROOM.

BASIS OF DESIGN

CHINA - AMERICAN STANDARD - 3043.001.020  
FLUSH VALVE - AMERICAN STANDARD - 8047121.002/80685810  
SEAT - BEMIS - 1665-SS

WC-1 WALL HUNG LAVATORY, STANDARD SPOUT WRIST BLADE HANDLES

VITREOUS CHINA LAVATORY, 20" X 16", PUNCHED FOR 4" CENTERSET FITTING AND CONCEALED ARM CARRIER SUPPORT.

4" CENTERSET CHROME PLATED BRASS FAUCET, VANDAL RESISTANT 0.5 GPM FLOW REGULATOR, CHROME PLATED WRISTBLADE HANDLES WITH HOT AND COLD WATER CODED INDEXES.


CHROME PLATED STRAINER, CAST GRID STRAINER WITH 1-1/4" TAILPIECE, PLATED 17 GAUGE 1-1/4"X1-1/2" BRASS P-TRAP WITH CLEANOUT.

1/2" COMPRESSION X 3/8" COMPRESSION CHROME PLATED ANGLE SUPPLY STOPS WITH CHROME PLATED 12" FLEXIBLE RISERS AND ESCUTCHEONS.

FULLY ADJUSTABLE LAVATORY CARRIER ADJUSTED TO STANDARD HEIGHT.

BASIS OF DESIGN

CHINA - AMERICAN STANDARD - 0355.012  
FAUCET - T&S BRASS - B-0890-VF05  
STRAINER/TRAP - MCGUIRE - 155A/8902  
SUPPLIES - MCGUIRE - 2165CC  
CARRIER - ZURN ZR-1200 SERIES

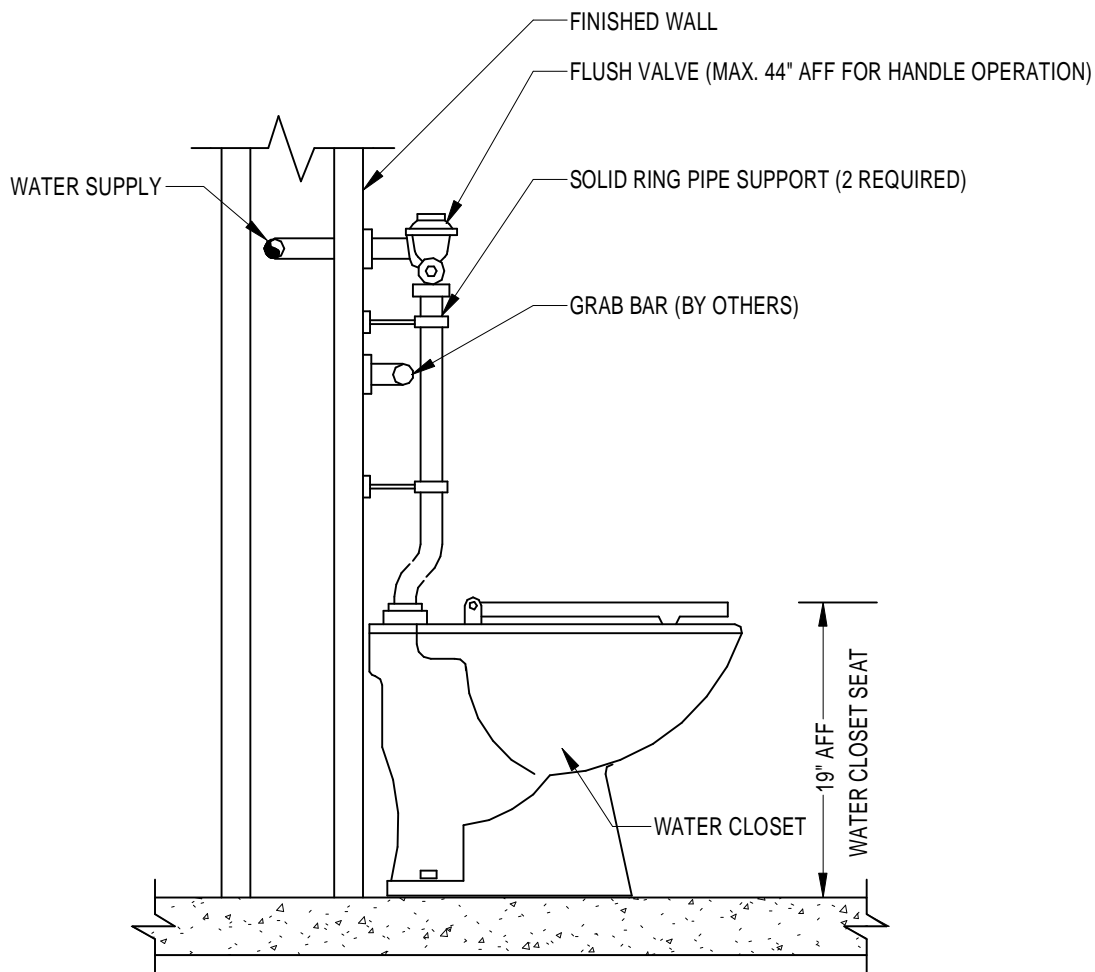

THE HANDLE OF THE FLUSH VALVE SHALL FACE THE WIDE SIDE OF THE STALL (NO EXCEPTIONS).


1 WATER CLOSET  
N.T.S.

REVISIONS AND UPDATES

02/14/14	CONSTRUCTION DOCUMENTS FOR BID/PERMIT

SUWANNEE COUNTY SCHOOL BOARD  
SUWANNEE PRIMARY SCHOOL  
ADDITIONS AND REMODELING  
1625 WALKER AVE., SW LIVE OAK, FLORIDA  
PLUMBING LEGEND AND NOTES

drawn TMM checked JPM approved JPM

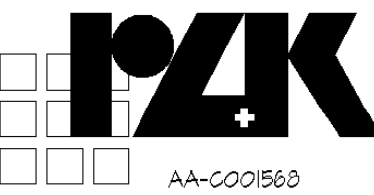


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P-0.1


ARCHITECTS RZK, INC.  
600 FLORIDA AVENUE SUITE 202 COCOA, FLORIDA 32922 TELEPHONE (321) 631-8039

Justin Mulhollan, P.E.  
Florida License #71647

Seal

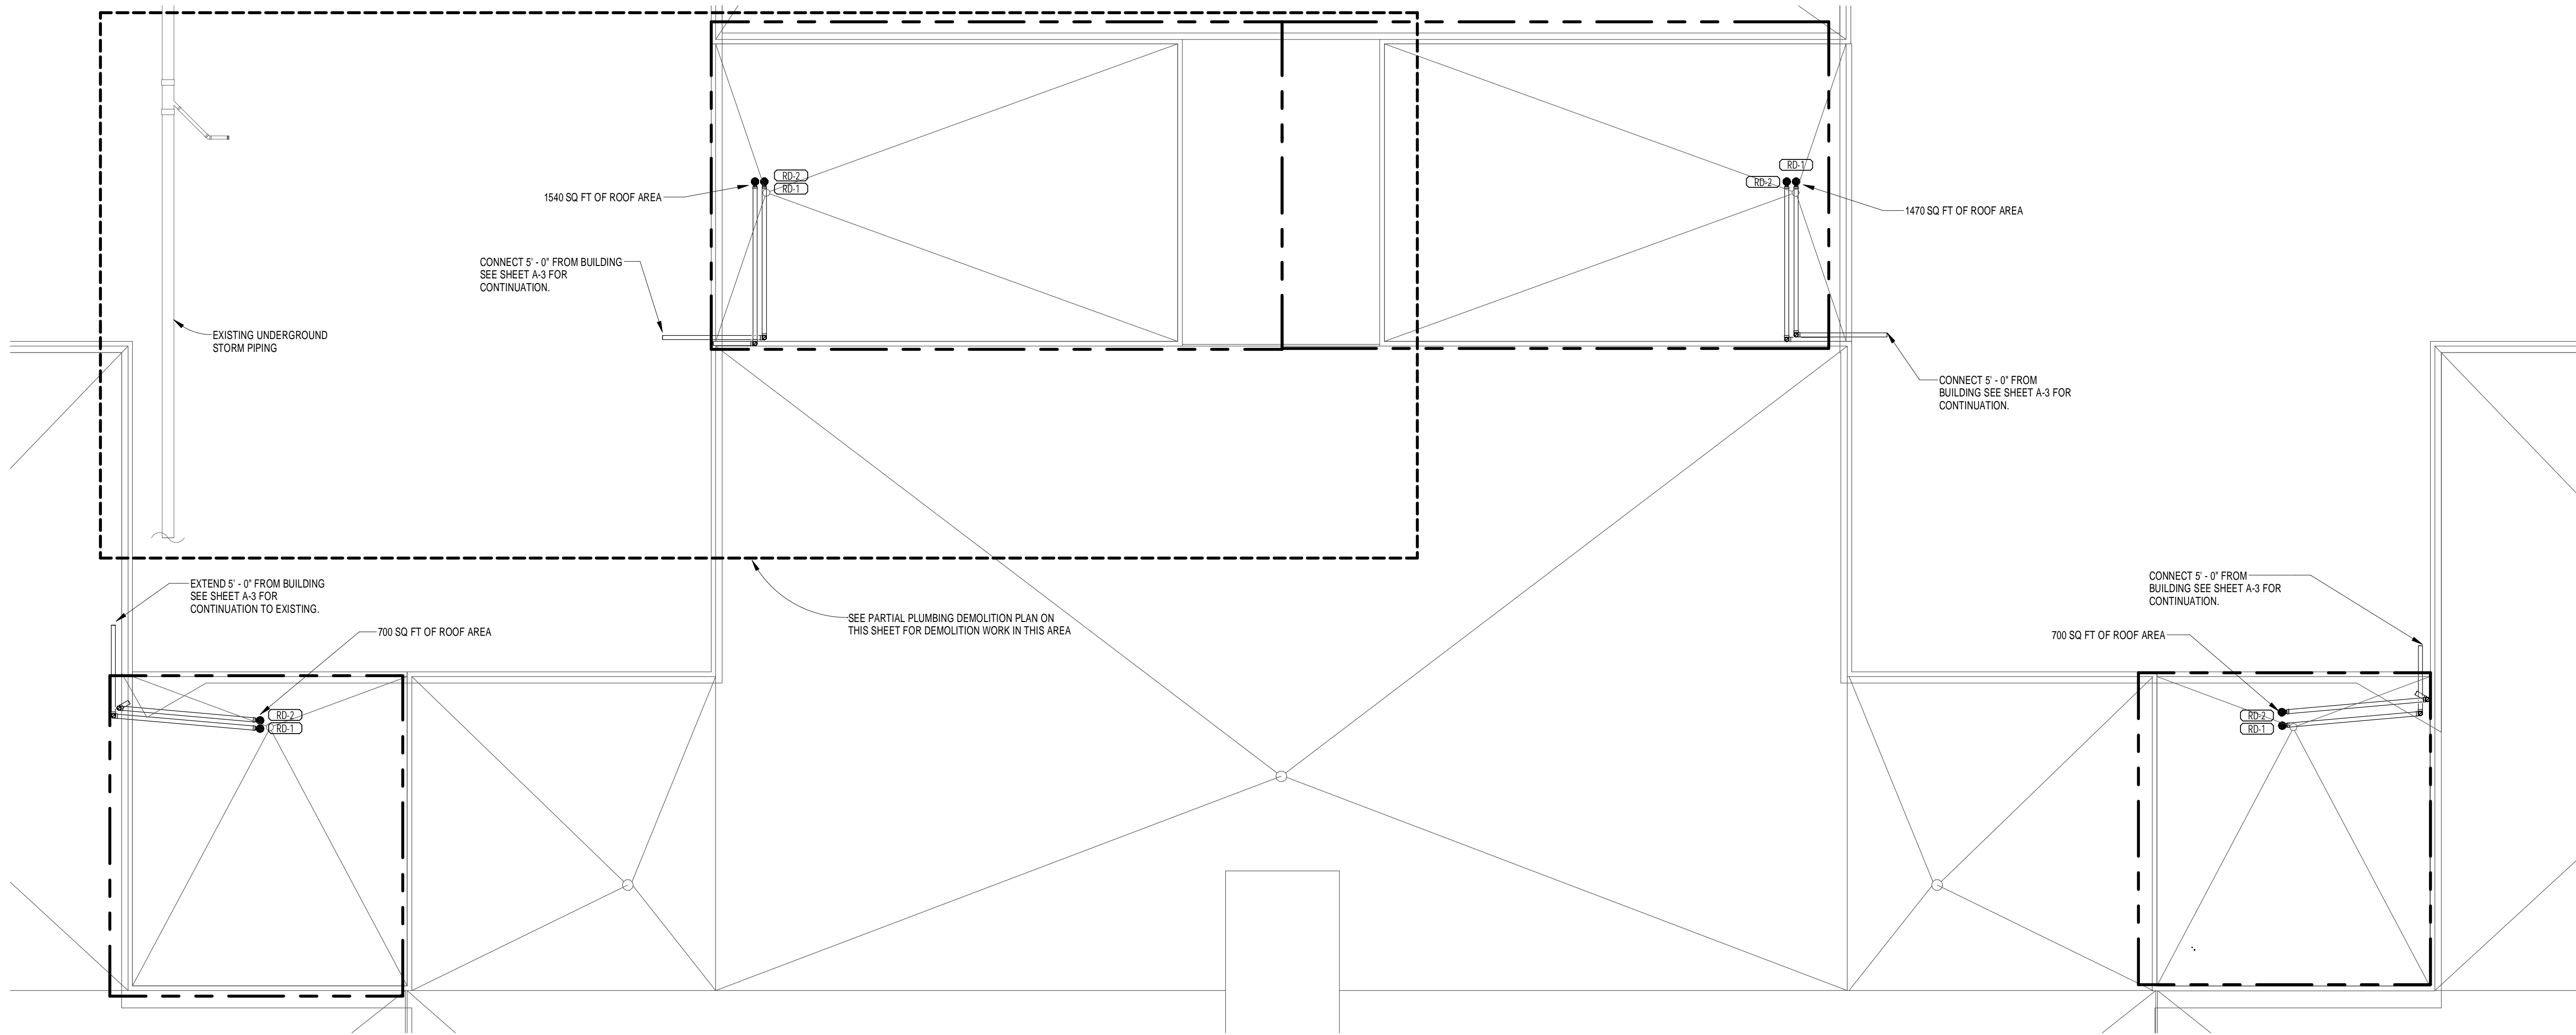

1 PLUMBING ROOF PLAN  
1/8" = 1'-0"

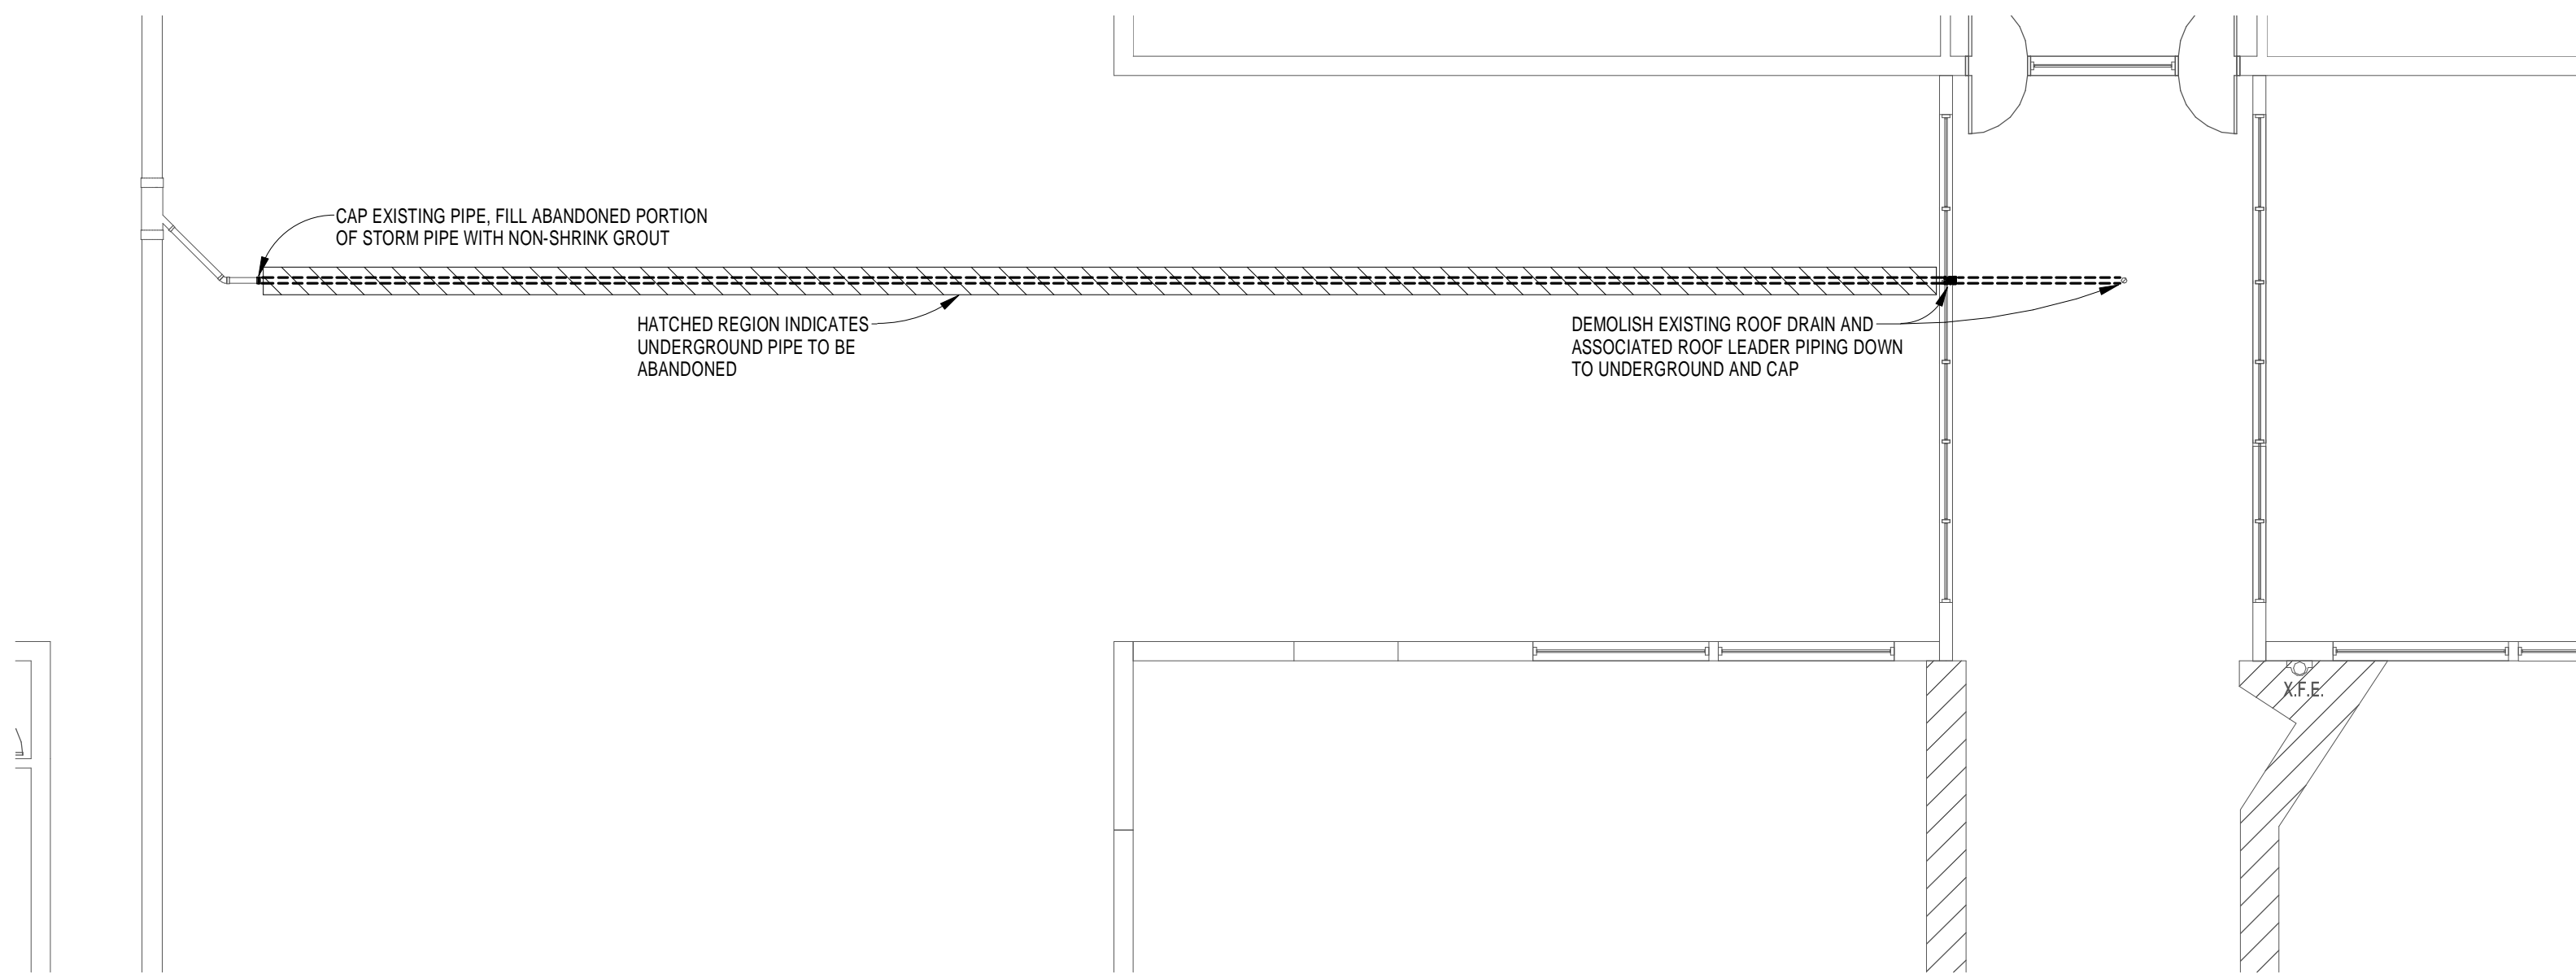


2 PARTIAL PLUMBING DEMOLITION PLAN  
1/8" = 1'-0"

REVISIONS AND UPDATES

02/14/14 CONSTRUCTION DOCUMENTS FOR BID/PERMIT

SUWANNEE COUNTY SCHOOL BOARD  
SUWANNEE PRIMARY SCHOOL  
ADDITIONS AND REMODELING  
1625 WALKER AVE., SW LIVE OAK, FLORIDA  
PLUMBING ROOF PLAN

drawn GS checked JPM approved JPM

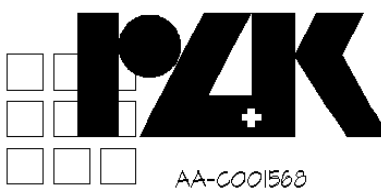

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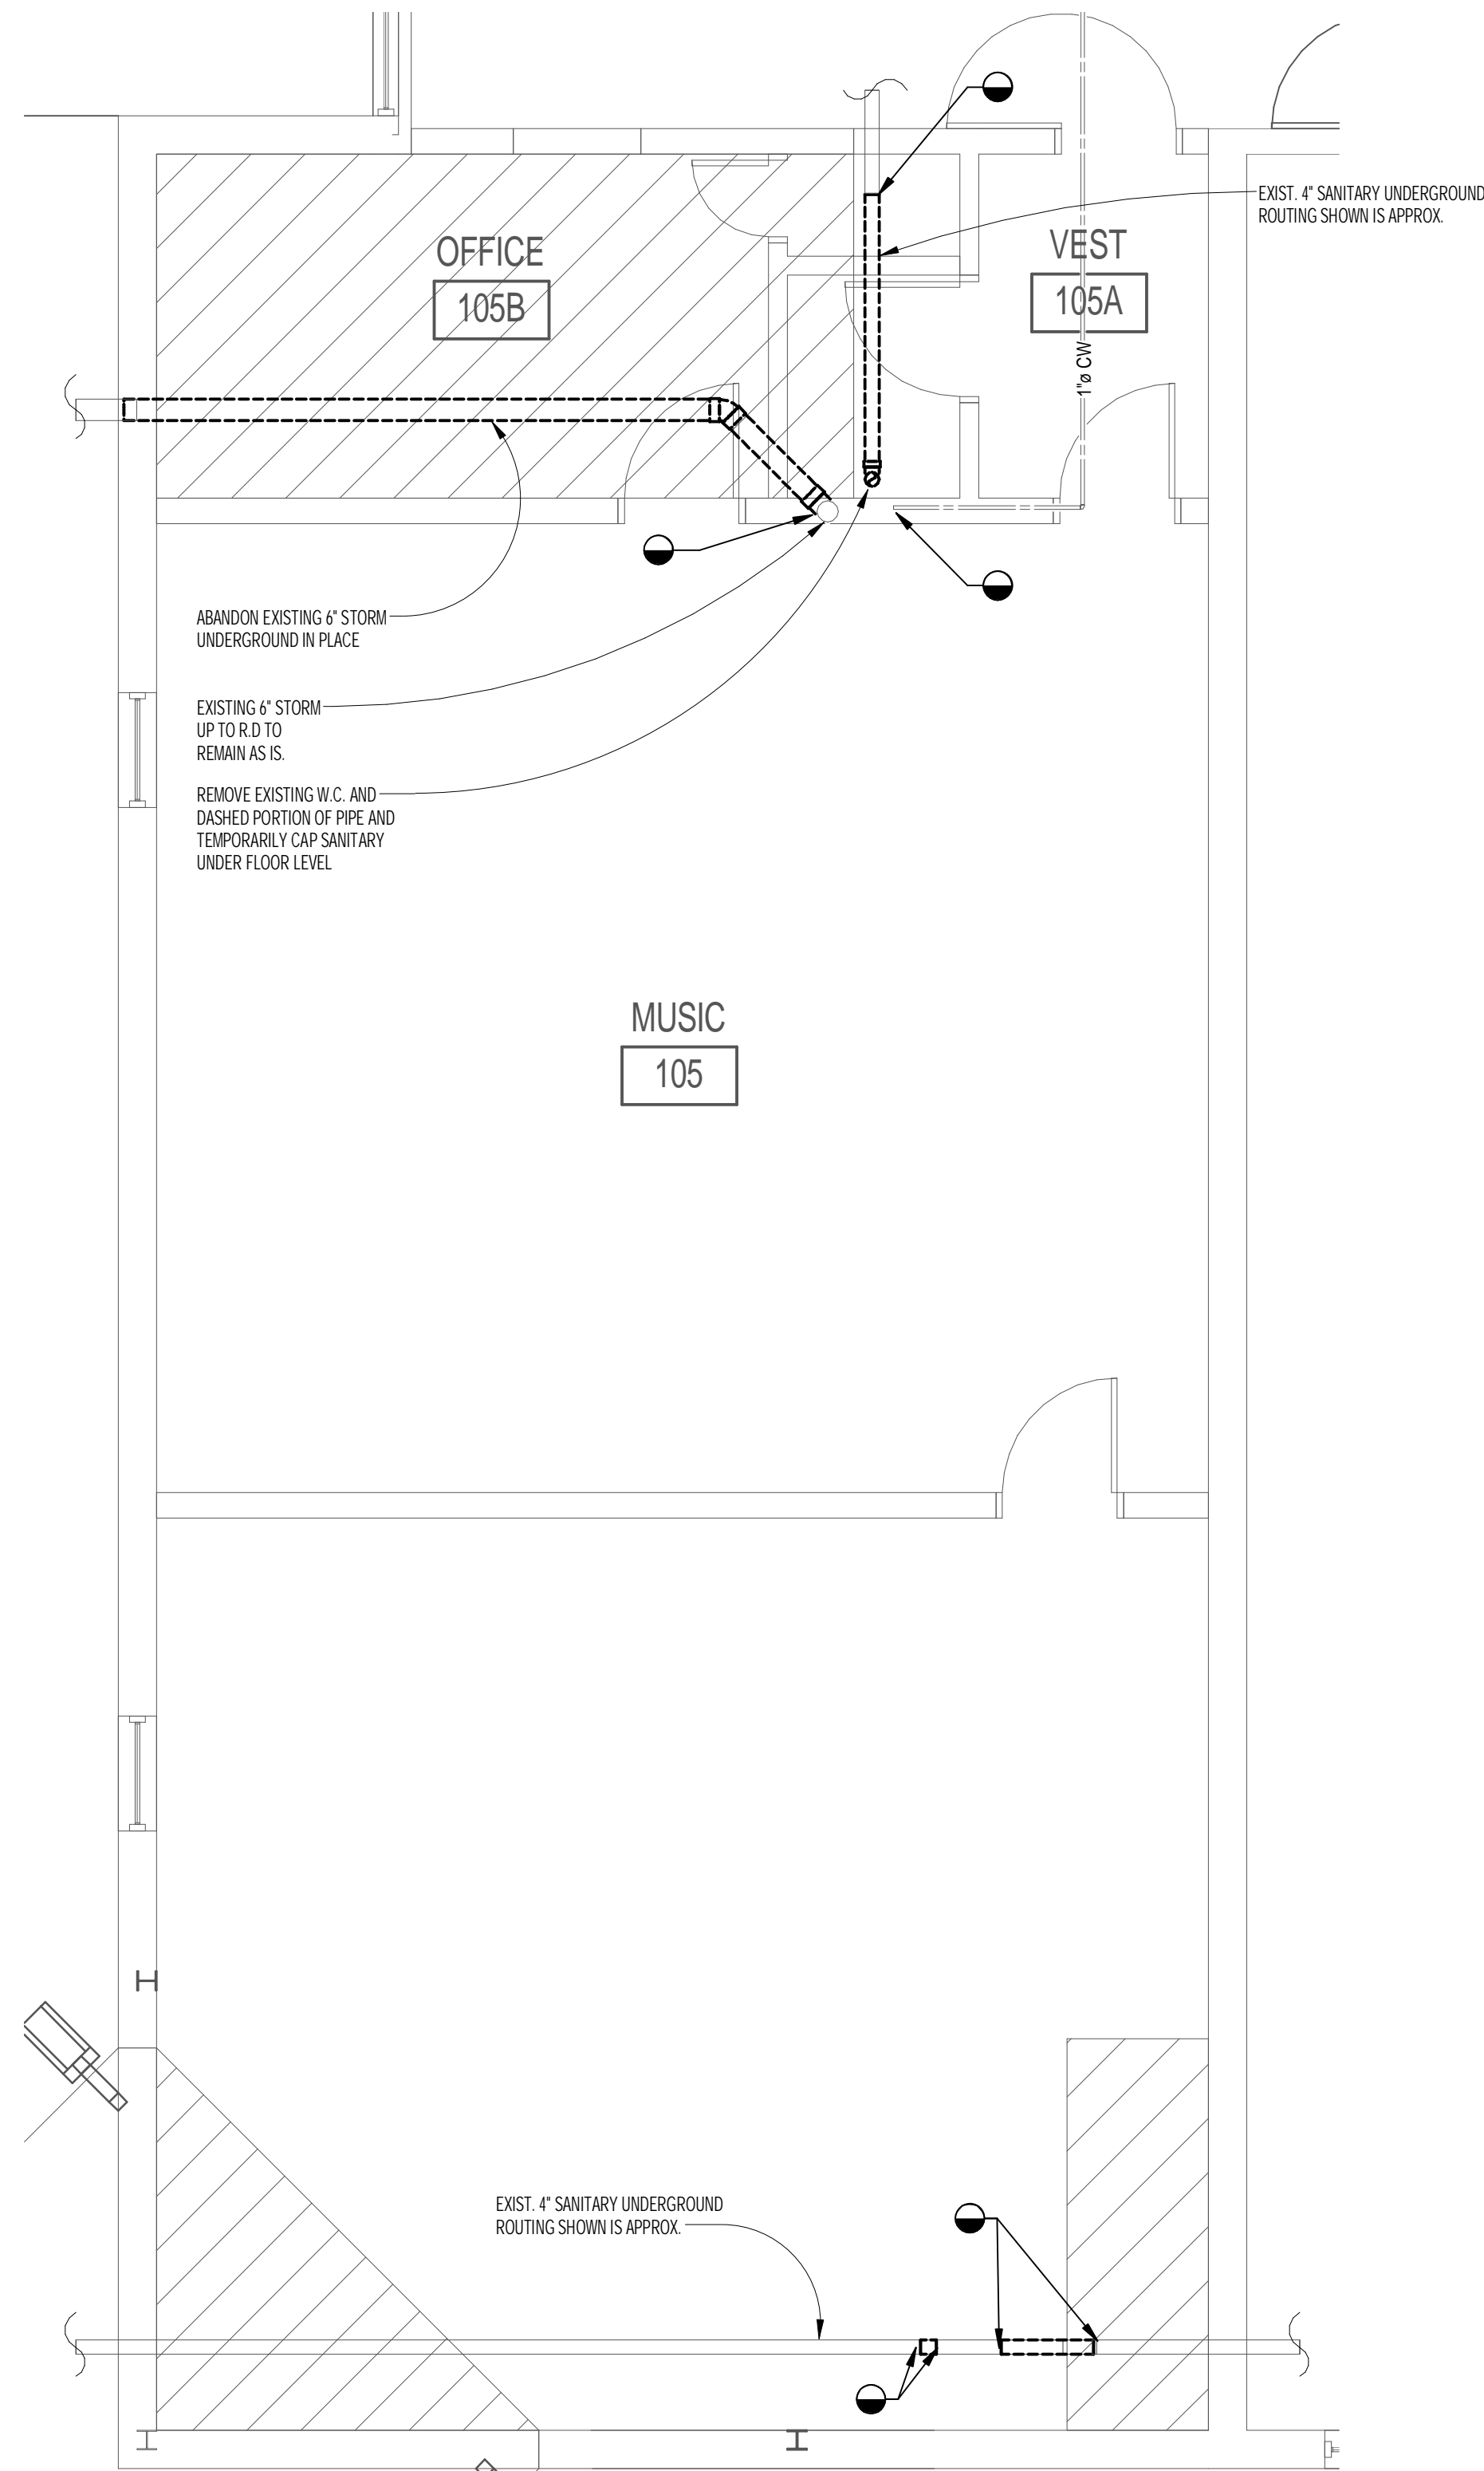
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Florida License #71647


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2 NEW ENTRANCE PLUMBING DEMOLITION PLAN  
1/4" = 1'-0"




1 NEW ENTRANCE PLUMBING PLAN  
1/4" = 1'-0"

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Florida License #71647

Seal
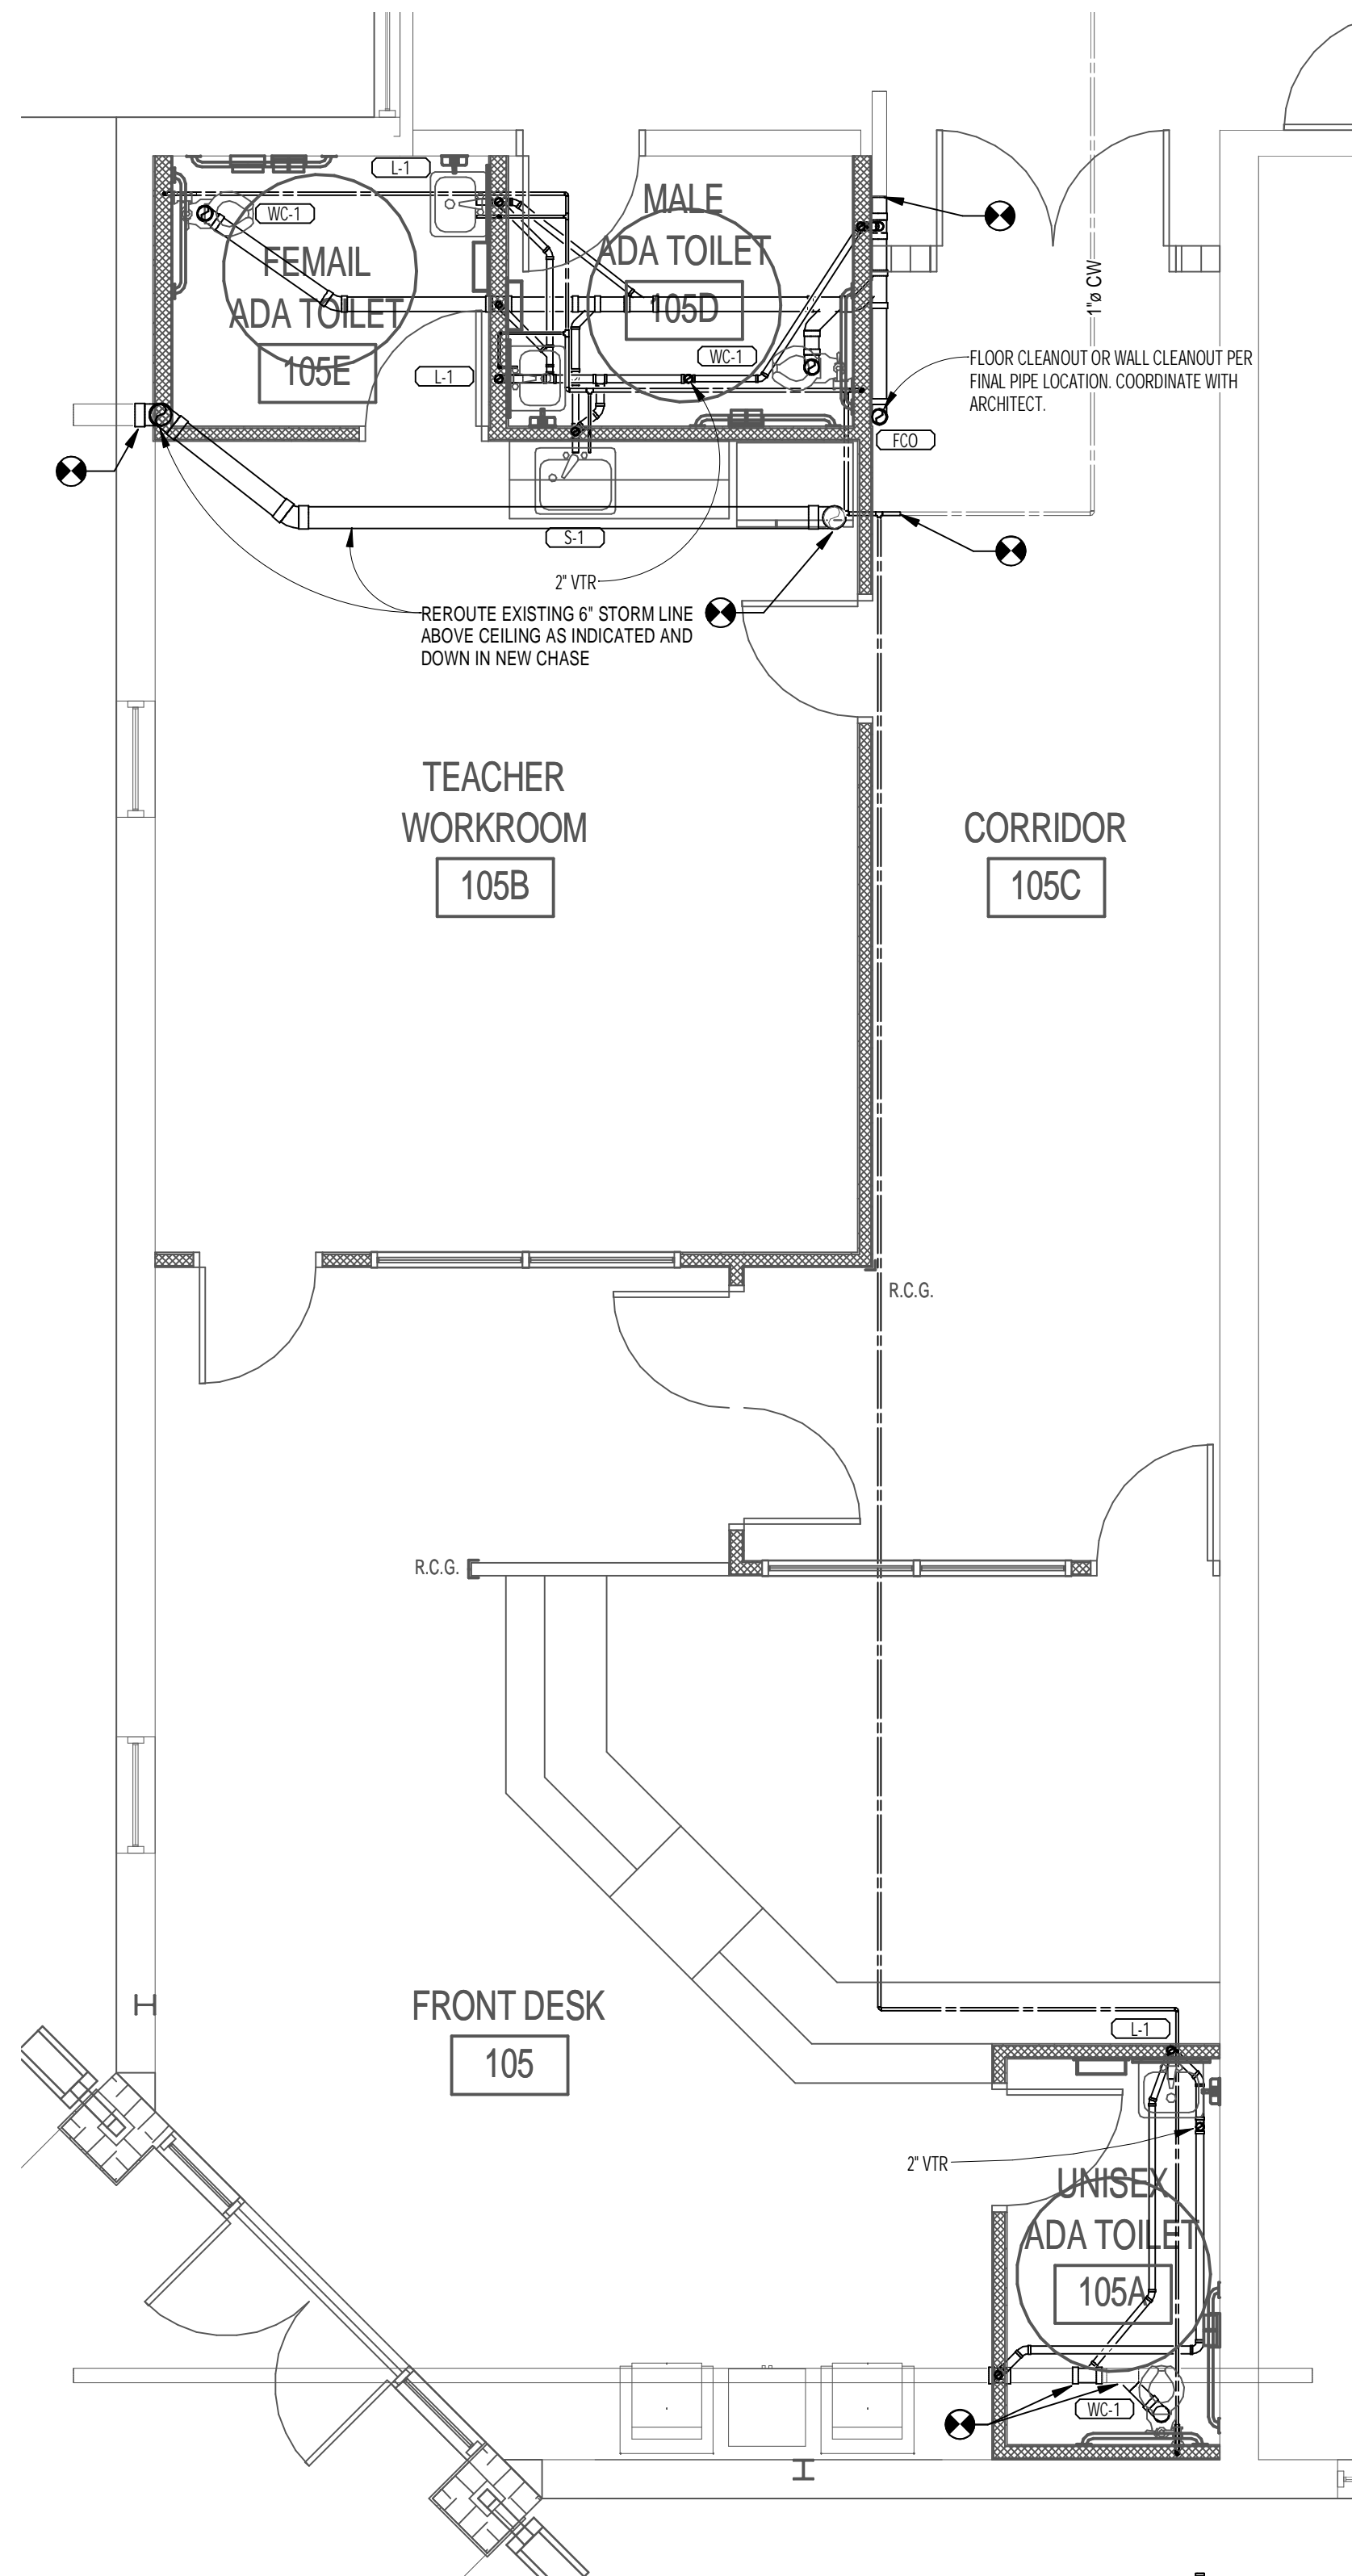
#### KEY PLAN

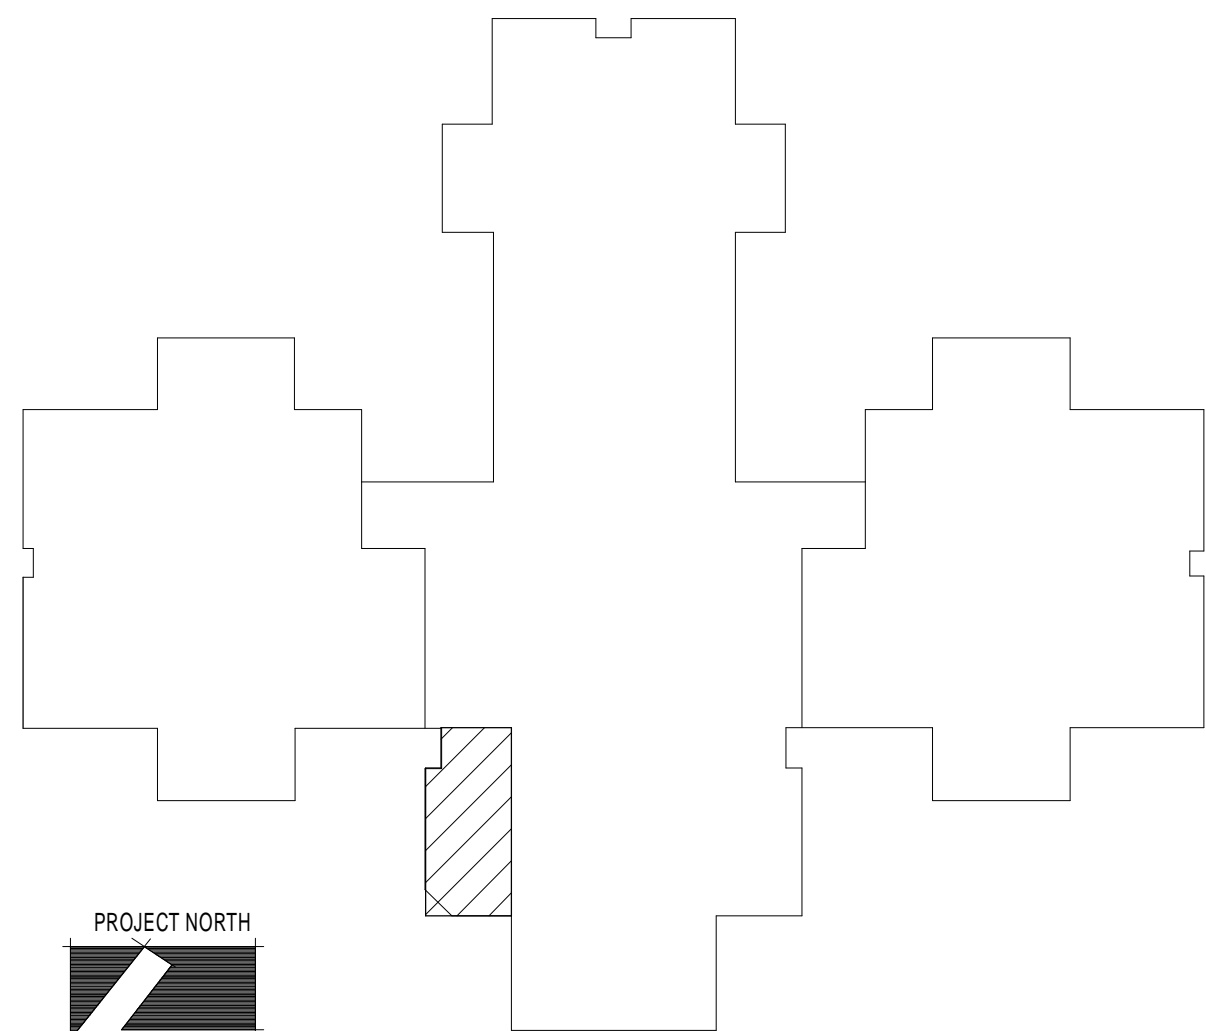


#### REVISIONS AND UPDATES

02/14/14	CONSTRUCTION DOCUMENTS FOR BID/PERMIT

SUWANNEE COUNTY SCHOOL BOARD  
**SUWANNEE PRIMARY SCHOOL**  
**ADDITIONS AND REMODELING**  
1625 WALKER AVE., SW LIVE OAK, FLORIDA  
**PLUMBING ENLARGED PLANS**


drawn **GS** checked **JPM** approved **JPM**

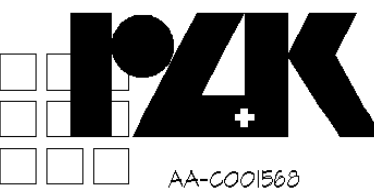

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job no. 2012.51

P-1.1

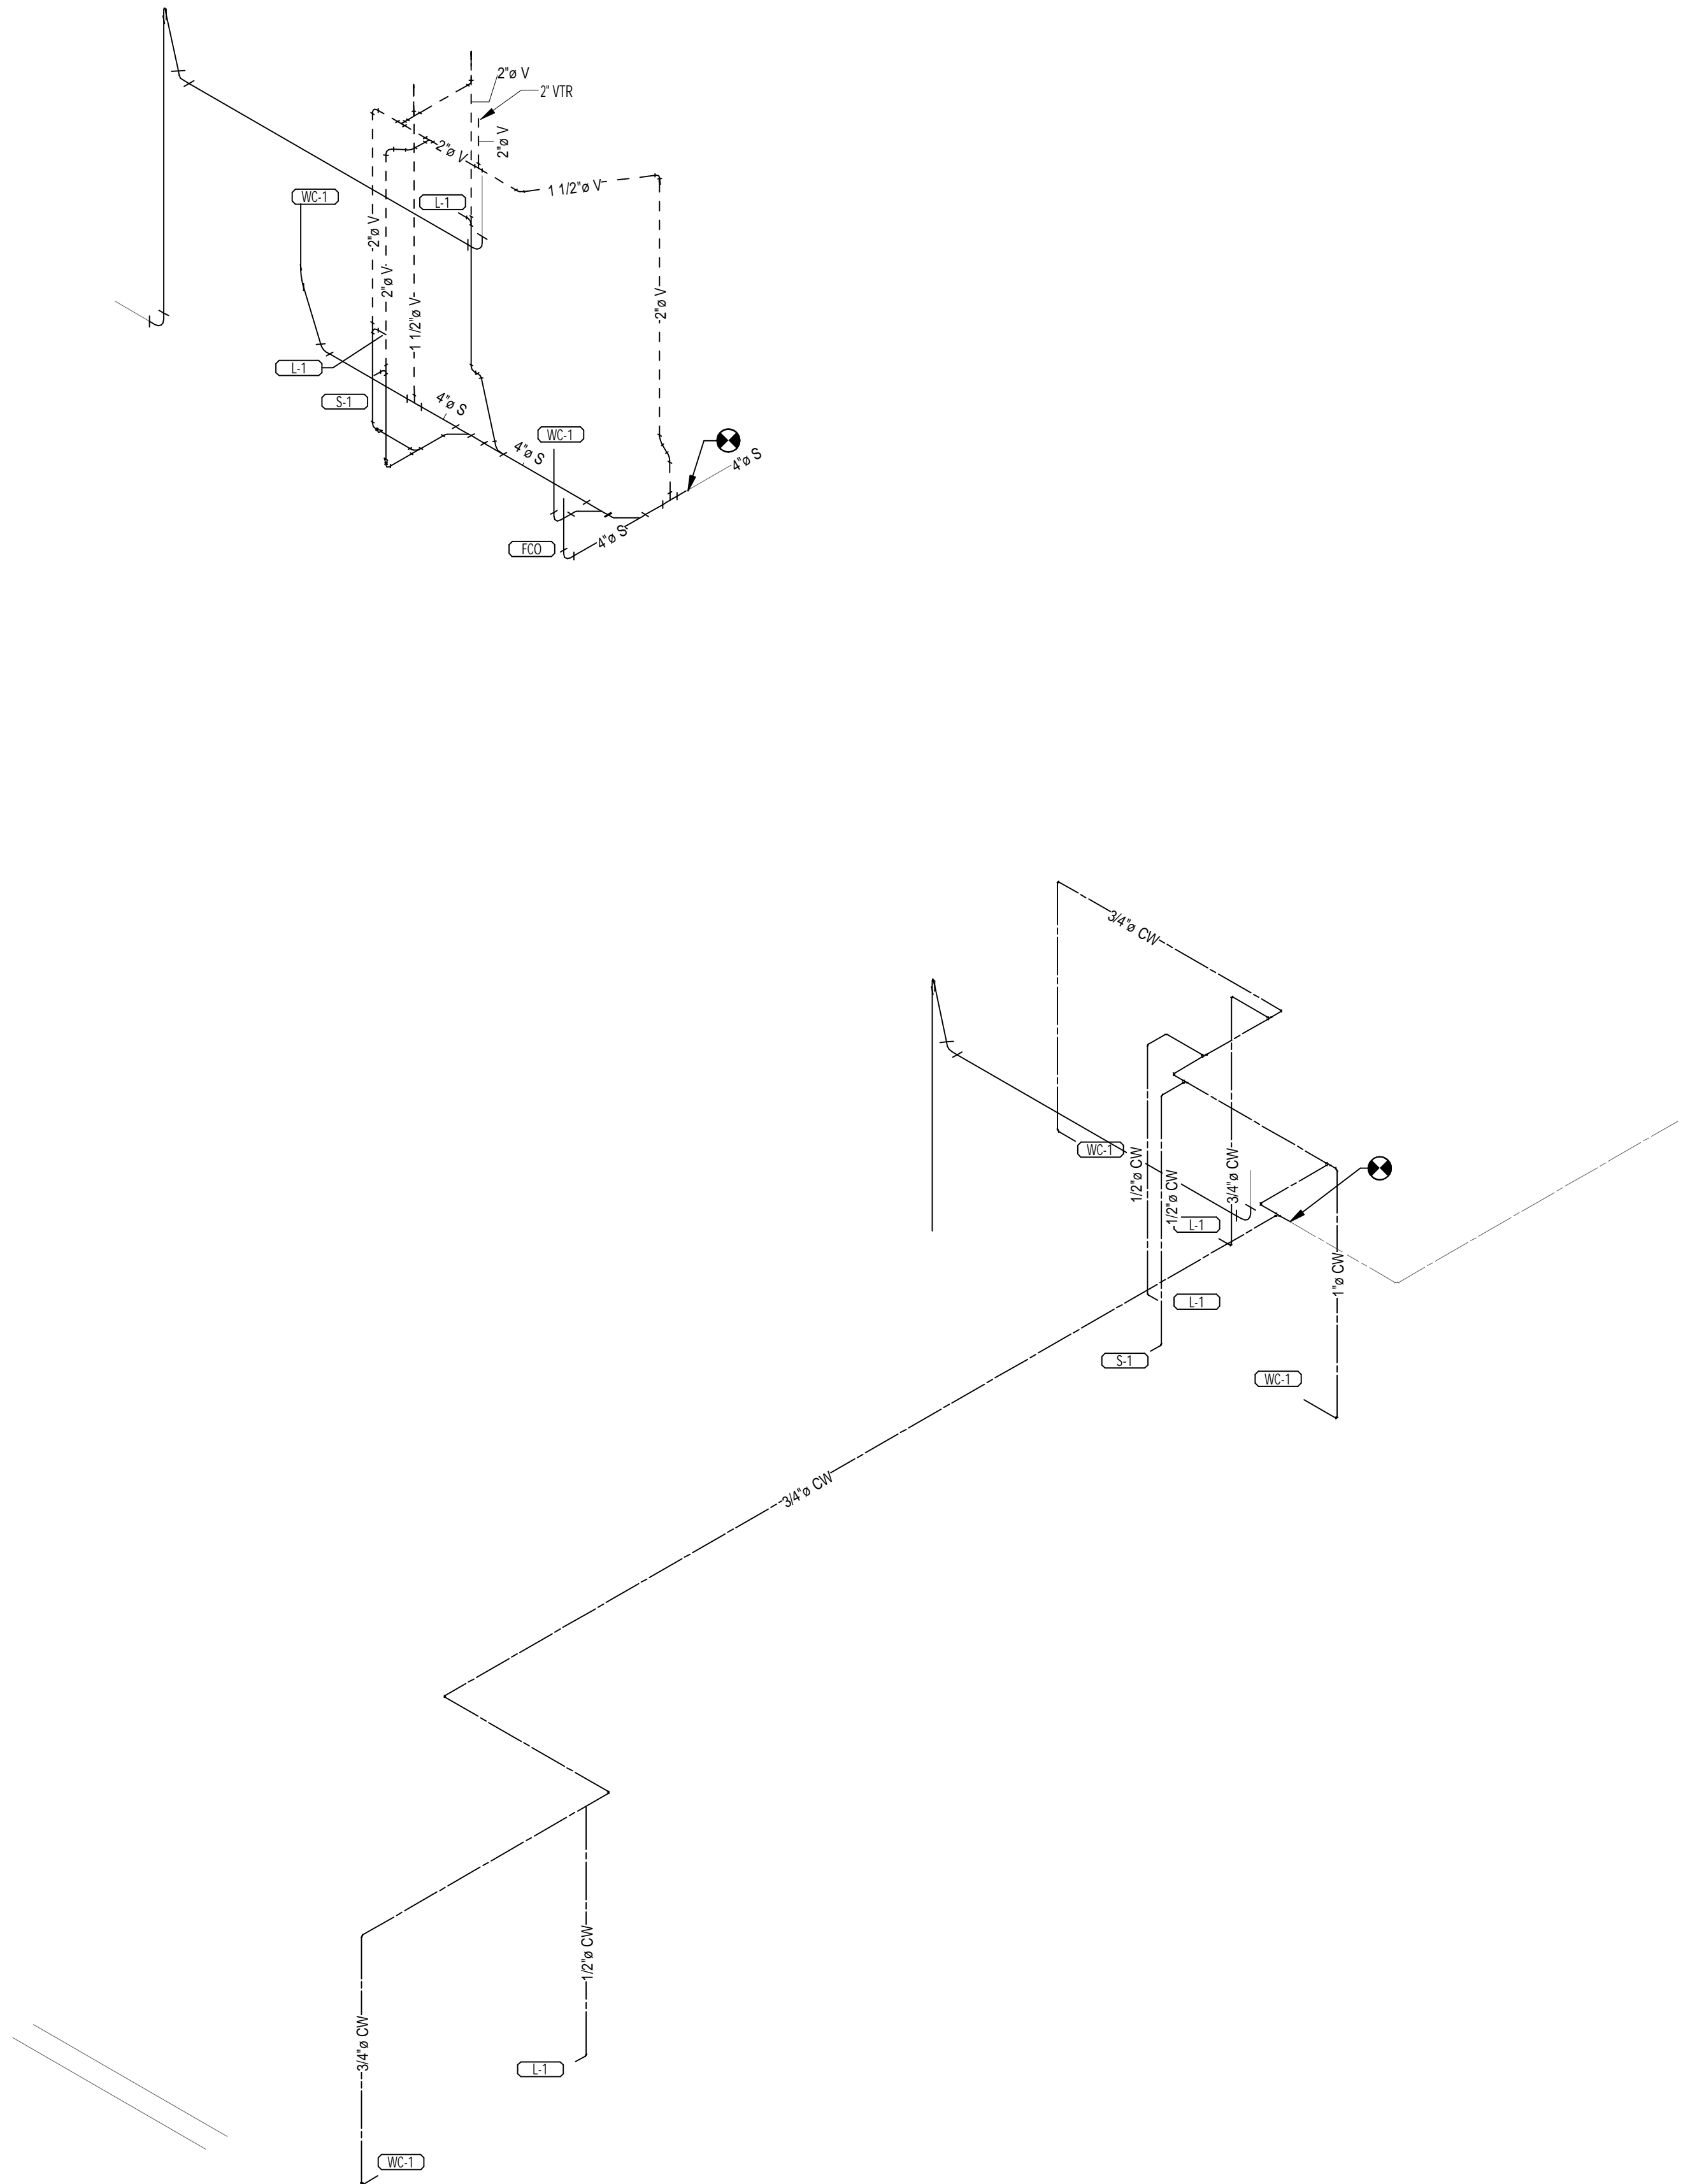

2 SANITARY ISOMETRIC

1 PRESSURE ISOMETRIC

REVISIONS AND UPDATES		
02/14/14	CONSTRUCTION DOCUMENTS FOR BID/PERMIT	

SUWANNEE COUNTY SCHOOL BOARD  
SUWANNEE PRIMARY SCHOOL  
ADDITIONS AND REMODELING  
1625 WALKER AVE., SW      LIVE OAK, FLORIDA

PLUMBING ISOMETRIC PLANS

drawn GS	checked JPM	approved JPM
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AA-0001560

**RZK**

ARCHITECTS RZK, INC.  
600 FLORIDA AVENUE SUITE 202 COCOA, FLORIDA 32922    TELEPHONE (321) 631-8039

job no. 2012.51

P-1.2




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
Seal








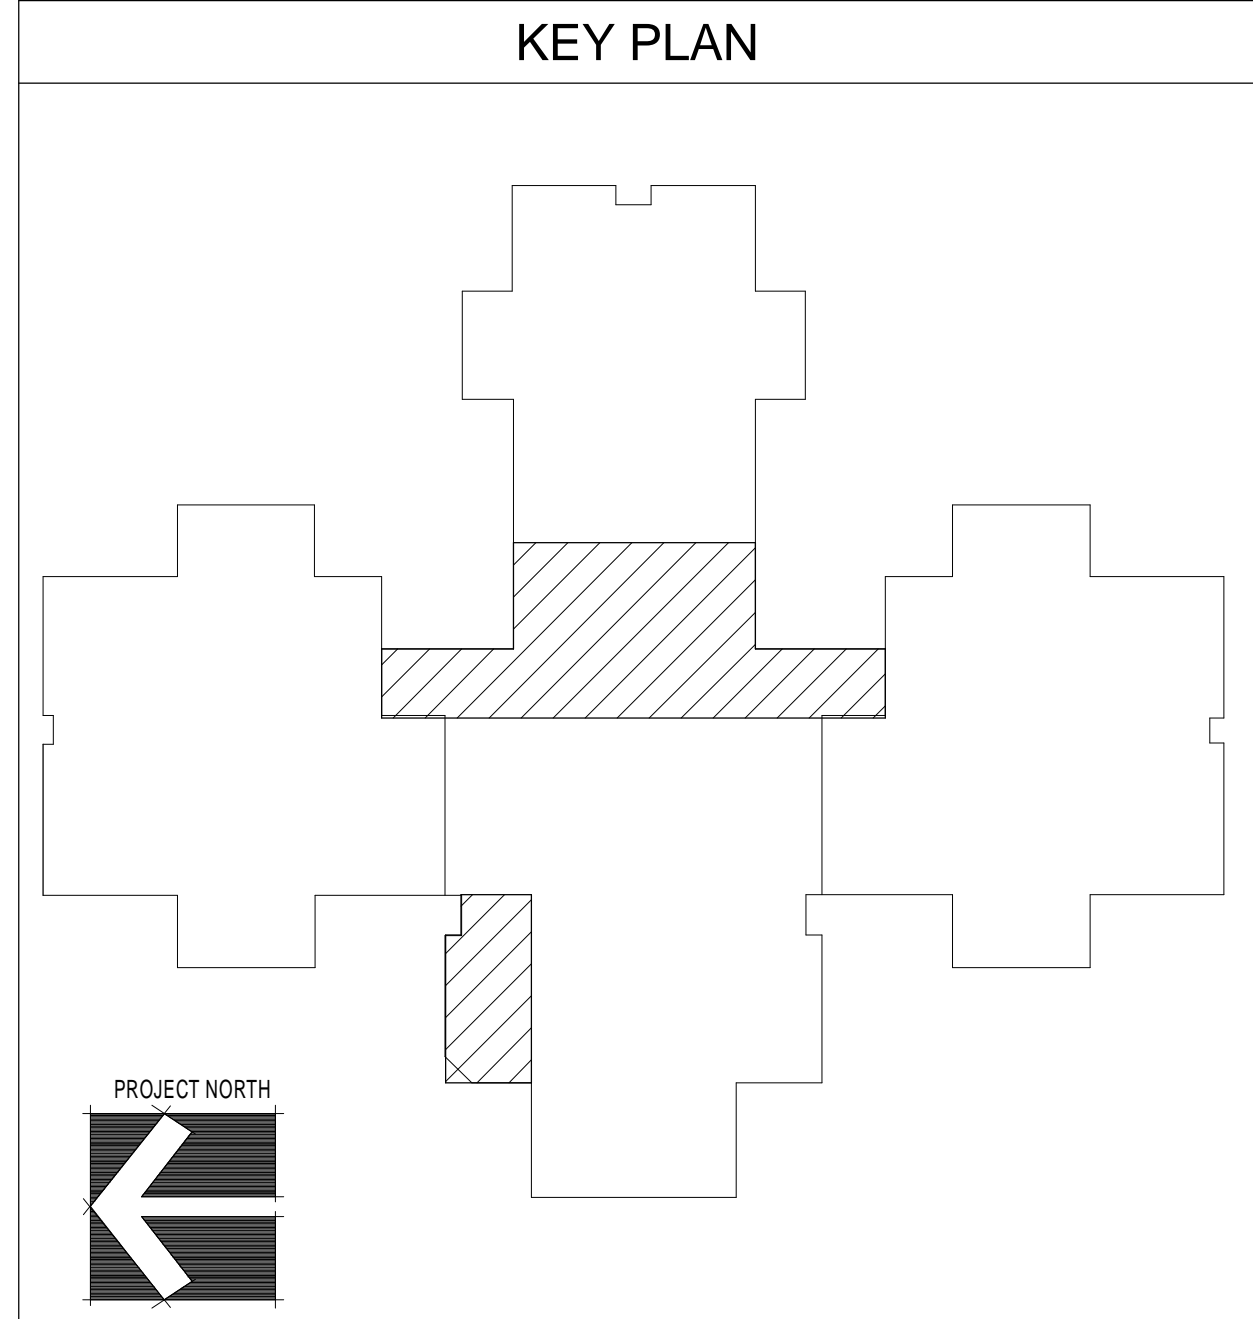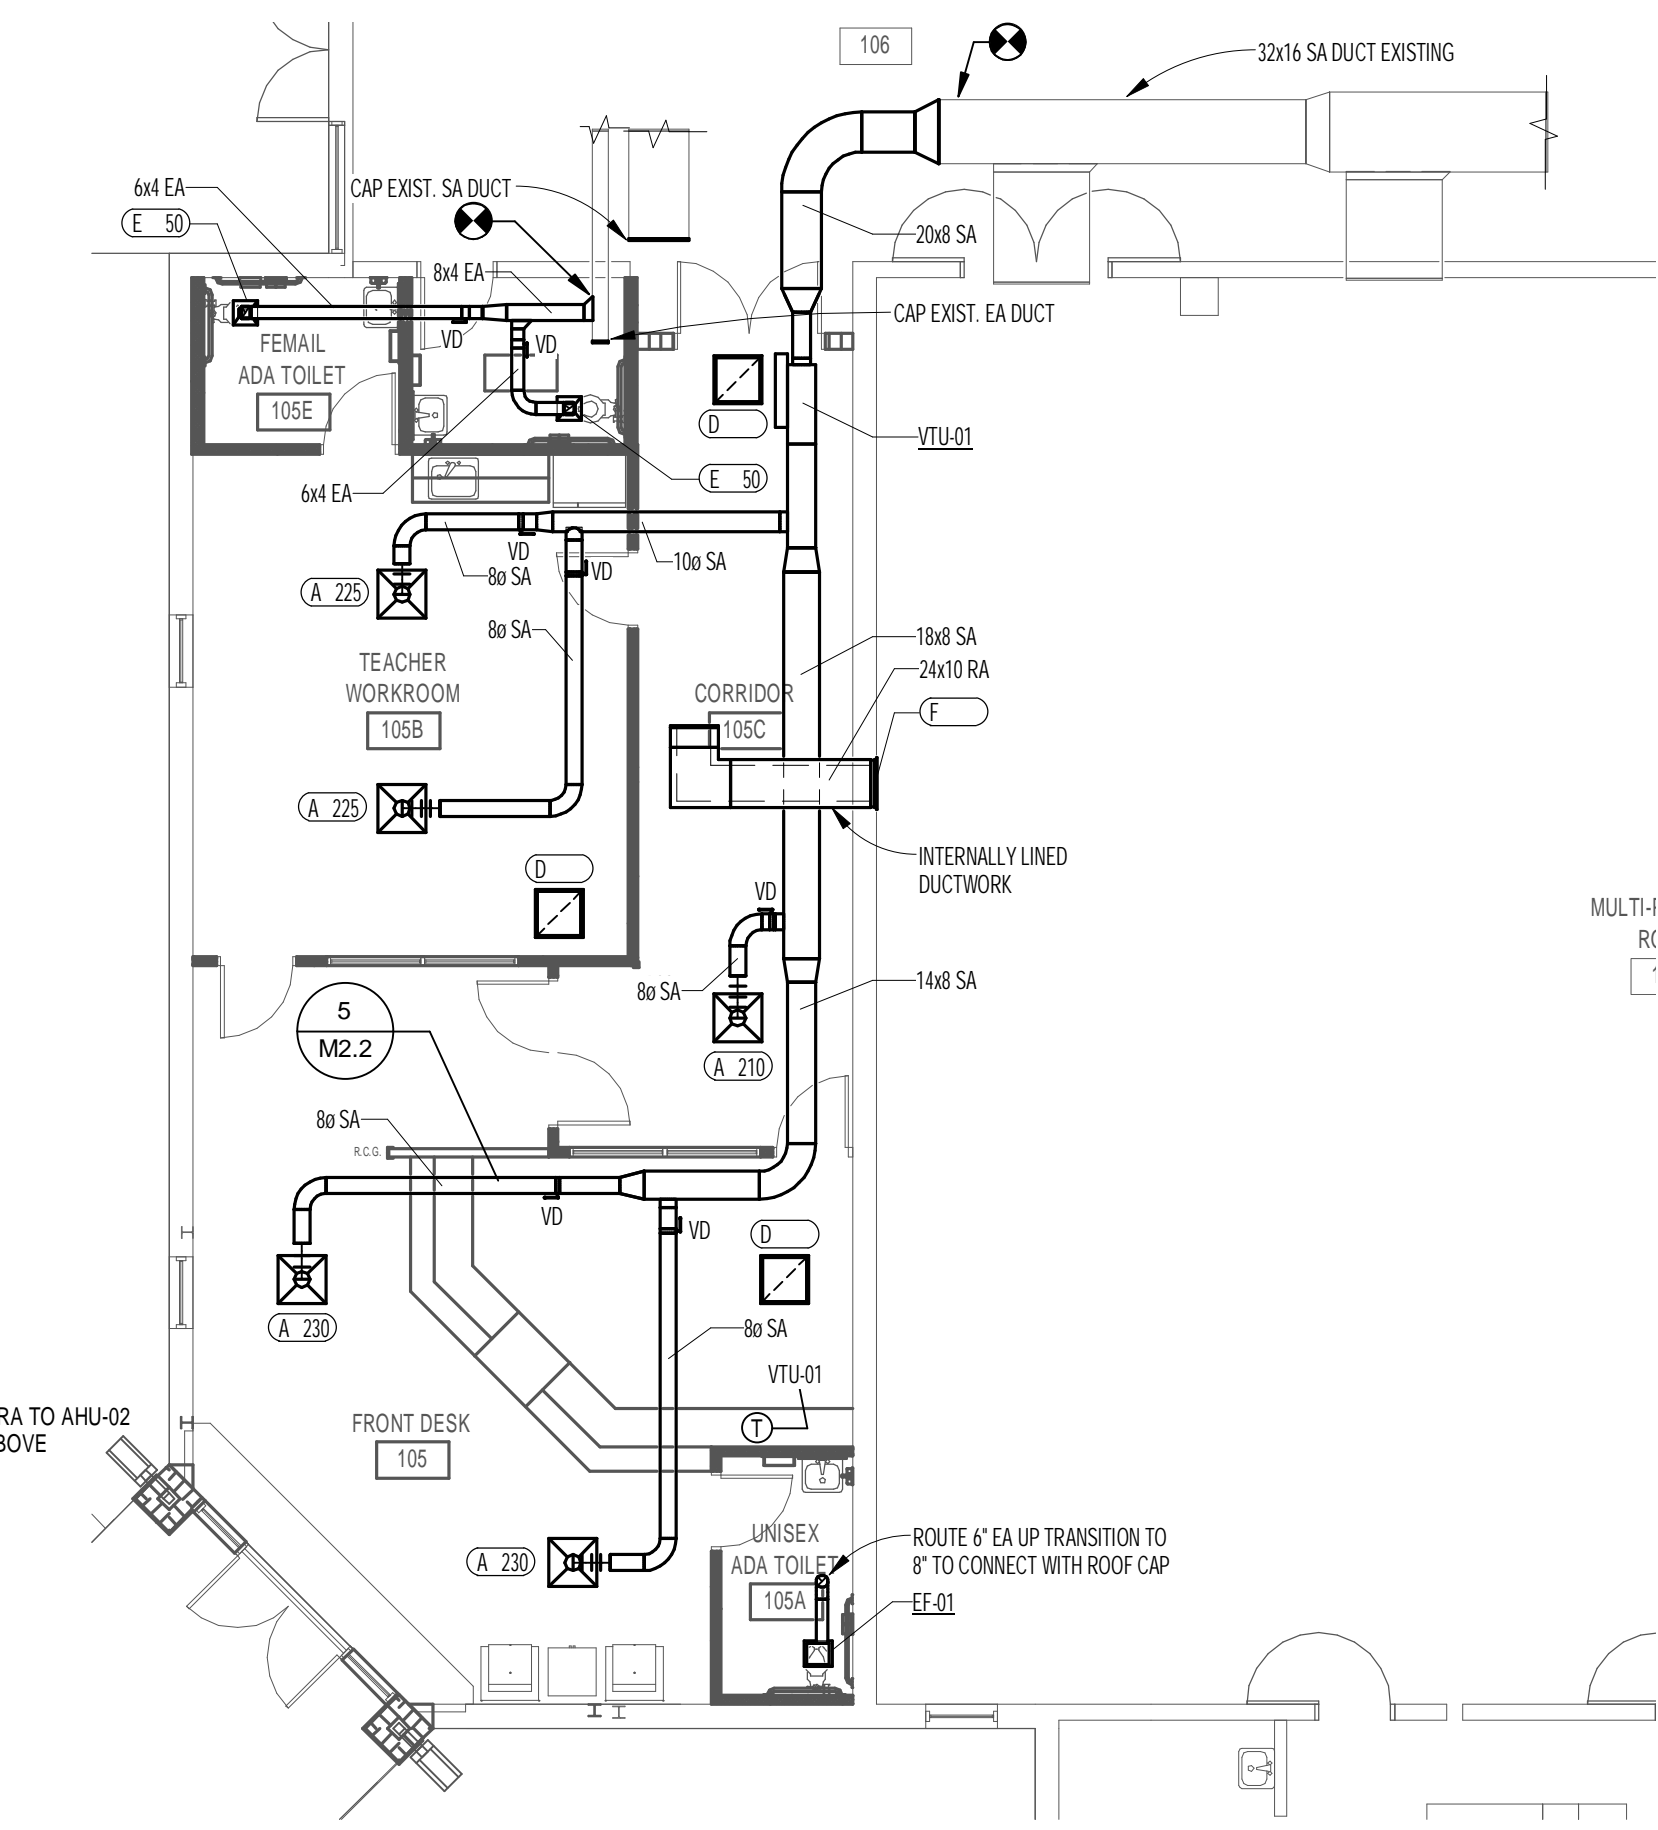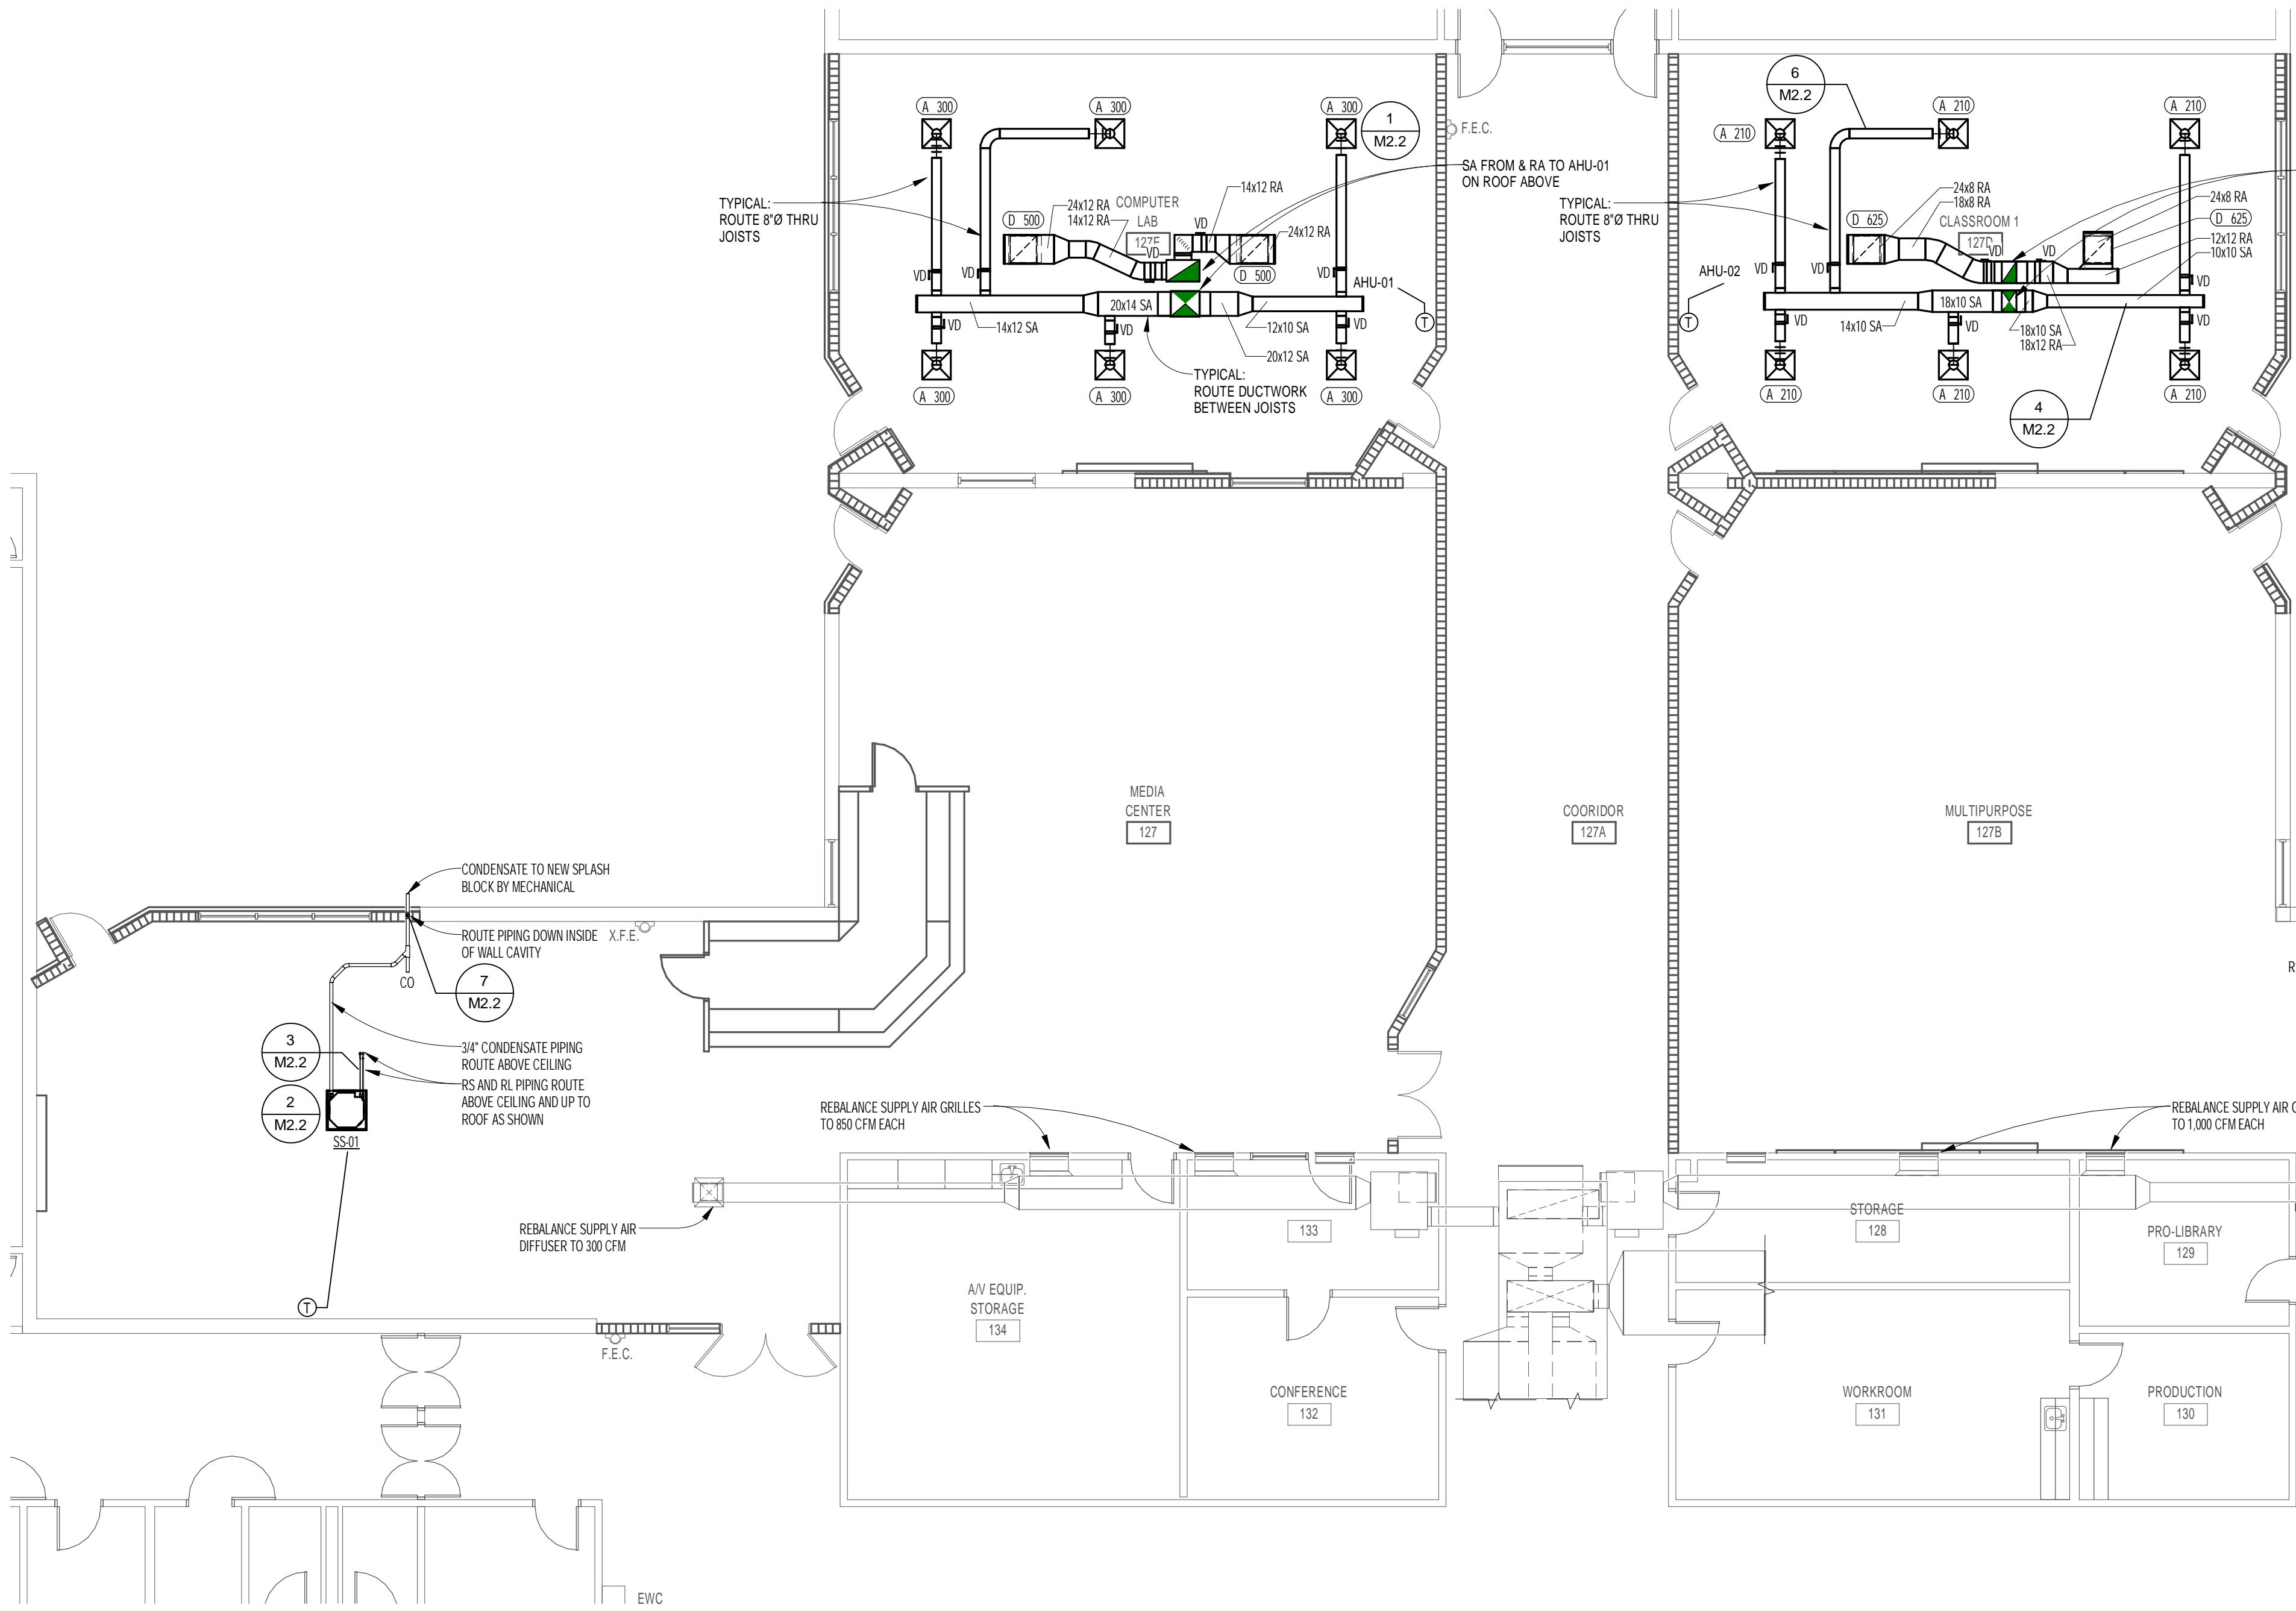

REVISIONS AND UPDATES		
02/14/14	CONSTRUCTION DOCUMENTS FOR BID/PERMIT	
SUNWANNEE COUNTY SCHOOL BOARD SUNWANNEE PRIMARY SCHOOL ADDITIONS AND REMODELING 1625 WALKER AVE., SW LIVE OAK, FLORIDA		
MECHANICAL FLOOR PLAN		
drawn TMM	checked JPM	approved JPM
<input type="checkbox"/> <input type="checkbox"/> <input type="checkbox"/> <input type="checkbox"/>	 AA-C001560	job no. 2012.51  M-1.1
ARCHITECTS RZK, INC. 600 FLORIDA AVENUE SUITE 202 COCOA, FLORIDA 32922 TELEPHONE (321) 631-8039		


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Seal

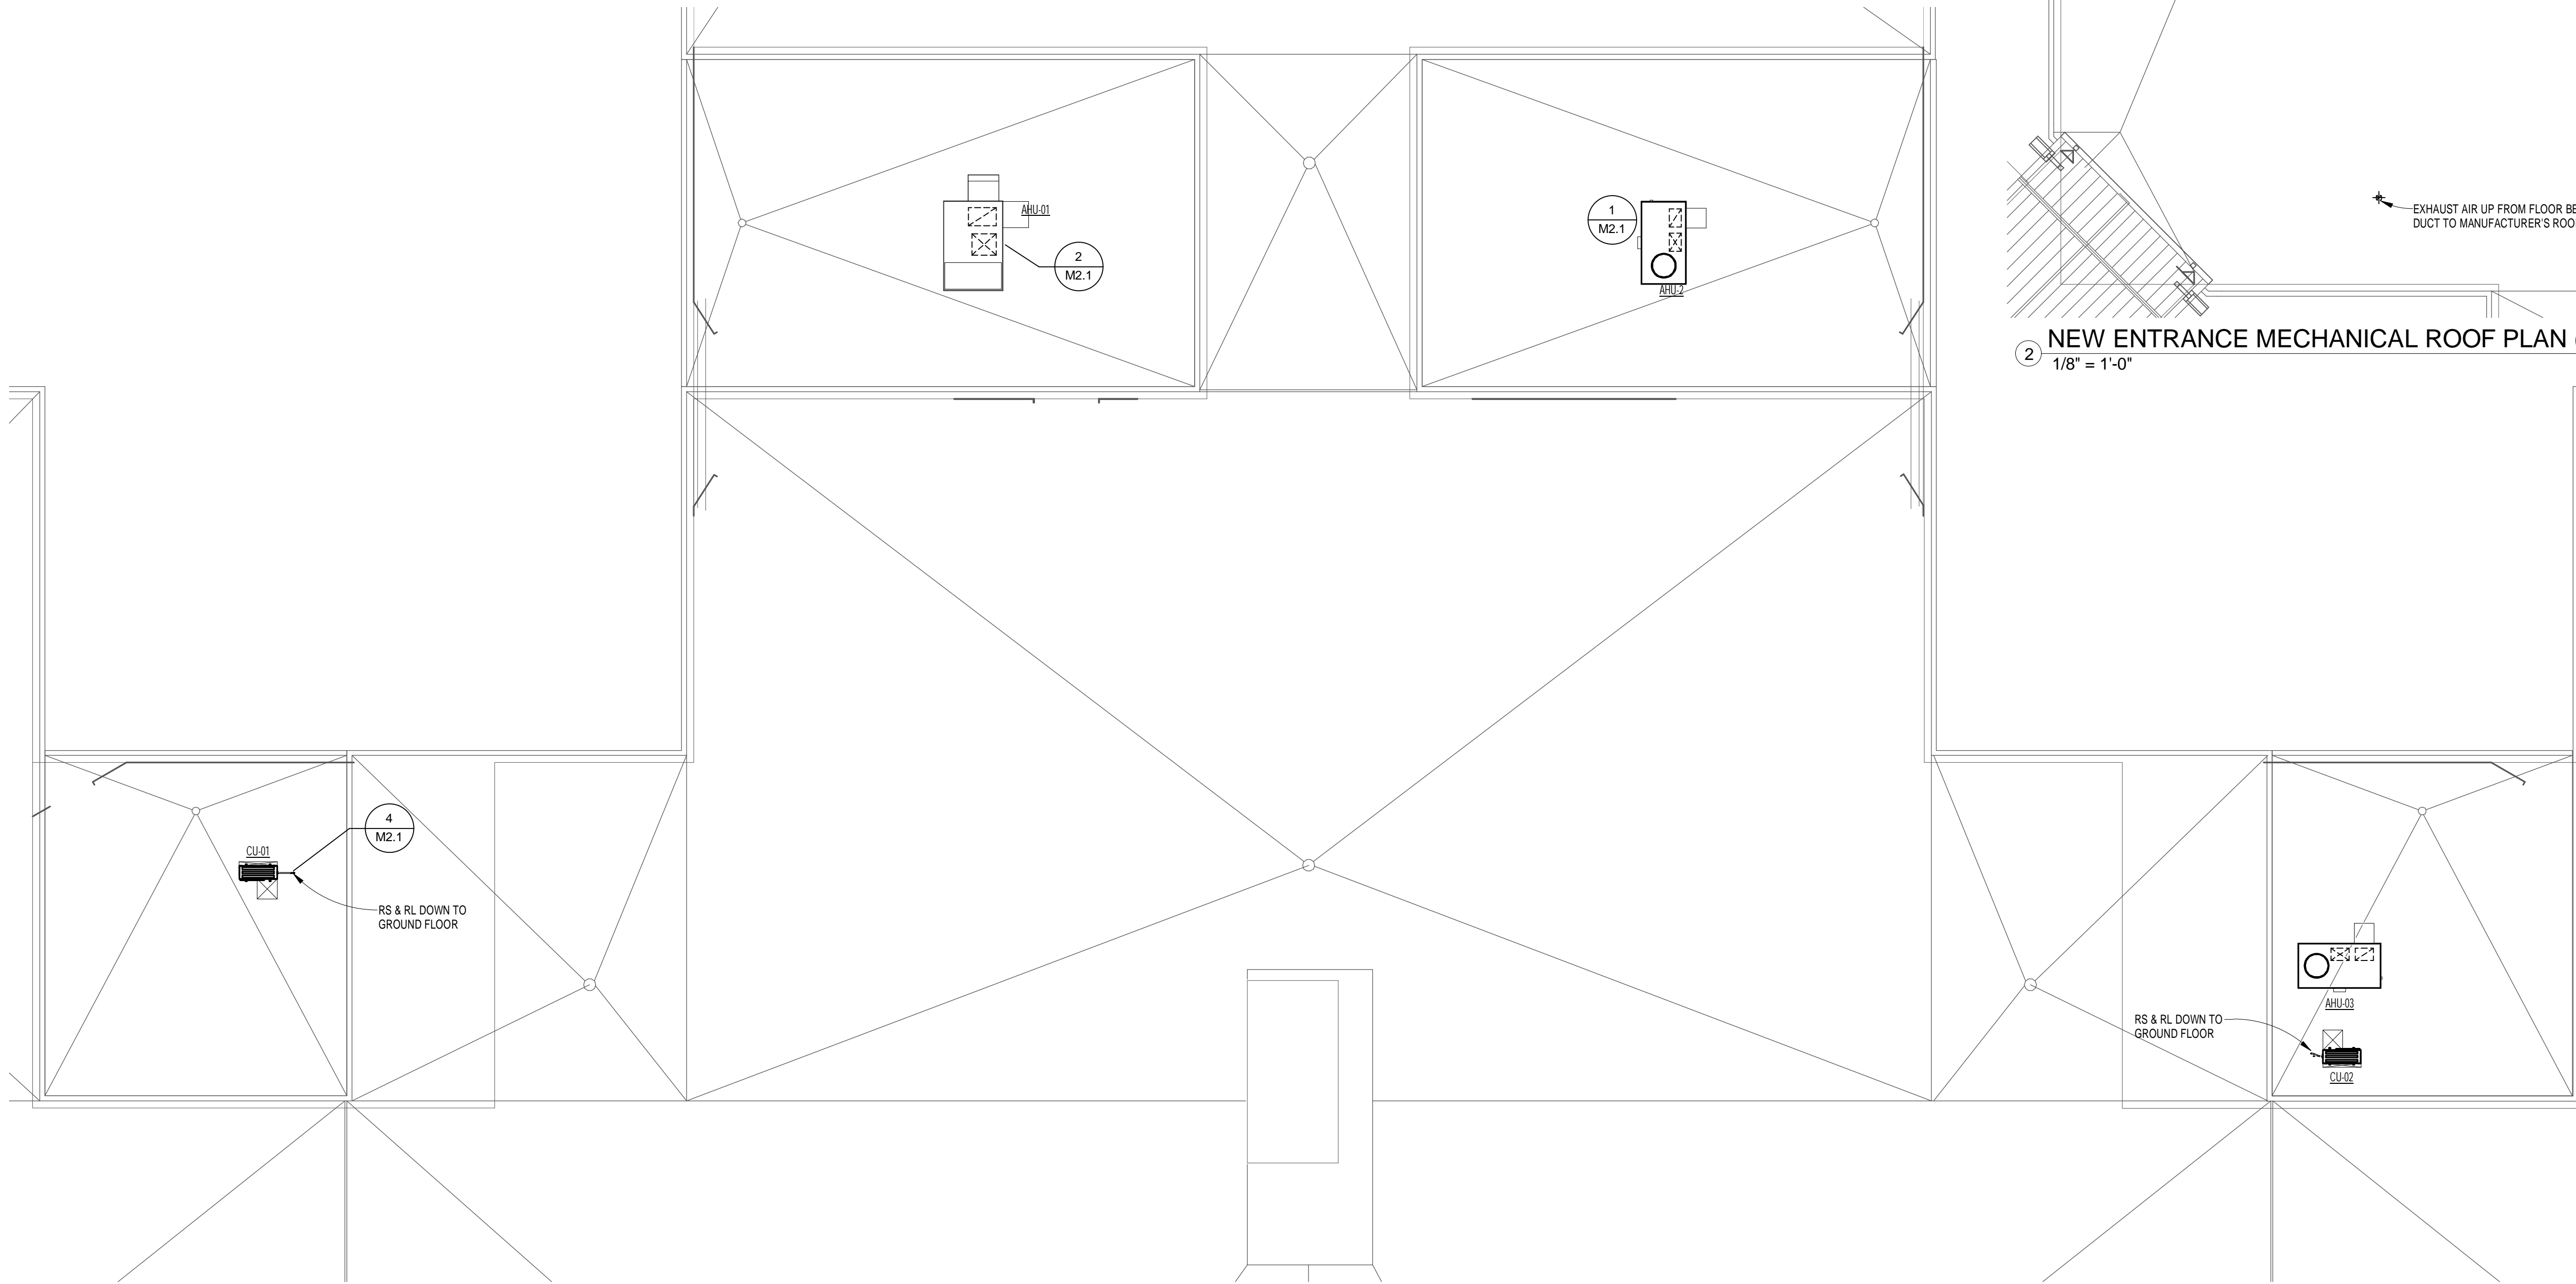

① MECHANICAL ROOF PLAN  
1/8" = 1'-0"

② NEW ENTRANCE MECHANICAL ROOF PLAN (ADD ALTERNATE)  
1/8" = 1'-0"

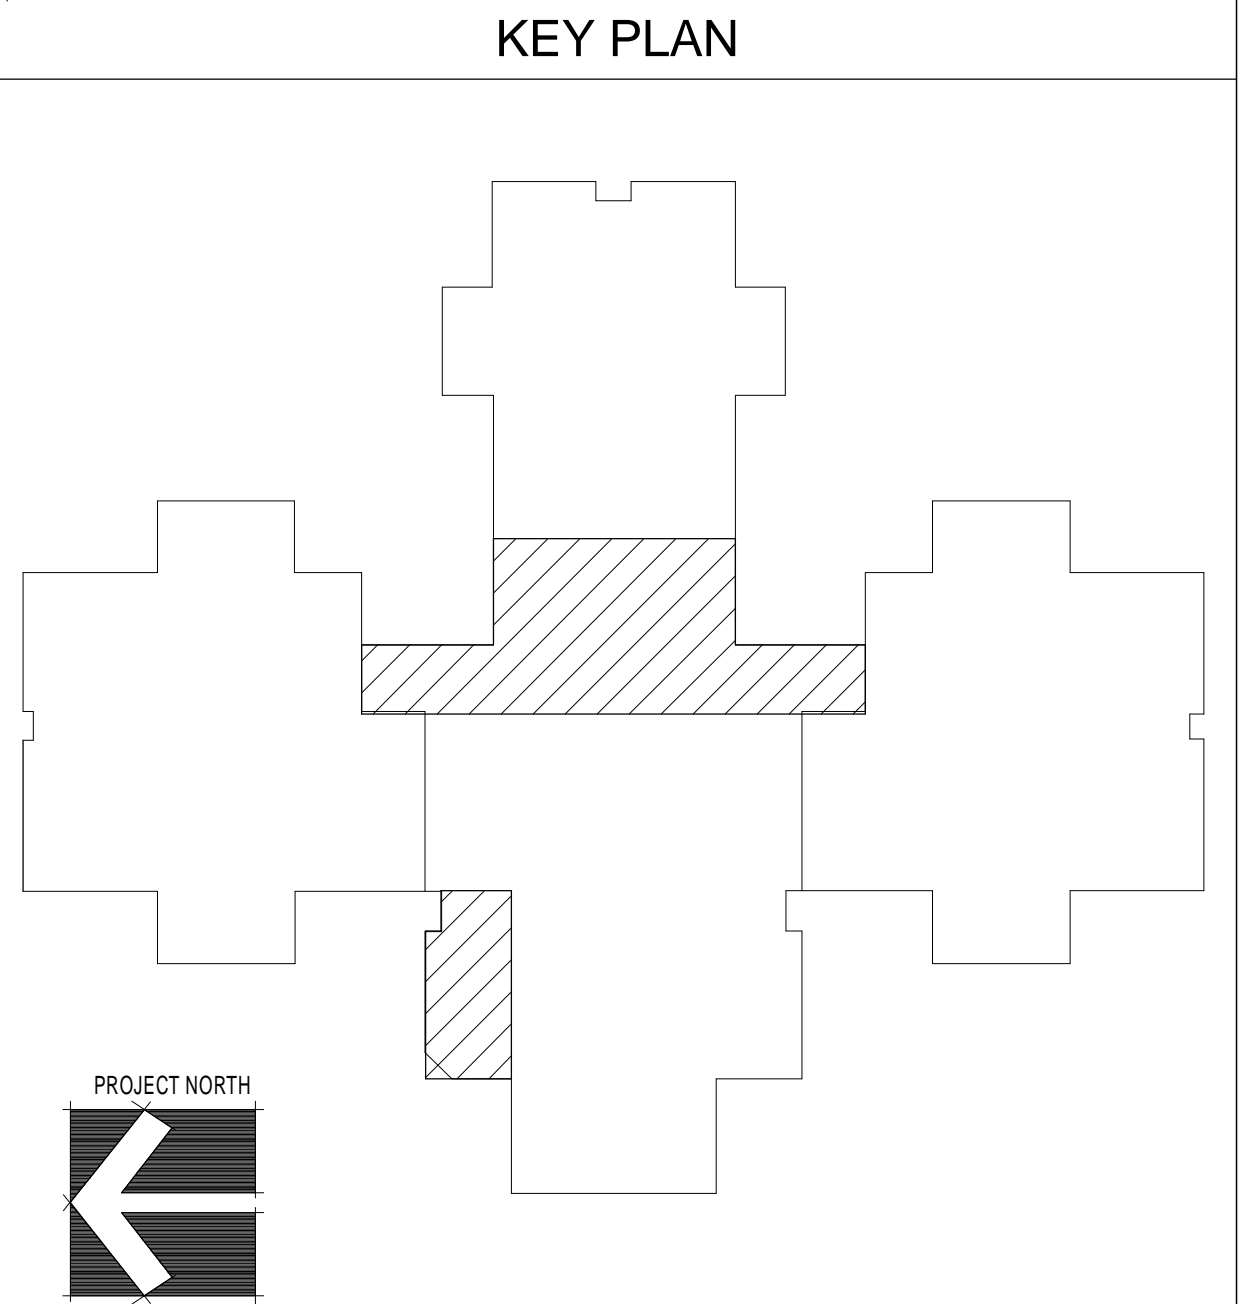

REVISIONS AND UPDATES		
02/14/14	CONSTRUCTION DOCUMENTS FOR BID/PERMIT	

SUWANNEE COUNTY SCHOOL BOARD  
SUWANNEE PRIMARY SCHOOL  
ADDITIONS AND REMODELING  
1625 WALKER AVE., SW      LIVE OAK, FLORIDA

MECHANICAL ROOF PLAN

drawn TMM      checked JPM      approved JPM

AA-0001560


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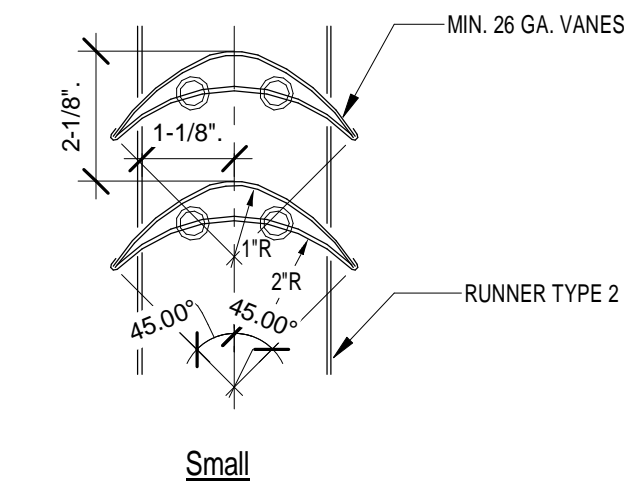
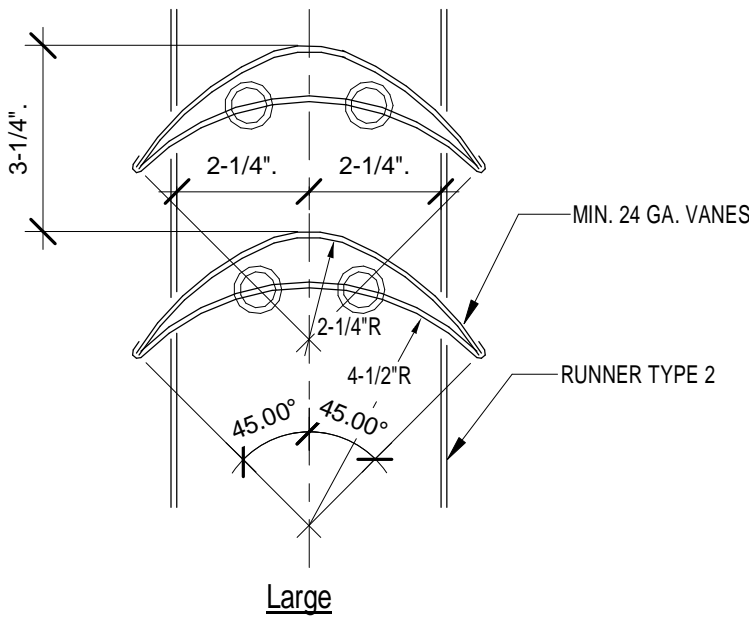
job no. 2012.51  
M-1.2




SINGLE VANE SCHEDULE			
	R (RADIUS)	SP	GAUGE
SMALL	2" (51 mm)	1-1/2" (38 mm)	24 (0.70 mm)
LARGE	4-1/2" (114 mm)	3-1/4" (83 mm)	22 (0.85 mm)




SINGLE VANE

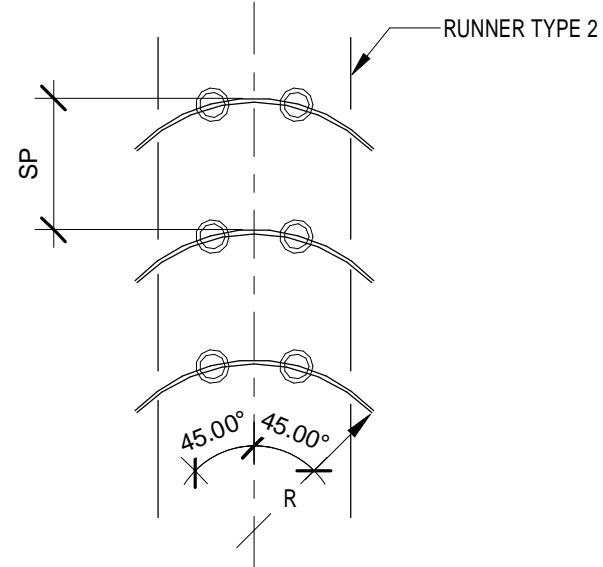



DOUBLE VANE

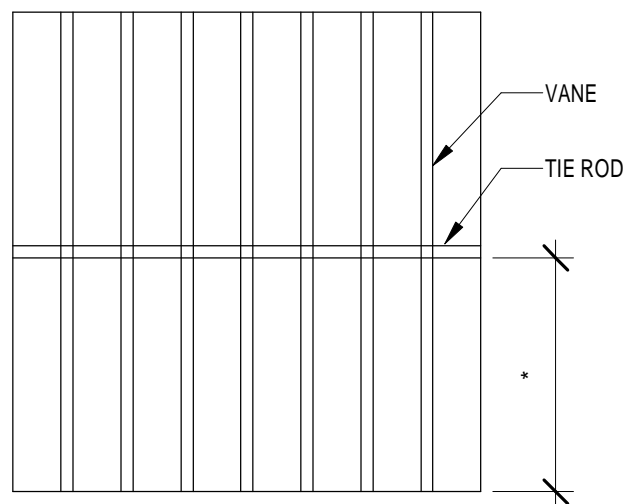

\* MAXIMUM UNSUPPORTED VANE LENGTH  
SMALL SINGLE VANES 6"  
LARGE SINGLE VANES 8"  
SMALL DOUBLE VANE 48"  
LARGE DOUBLE VANE 72"  
  
NOTE:  
INSTALL VANES IN SECTIONS OR USE TIE RODS TO LIMIT THE UNBRACED VANE LENGTH

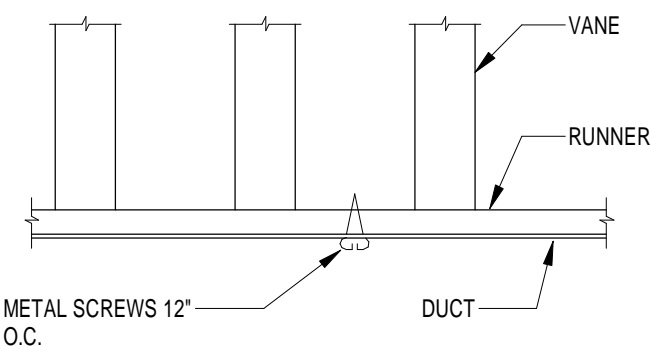


VANE SUPPORT

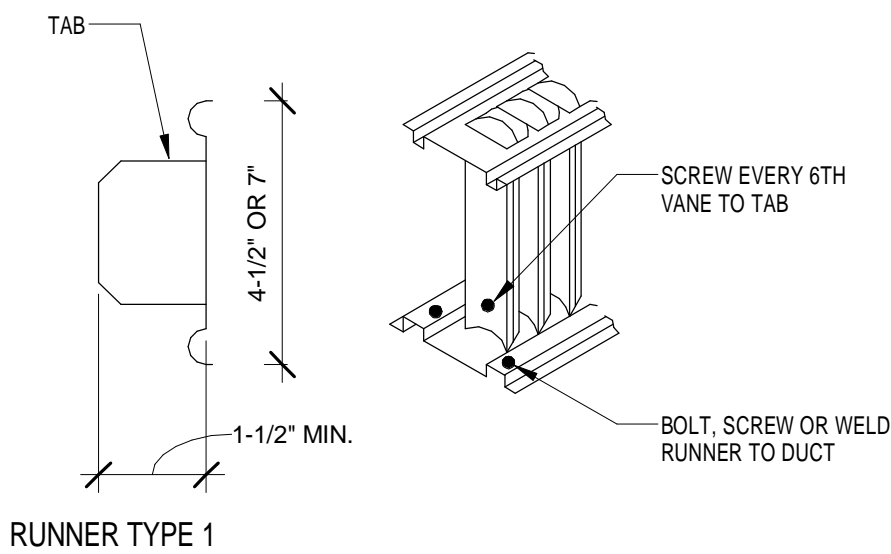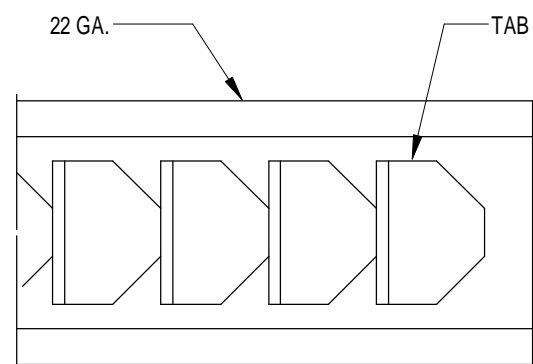

NOTE:  
SEE MECHANICAL SPECIFICATIONS FOR ADDITIONAL INFORMATION.

## TURNING VANES

NTS

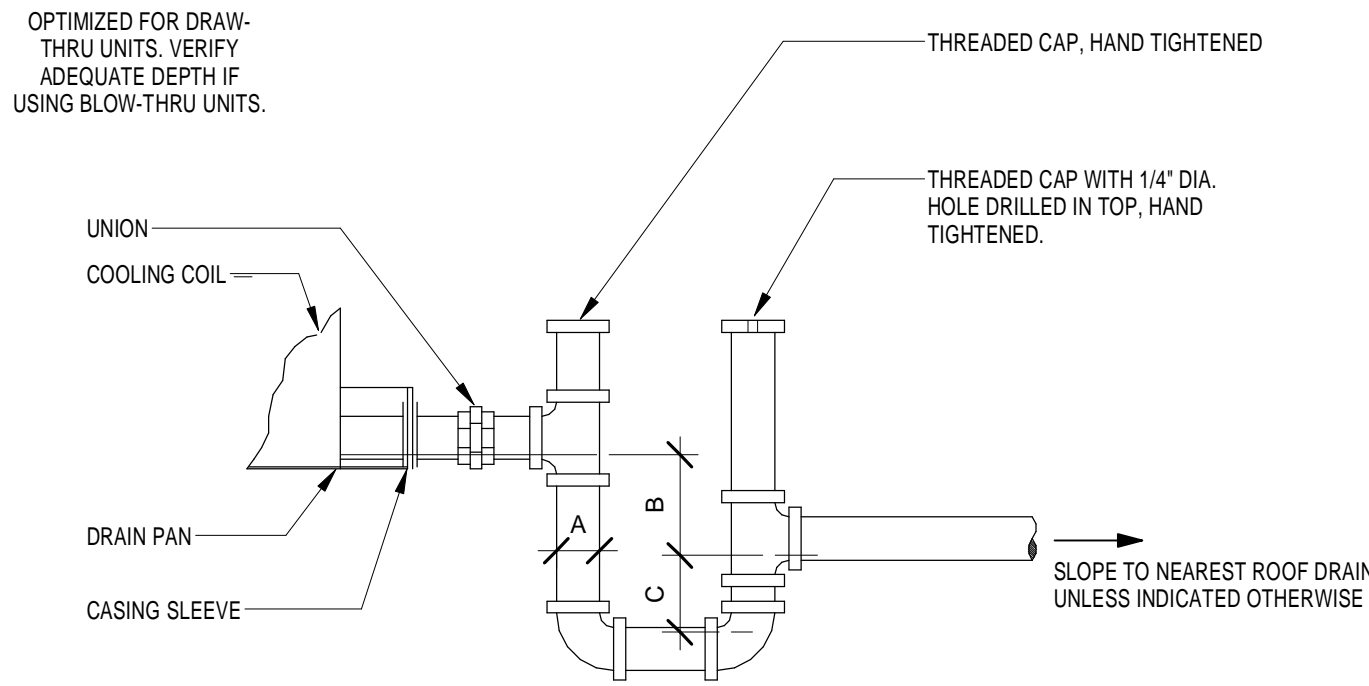


### CONDENSATE DRAIN PIPING DIMENSIONS:

A = FULL SIZE OF UNIT DRAIN CONNECTION  
B > 1-1/2" TIMES FAN SUCTION STATIC PRESSURE  
C > FAN DISCHARGE STATIC PRESSURE PLUS 1/2" INCH

COORDINATE MOUNTING/CURB HEIGHT AS REQUIRED TO PROVIDE PROPER CONDENSATE DRAINAGE.


## AHU CONDENSATE DRAIN TRAP

NTS

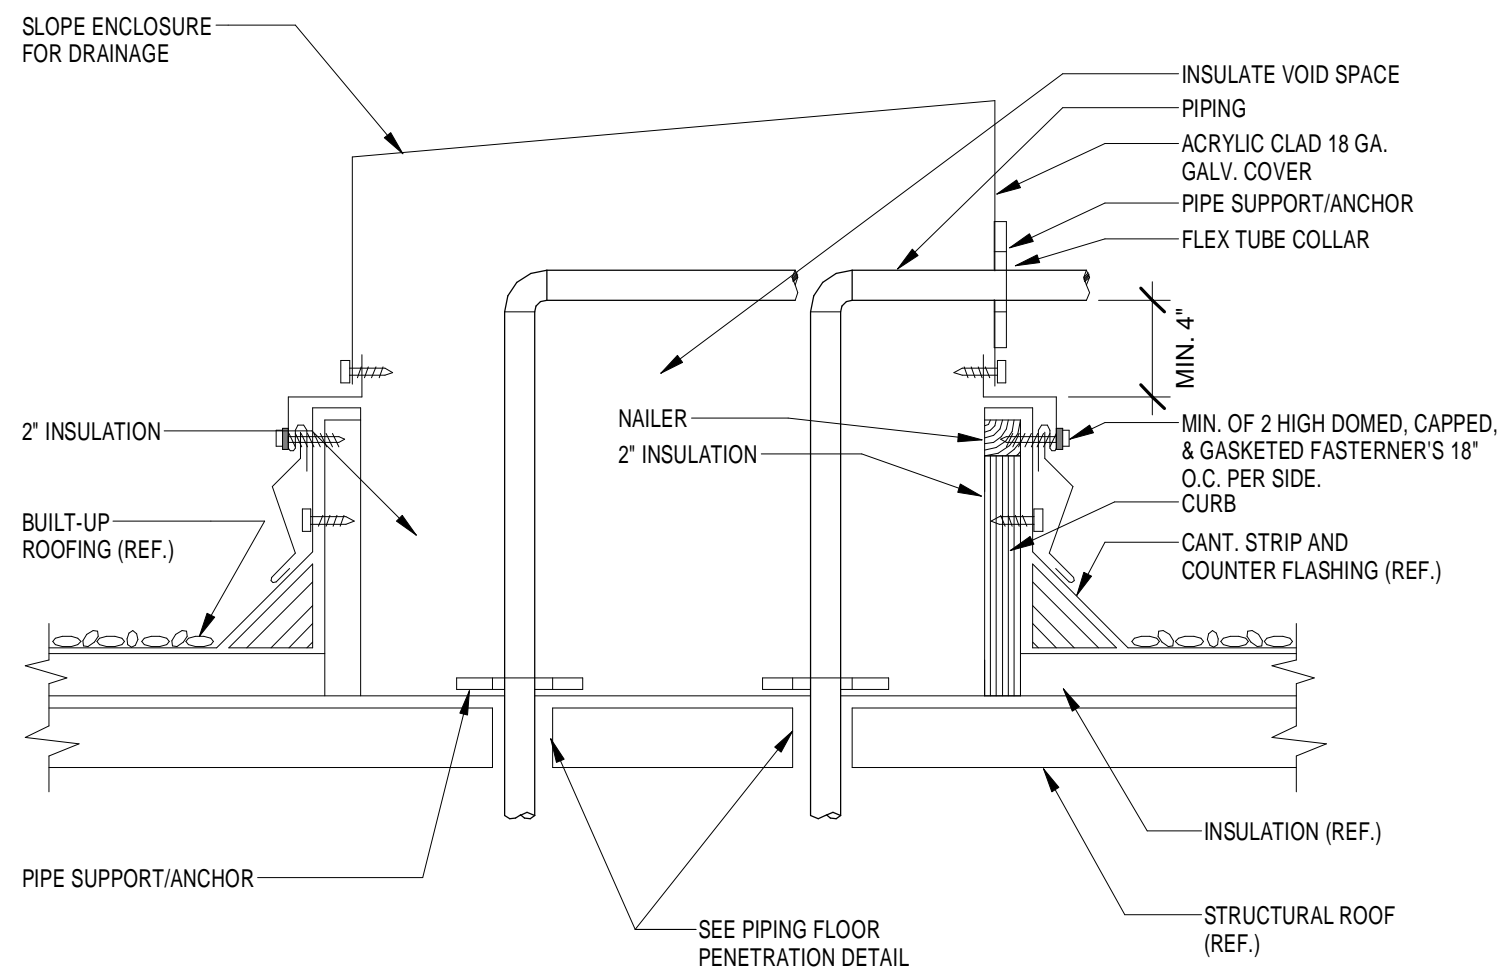


## ROOF PIPING PENETRATION DETAIL

N.T.S.

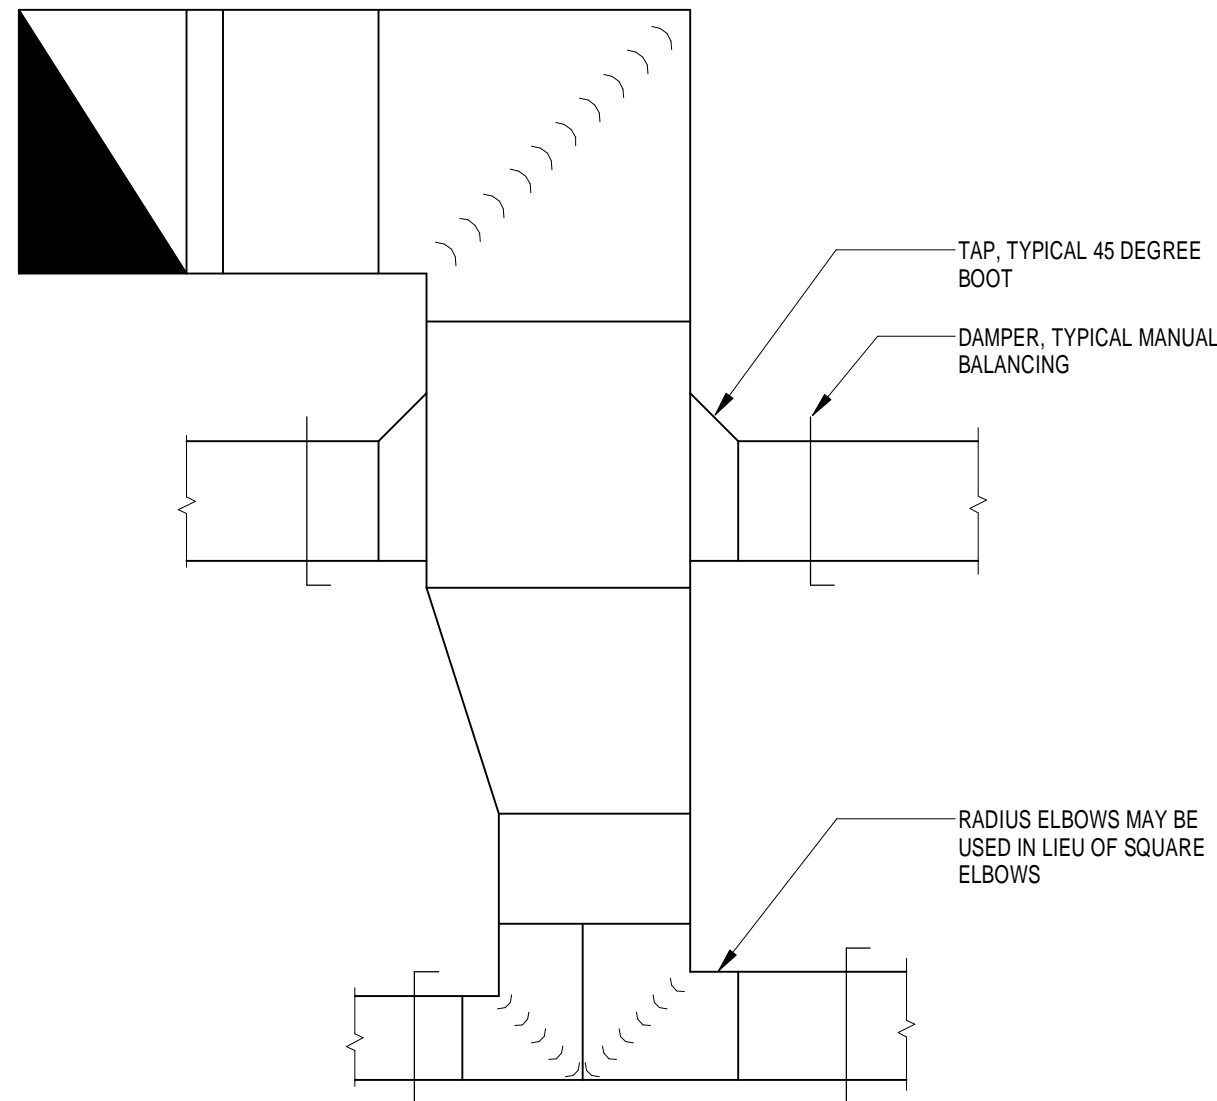

## TYPICAL PRESSURE DUCTWORK


NTS

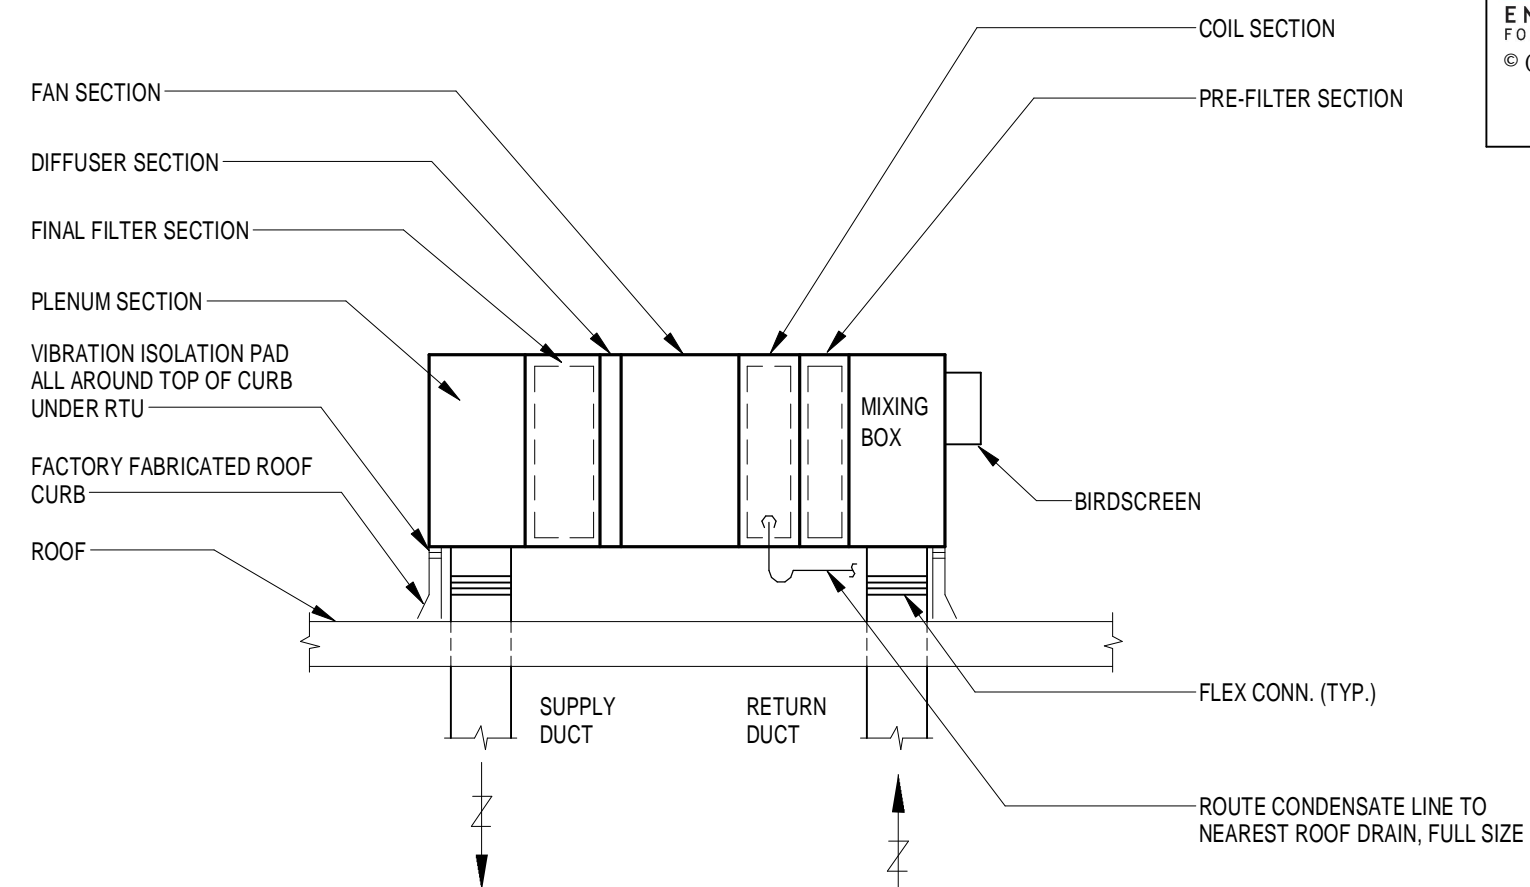

NOTE: ALL ROOF MOUNTED EQUIPMENT MUST ADHERE TO CURRENT HURRICANE CODES REGARDING ROOF TIE-IN AND WIND RESISTANCE.

## ROOFTOP UNIT

NTS

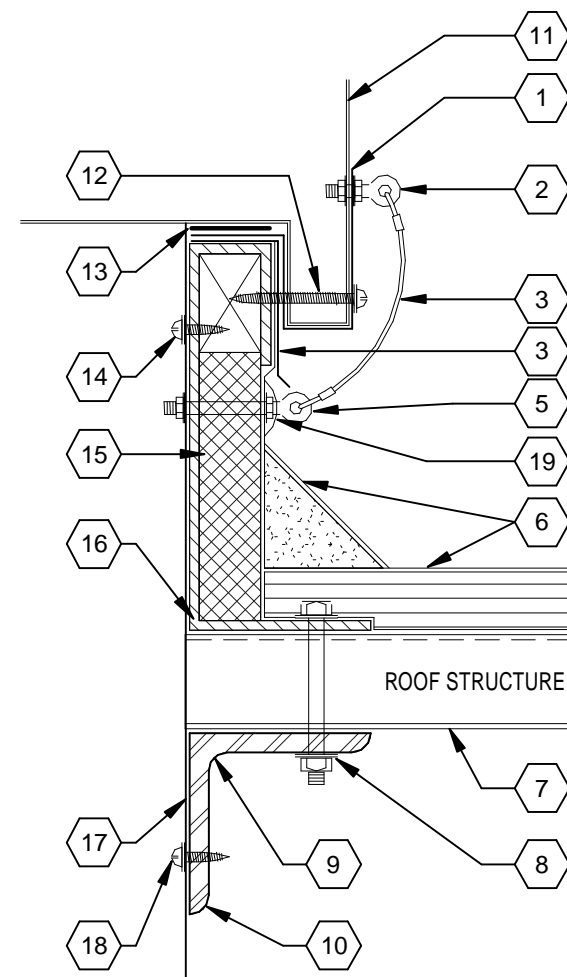

- 2"W x 16 GA. G90 GALV. STEEL ANCHOR STRAP, AT EACH EYEBOLT
- 2" GALV. STEEL PLAIN 3/4" EYEBOLT ASTM A489 RATED, W/ WASHER ON BOTH SIDES AND NUT. (TYP-2) THIS ASSEMBLY TO BE ON EACH SIDE OF EQUIPMENT AND CURB. BOLT TO BE MOUNTED PER MANUF. RECOMMENDATIONS.
- 3/8" BRAIDED GALV. STRAP W/ PLASTIC COATING. INSTALL WITH A MINIMUM OF 6" SWAG
- FLASHING

- 3/4" EYEBOLT TO BE A MINIMUM OF 1" ABOVE ROOFING CANT. SEAL AROUND EYEBOLT WITH ALSAN FLASHING AND FABRIC (COVERING FENDER AND NEOPRENE WASHER). BOLT TO BE FACTORY INSTALLED AND SHIP WITH CURB.
- RIGID INSULATION & CANT. STRIP BY G.C.C.
- 10" x 10" x 1/4" STEEL PLATE
- 1/2" DIA. BOLTS, NUTS & WASHERS, 24" O.C., MIN. (3) PER UNIT SIDE
- ROOFTOP EQUIPMENT FRAMING
- EXTEND CURB SLEEVE DOWN 6" BELOW ROOF STRUCTURAL SUPPORTS
- ROOF-MOUNTED EQUIPMENT
- #12-TEK SCREW THRU STRAP INTO EQUIPMENT BASE RAIL AT 6" O.C.
- GASKET
- #12-TEK SCREW THRU SLEEVE INTO WOOD NAILER 6" O.C.
- PREFAB. INSULATED ROOF CURB
- INSTALL SHIMS AS REQUIRED BELOW CURB TO LEVEL ROOFTOP EQUIPMENT
- 14 GA. CURB SLEEVE EXTEND 10" BELOW ROOF STRUCTURE. SLEEVE AND CURB TO BE ONE PIECE CONSTRUCTION.
- #12-TEK SCREW THRU SLEEVE INTO STRUCTURAL FRAMING 6" O.C.
- EYEBOLT TO BE MINIMUM OF 1" OFF OF CURB FACE FOR SEALING.

### NOTES:

EQUIPMENT SHALL BE ANCHORED TO WITHSTAND MAX. WIND LOAD REQUIRED BY CODE. EIGHT TOTAL TIE DOWNS SHALL BE REQUIRED. TWO ON EACH CORNER OF THE FAN AND CURB. ALL HARDWARE TO BE HOT DIP GALVANIZED. THIS DETAIL APPLIES TO ALL ROOF MOUNTED EQUIPMENT.

## ROOF CURB ANCHORING & EQUIPMENT TIE-DOWN

N.T.S.


## REVISIONS AND UPDATES

02/14/14 CONSTRUCTION DOCUMENTS FOR BID/PERMIT

SUWANNEE COUNTY SCHOOL BOARD  
SUWANNEE PRIMARY SCHOOL  
ADDITIONS AND REMODELING  
1625 WALKER AVE., SW LIVE OAK, FLORIDA

## MECHANICAL DETAILS


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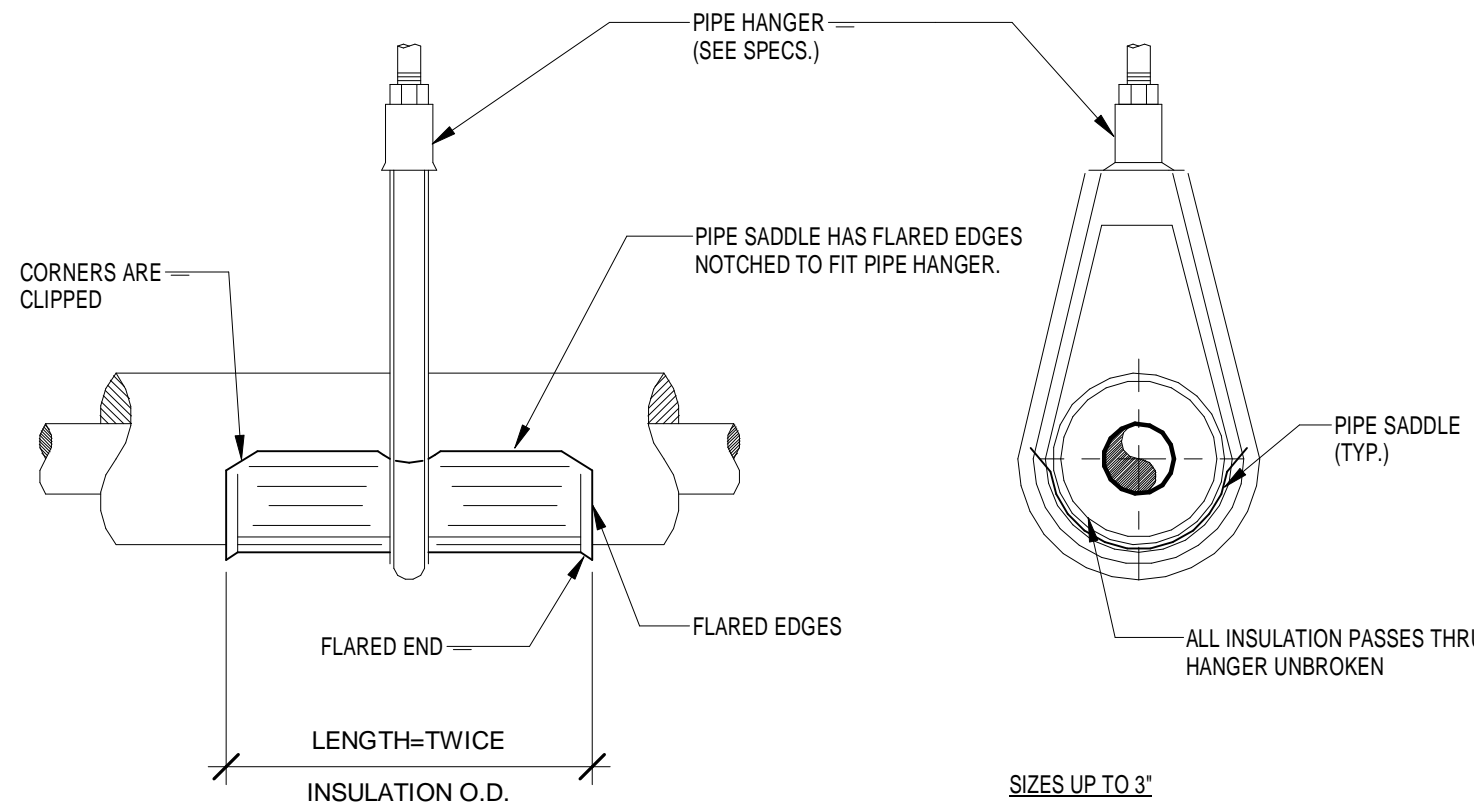
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600 FLORIDA AVENUE SUITE 202 COCOA, FLORIDA 32922 TELEPHONE (321) 631-8039

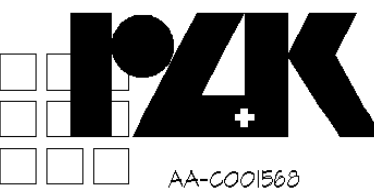job no. 2012.51


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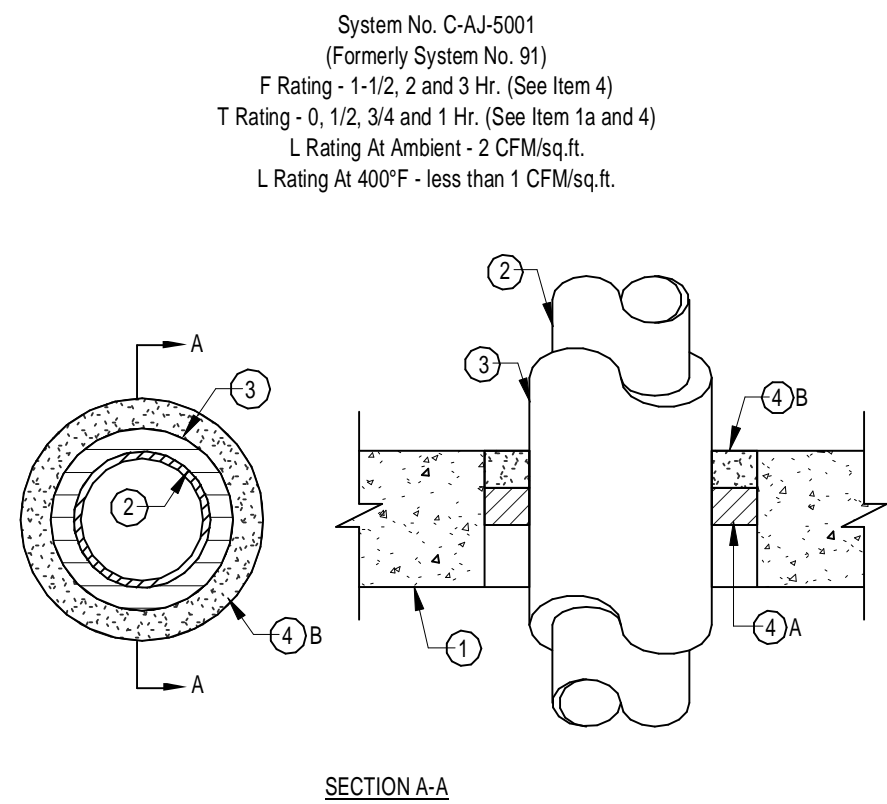
6 STEEL BEAM CLAMP WITH EYE NUT DETAIL  
1" = 1'-0"



3 INSULATED PIPE HANGER DETAIL  
N.T.S.

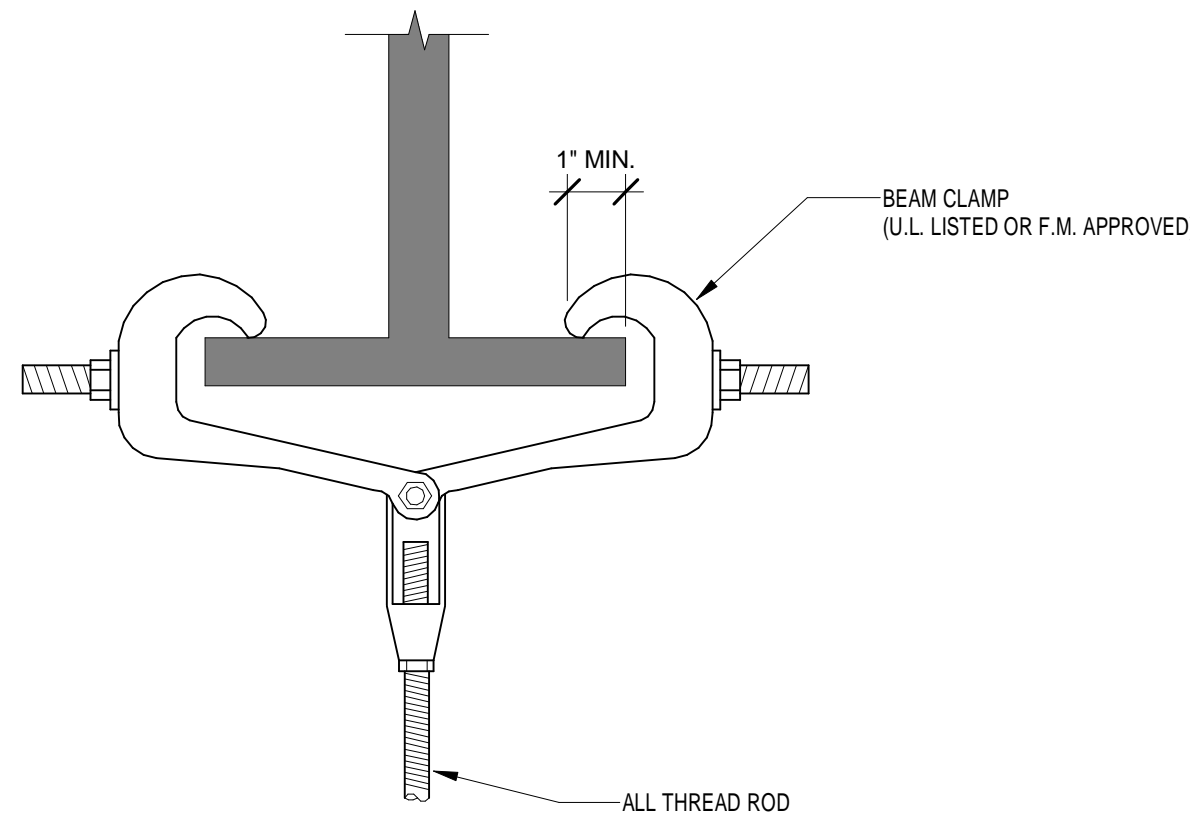

1 DIFFUSER MOUNTING  
N.T.S.

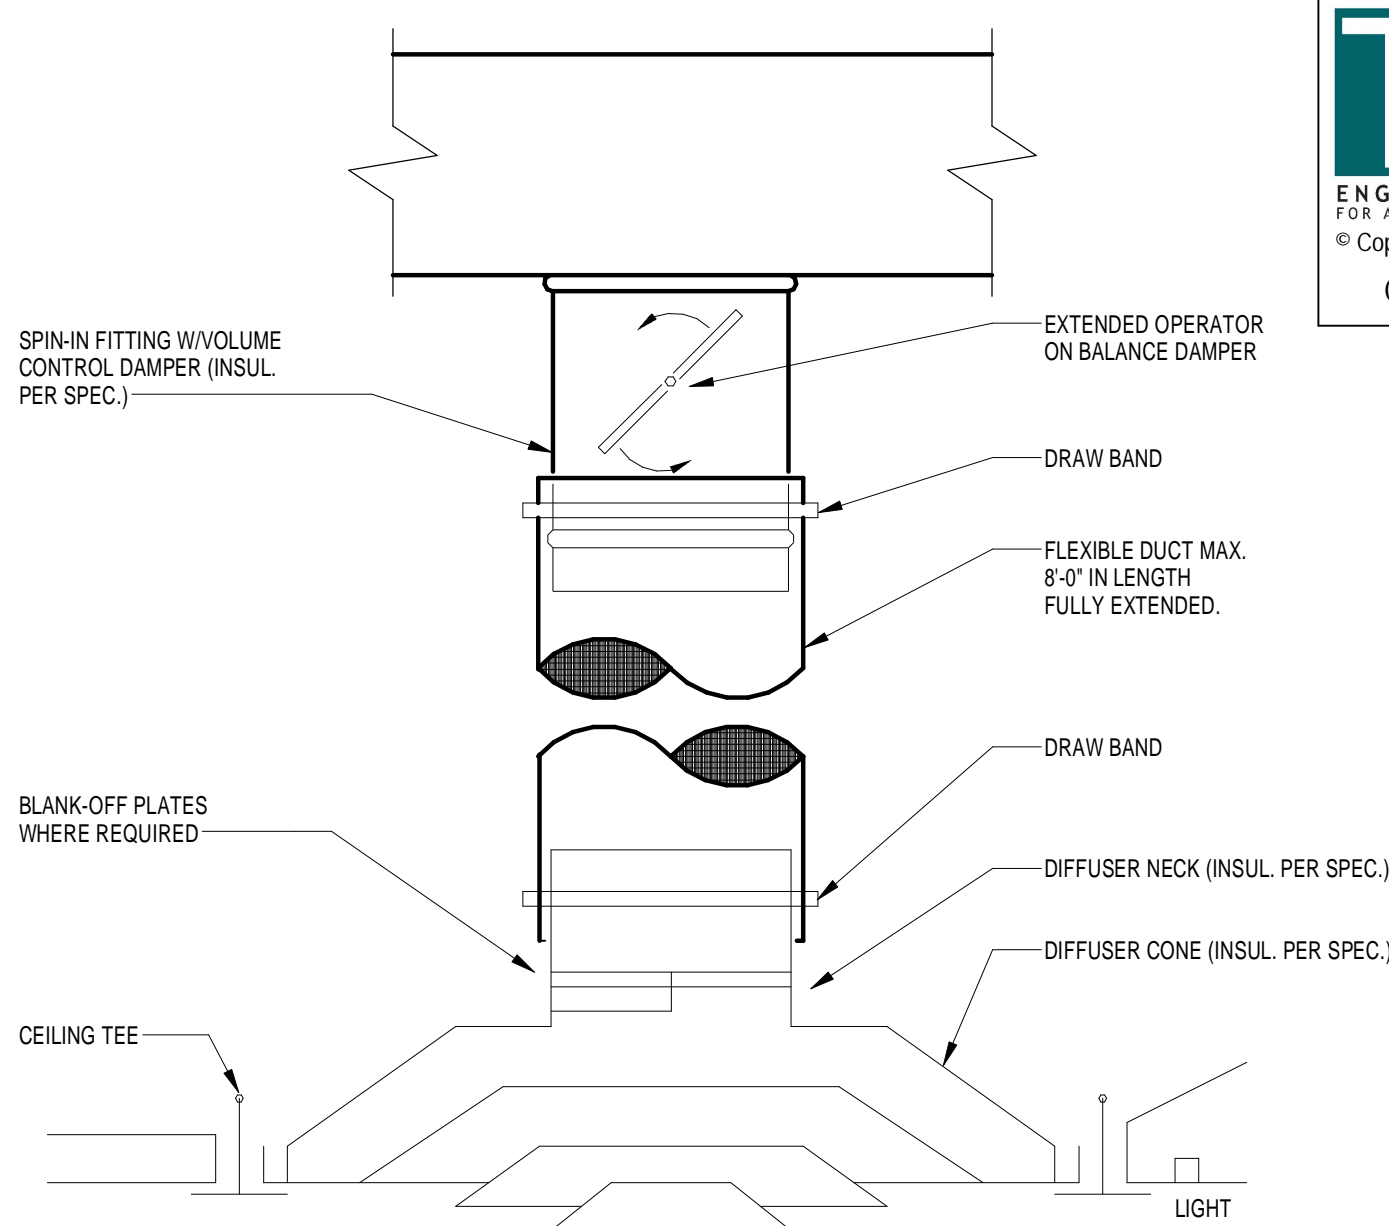

1. Floor or Wall assembly - Min. 2- 1/2" thick reinforced lightweight or normal weight (100-150) pcf concrete. Wall may also be constructed of any UL Classified Concrete Blocks\*. Max. diameter of opening is 18". See Concrete Blocks (CAZT) category in the Fire Resistance Directory for names of manufacturers.

1A. Steel Sleeve - Optional, not shown) - Nom. 10" (or smaller) Schedule 10 (or heavier) steel sleeve cast or grouted into floor or wall assembly. Sleeve may extend a max. of 2" above top of floor or beyond either surface of wall. T Rating is 0 Hr. when sleeve is used.

2. Through Penetrants - Nom. 4" dia. (or smaller) type L (or heavier) copper pipe, nom. 12" dia. (or smaller) service weight (or heavier) cast iron soil pipe, nom. 12" dia. (or smaller) class 50 (or heavier) ductile iron pressure pipe or nom. 12" dia. (or smaller) Schedule 10 (or heavier) steel pipe centered in the opening and rigidly supported on both sides of the floor or wall assembly.

3. Pipe-Covering\* - Nom. 1/2 to 2" thick hollow cylindrical heavy density (min. 3.5 pcf) glass fiber units jacketed on the outside with an all service jacket. Longitudinal joints sealed with metal fasteners or factory-applied self-sealing lap tape. Transverse joints secured with metal fasteners or with butt strip tape supplied with the product.  
See pipe and equipment covering - Materials\*(BRGU) category in Building Materials Directory for names of manufacturers. Any pipe covering material meeting the above specifications and bearing the UL Classification working with a Flame Spread index of 25 or less and a Smoke Developed Index of 50 or less must be used.

4. Firestop System - The details of the firestop system shall be as follows:


A. Packing Material - Nom. 1" thickness of firmly packed mineral wool batt insulation used as a permanent form, packing material to be recessed from top surface of floor or above or from both surfaces of as required to accommodate the required thickness of caulk, fill material (item b).

B. Fill, Void or Cavity Material\* - Caulk - Applied to fill the annular space flush with top surface of floor or sleeve or flush with both surfaces of wall. When nom. pipe covering thickness is 2", min. thickness of caulk fill material is 2". When nom. pipe covering thickness is 1-1/2" or less, min. thickness of caulk fill material is 1". The hourly F and T Ratings of the firestop system are dependent upon the thickness of the floor or wall, the size of pipe, the thickness of pipe covering material and the size of the annular space (between the pipe covering material and the edge of the circular through opening), as shown in the following table:


Min. Floor Or Wall Thickness, In.	Max. Pipe Dia.	Nom. Pipe Covering Thickness, In.	Annular Space, In.	F Rating, Hr.	T Rating, Hr.
2-1/2	4	1 OR 1-1/2	1/2 TO 3-3/8	2	1
4-1/2	4	2	1/4 TO 3-5/8	2	1-1/2
2-1/2	12	1	1/2 TO 1-1/2	2	1/2
4-1/2	12	1	1/2 TO 2-3/8	3	1
2-1/2	12	1/2	1/2 TO 2-3/8	2	0

Minnesota Mining and Manufacturing Co. - Cp 25WB+.  
\*Bearing the UL Classification Marking

7 PIPE THROUGH CONCRETE WALL DETAIL  
12" = 1'-0"

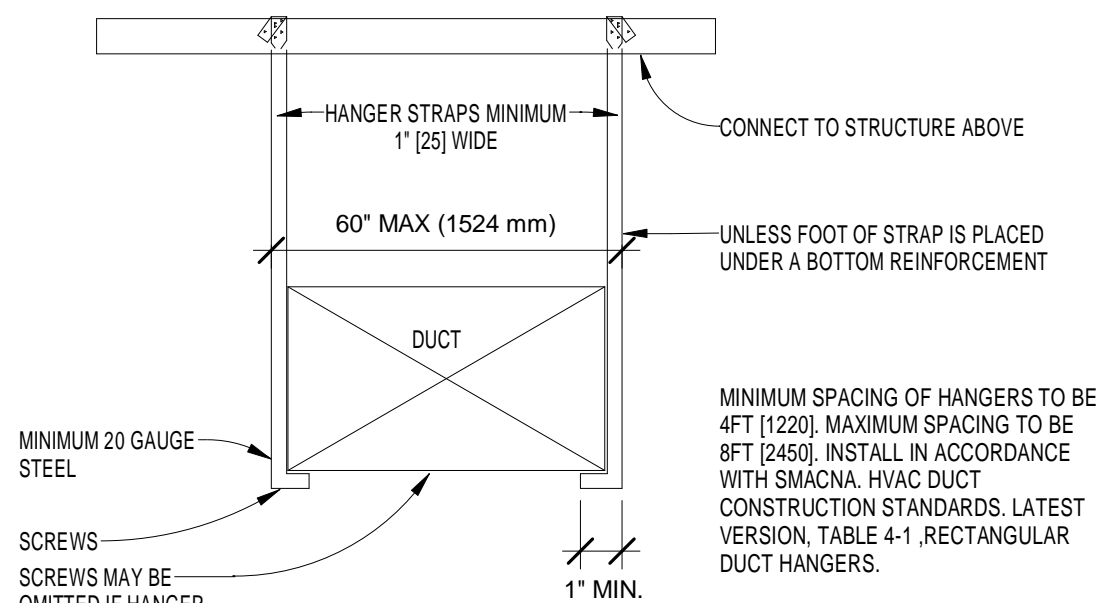


4 DUCT SUPPORT DETAIL  
N.T.S.

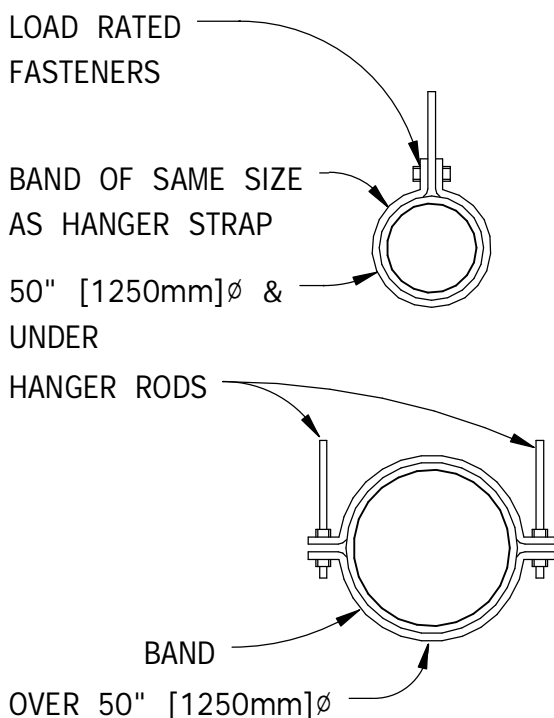

NOTE:  
TABULATED DATA FROM SMACNA  
ALLOWS FOR DUCT REINFORCING  
AND INSULATION, BUT NO  
EXTERNAL LOAD.

HANGER STRAPS OR RODS				
MAX. DUCT, Ø IN. [mm]	QUANTITY/SIZE IN. [mm]	MAX. LOAD LBS. [kg]	MAX. SPACING IN. [mm]	
26 [650]	ONE 1 [25] x 22 GA STRAP	260 [119]	144 [3600]	
36 [900]	ONE 1 [25] x 18 GA STRAP	420 [190]	144 [3600]	
50 [1250]	ONE 1 [25] x 16 GA STRAP	700 [317]	144 [3600]	
60 [1500]	TWO 3/8 [10] Ø. RODS	1320 [598]	144 [3600]	
84 [2100]	TWO 1/2 [13] Ø RODS	2500 [1133]	144 [3600]	

5 ROUND DUCT HANGERS DETAIL  
1/2" = 1'-0"

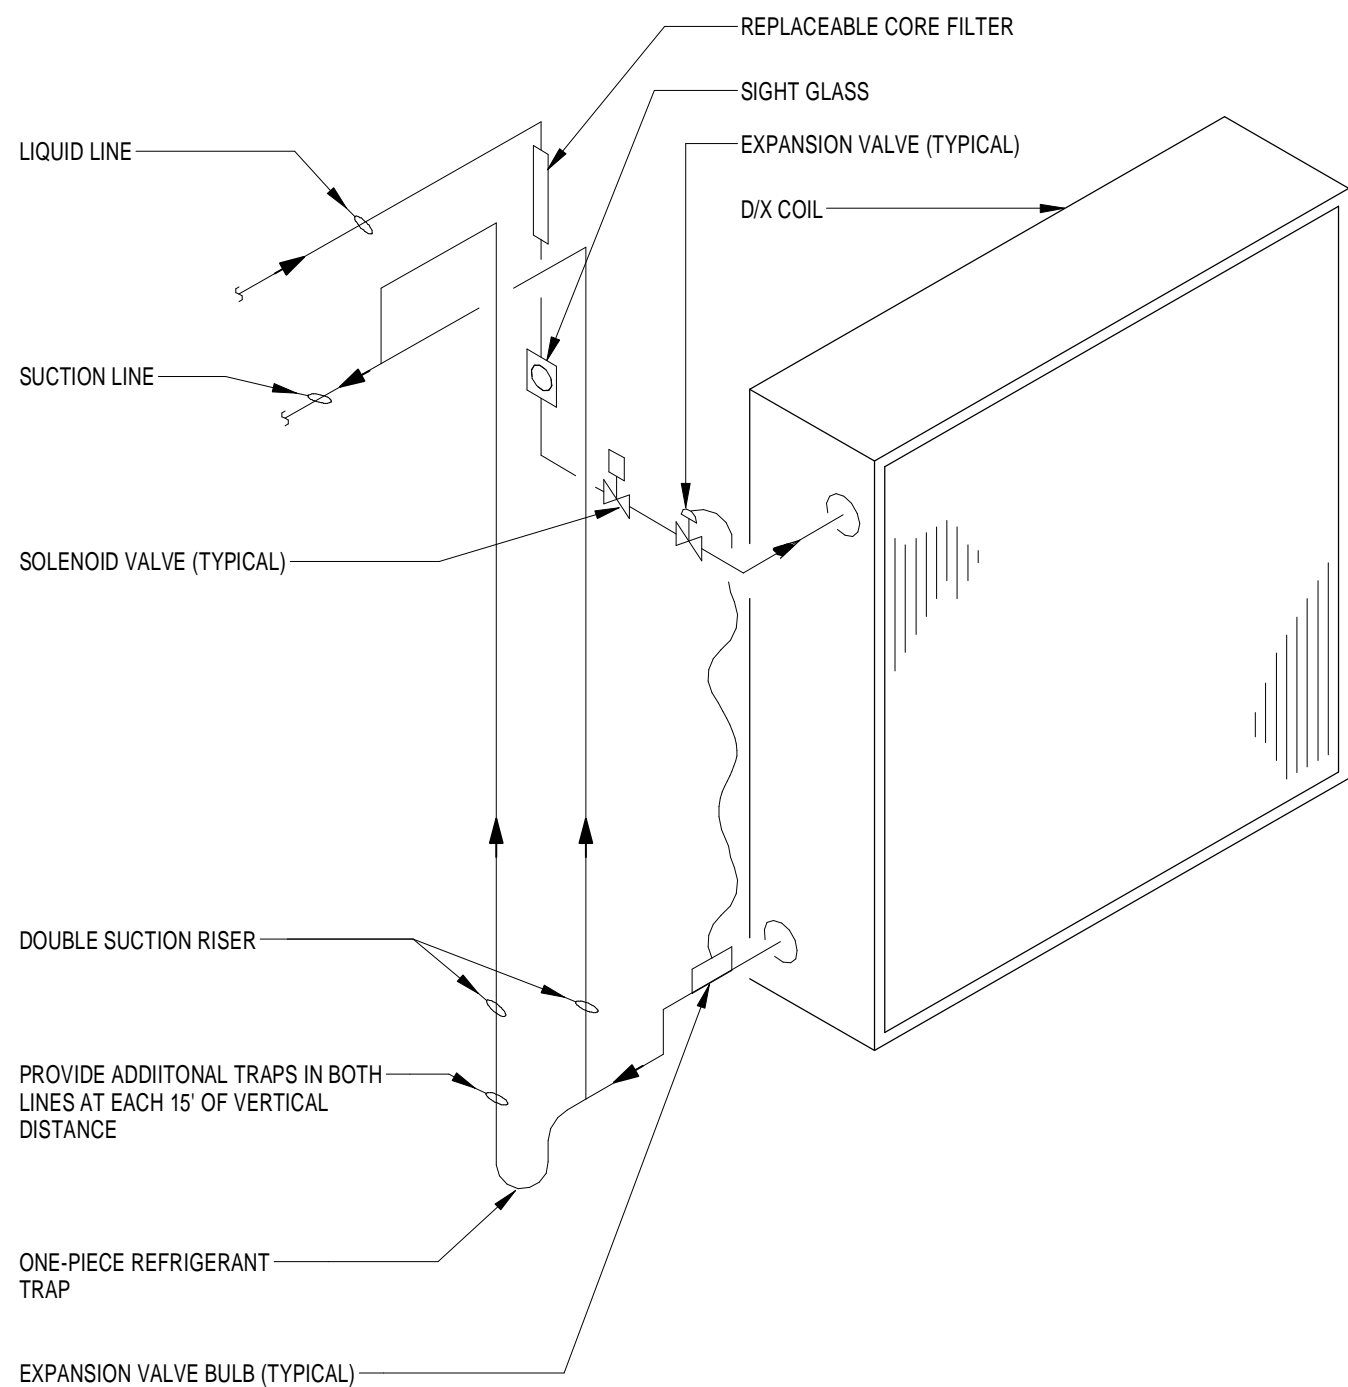

2 D/X COIL DOUBLE-SUCTION PIPING DIAGRAM  
N.T.S.


## REVISIONS AND UPDATES

02/14/14 CONSTRUCTION DOCUMENTS FOR BID/PERMIT

SUWANNEE COUNTY SCHOOL BOARD  
SUWANNEE PRIMARY SCHOOL  
ADDITIONS AND REMODELING  
1625 WALKER AVE., SW LIVE OAK, FLORIDA

## MECHANICAL DETAILS

drawn Author checked JPM approved JPM

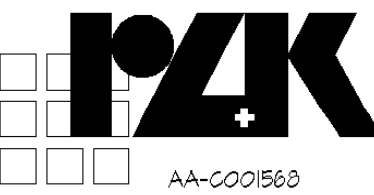

AA-0001503

ARCHITECTS RZK, INC.  
600 FLORIDA AVENUE SUITE 202 COCOA, FLORIDA 32922 TELEPHONE (321) 631-8039

job no. 2012.51

M-2.2

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PACKAGED AIR CONDITIONER (AIR COOLED)																					
PLAN MARK	SERVING	SELECTION BASED ON		REFRIGERANT TYPE	MINIMUM EFFICIENCY (EER)	FAN DATA				COOLING COIL DATA					HEAT KW / STEPS	AMBIENT TEMP °F DB	UNIT ELECTRIC DATA				REMARKS
		MANUFACTURER	MODEL			CFM		E.S.P.	H.P.	CAPACITY MBH	EAT° F		LAT °F				VOLT	PH	MCA	MOCP	
						S.A.	O.A.				DB	WB	DB	WB							
AHU-1	127E COMPUTER LAB	YORK	J06ZFE18A4AA5	R-410A	11.2	1,800	320	0.5	1.5	71.6	79.1	66.7	52.5	50.9	18/3	95	480	3	30.8	35	
AHU-2	127D CLASSROOM 1	YORK	J05ZFE10N4AA2	R-410A	13.0	1,250	320	0.5	1.5	54.1	81.1	68.2	52.9	51.7	10/3	95	480	3	18.4	20	
AHU-3	121 CLASSROOM 2	YORK	J05ZFE19N4AA2	R-410A	13.0	1,520	310	0.5	1.5	54.7	79.3	66.8	53.6	52.7	15/3	95	480	3	23.7	25	
REMARKS:																					
1. Provide with manufacture's roof curb min. 14" high.																					
2. Provide unit with birdscreen, backdraft damper, motor starter and disconnect.																					
3. Provide with convenience outlet.																					

VARIABLE AIR VOLUME TERMINAL UNIT SCHEDULE

PLAN MARK	DESIGN CFM	MINIMUM CFM	HEATING KW	UNIT SIZE	NC RATING	MAX. APD (IN WG)
VTU-1	1,120	450	5	10	18	0.25

NOTES:

1. BASIS OF DESIGN: TRANE VCEF.  
2. NC RATING IS AT 1" WC STATIC.

AIR TERMINAL SCHEDULE

MARK	MANUFACTURER	MODEL	NECK SIZE	FACE SIZE
A	TITUS	TMS	8ø	24x24
D	TITUS	45F	22x22	24x24
E	TITUS	350FL	6x4	8x6
F	TITUS	350FL	24x10	26x12

DX SPLIT SYSTEM SCHEDULE																								
PLAN MARK	SELECTION BASED ON			REFRIGERANT TYPE	FAN DATA		COOLING COIL DATA				AHU ELECTRICAL DATA							C U ELECTRICAL DATA					REMARKS	
	MANUFACTURER	AHU MODEL	CU MODEL		TOTAL CFM	EXT. ΔP IN H2O	MBH	EAT °F		LAT°F		NO. OF FANS	WATTS	VOLTAGE	PHASE	FLA	MCA	MOCP	VOLTAGE	PHASE	FLA	MCA		MOCP
								DB	WB	DB	WB													
SS-01 / CU-01	MTSUBISHI	PLA-A24BA	PUY-A24NH3	R-410A	640	0.1	24	75	63.2	53.0	52.1	1	50	208	1	0.51	1	25	208	1	0.75	18	25	
SS-02 / CU-02	MTSUBISHI	PLA-A24BA	PUY-A24NH3	R-410A	640	0.1	24	75	63.4	53.0	52.1	1	50	208	1	0.51	1	25	208	1	0.75	18	25	
REMARKS:																								
1. Size refrigerant piping per manufacturer's recommendation.																								
2. Provide curb and manufacturer's standard options required to mount condensing unit at grade.																								
3.																								

EXHAUST FAN SCHEDULE

MARK	MANUFACTURER	MODEL	AREA SERVED	EXHAUST AIRFLOW	FAN TYPE	DRIVE TYPE	VOLTAGE	PHASE	RLA	WATTS	ESP	COMMENTS
EF-01	BROAN	XB80	TOILET 105A	50 CFM	SINGLE SPEED	DIRECT	115 V	1	0.1 A	5.80 W	0.20 in-wg	PROVIDE WITH MANUFACTURER'S ROOF CAP


REVISIONS AND UPDATES

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SUWANNEE COUNTY SCHOOL BOARD  
SUWANNEE PRIMARY SCHOOL  
ADDITIONS AND REMODELING  
1625 WALKER AVE., SW  
LIVE OAK, FLORIDA

MECHANICAL SCHEDULES

drawn **TM** checked **JM** approved **JM**

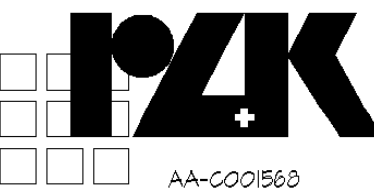

job no. 2012.51

M-3.1



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
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REVISIONS AND UPDATES	
02/14/14	CONSTRUCTION DOCUMENTS FOR BID/PERMIT

JUSTANNEE COUNTY SCHOOL BOARD  
SUWANNEE PRIMARY SCHOOL  
ADDITIONS AND REMODELING  
1625 WALKER AVE., SW    LIVE OAK, FLORIDA  
**MECHANICAL ENLARGED DEMOLITION PLAN**

drawn **TMM**    checked **JPM**    approved **JPM**

  
AA-0001560

job no. 2012.51  
**MD-1.1**

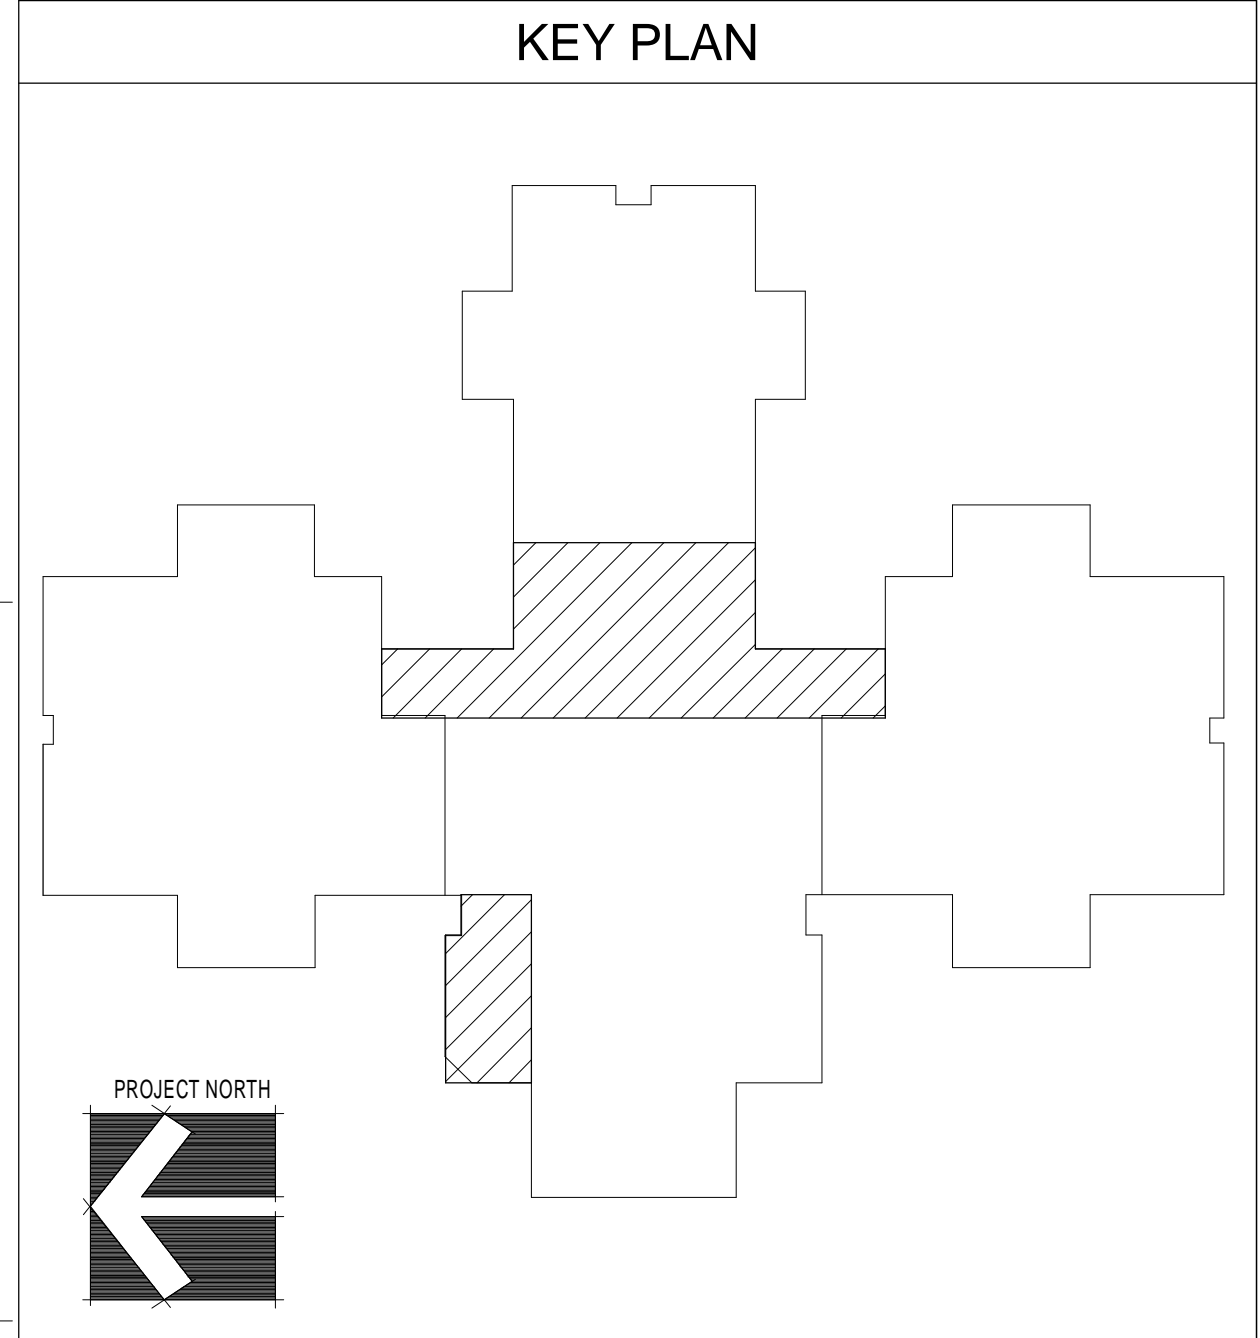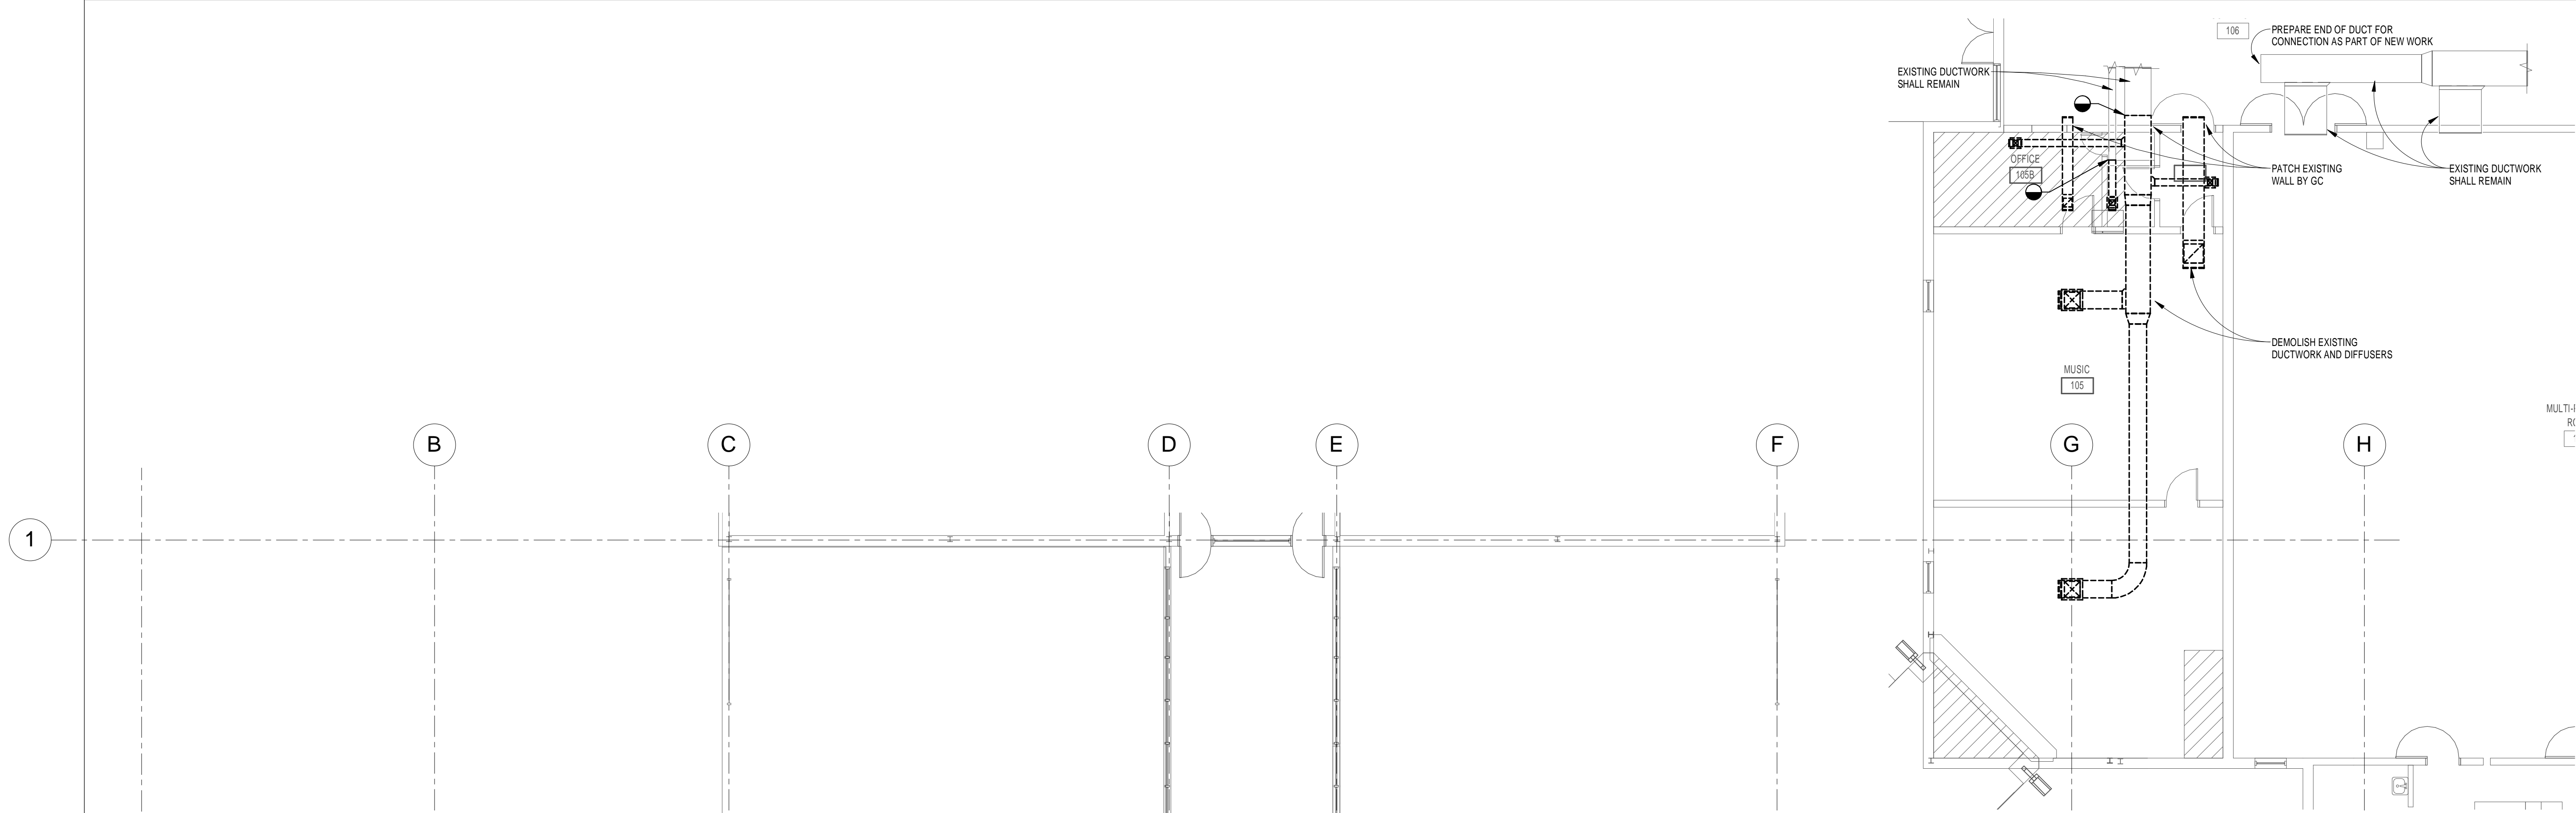**ARCHITECTS RZK, INC.**  
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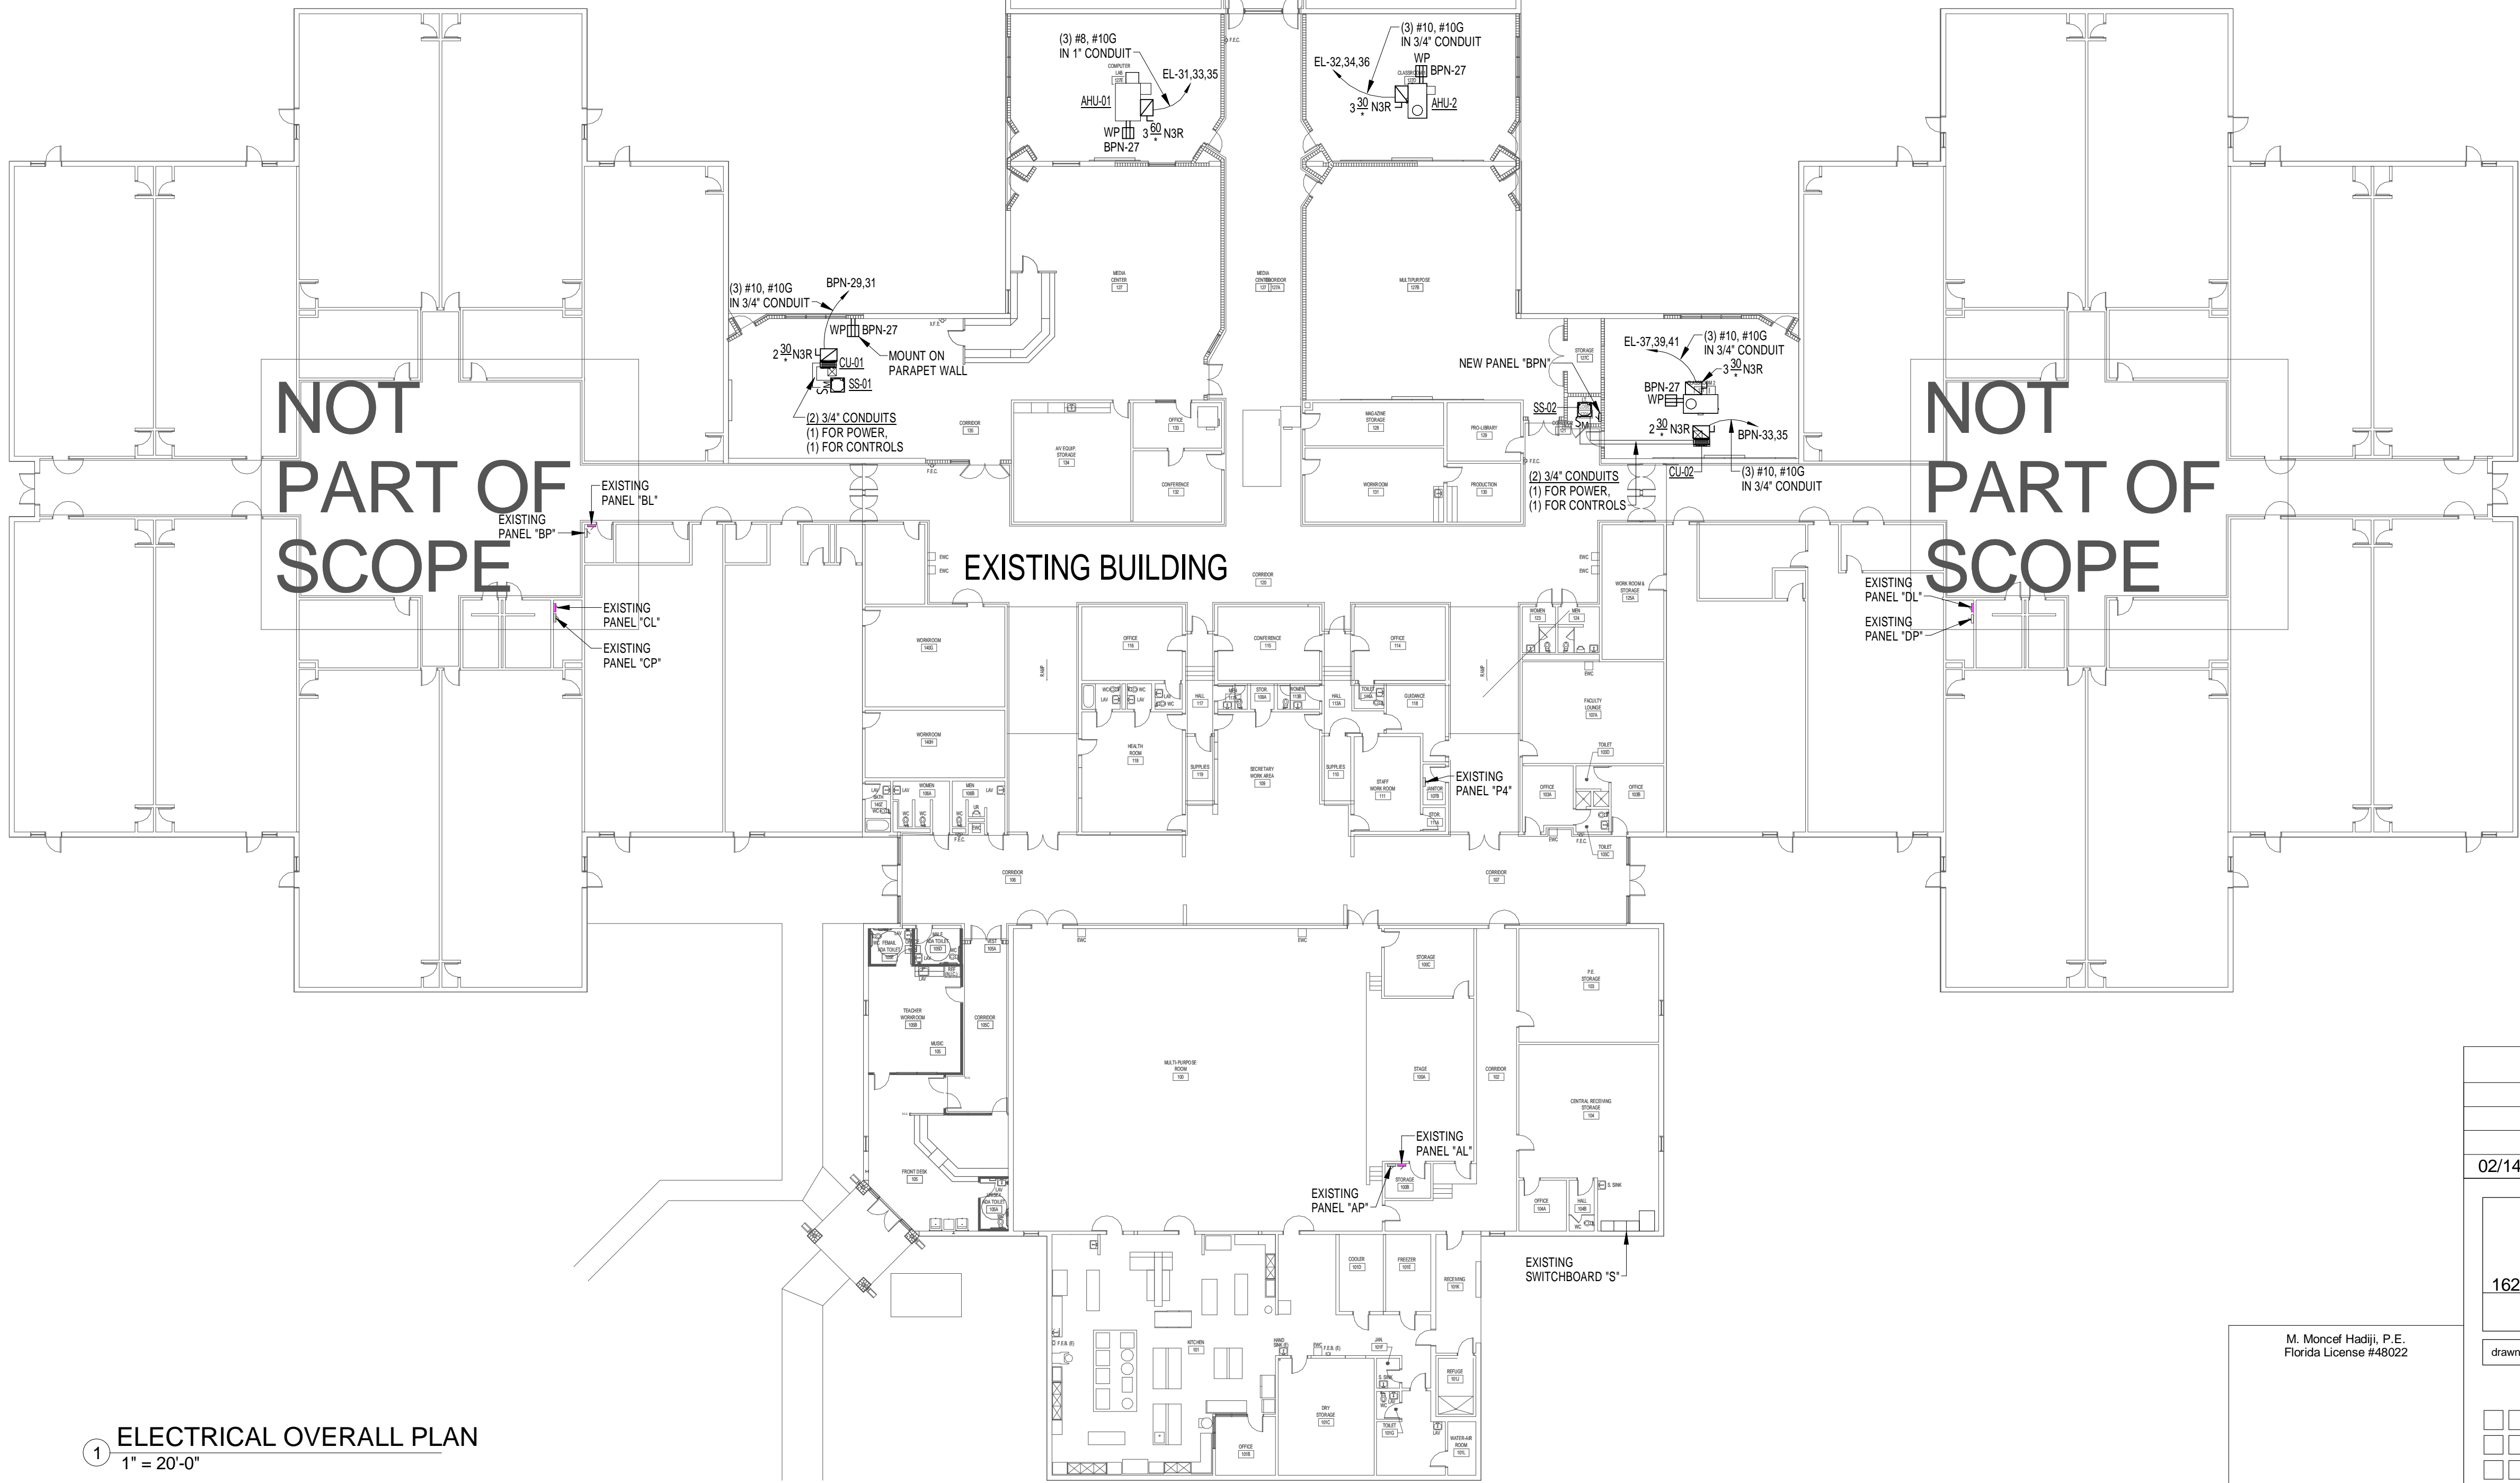
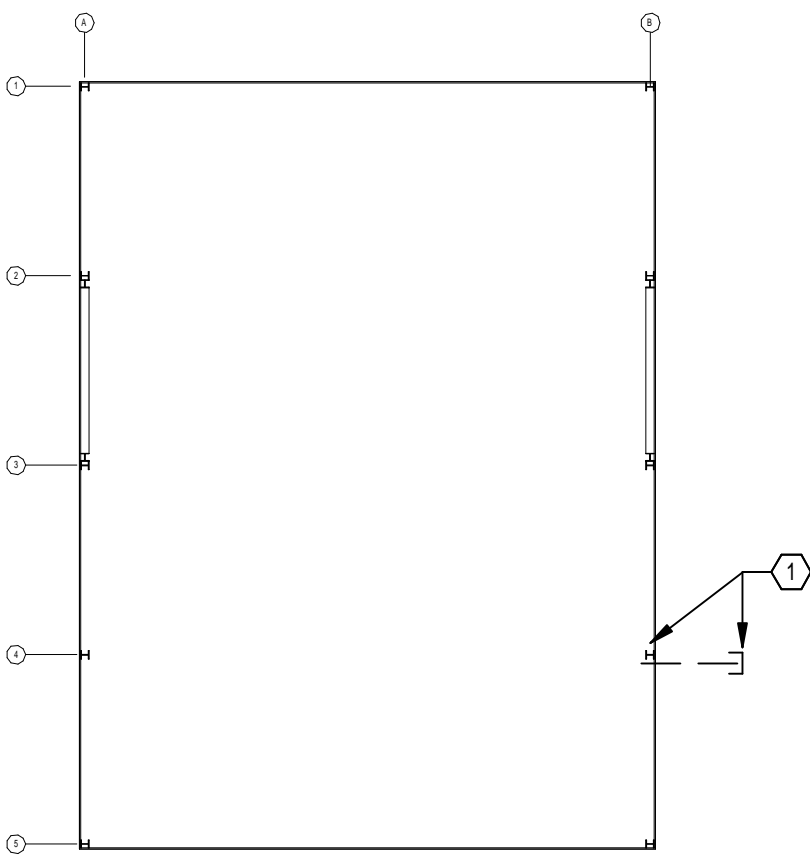






KEYED NOTES:

- ① PROVIDE (2) 1" CONDUITS WITH PULL STRING TO 10' OUTSIDE BUILDING PERIMETER. STUB CONDUITS UP 6" AFF AT COLUMN, CAP AND MARK CONDUITS FOR FUTURE POWER CONNECTION.
- ② EXISTING PANEL 'EL' TO BE REPLACED. REFER TO ONE-LINE DIAGRAM ON SHEET E-4.1.




① ELECTRICAL OVERALL PLAN  
1" = 20'-0"

REVISIONS AND UPDATES

02/14/14 CONSTRUCTION DOCUMENTS FOR BID/PERMIT

SUWANNEE COUNTY SCHOOL BOARD  
SUWANNEE PRIMARY SCHOOL  
ADDITIONS AND REMODELING  
1625 WALKER AVE., SW LIVE OAK, FLORIDA  
ELECTRICAL OVERALL PLAN

drawn CVM/PJM checked MMH approved MMH

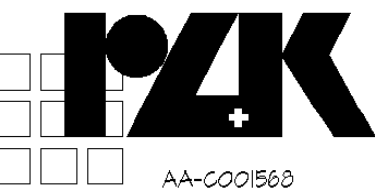

ARCHITECTS RZK, INC.  
600 FLORIDA AVENUE SUITE 202 COCOA, FLORIDA 32922 TELEPHONE (321) 631-8039

job no. 2012.51

E-1.0


M. Moncef Hadji, P.E.  
Florida License #48022

Seal




KEYED NOTES:

- ① EXISTING LIGHTING FIXTURE/ELECTRICAL DEVICE TO BE DEMOLISHED. RETAIN CIRCUIT FOR FUTURE USE AND MAINTAIN CONTINUITY TO ANY DOWNSTREAM CIRCUITS/FIXTURES AFFECTED BY DEMOLITION (TYPICAL).
- ② EXISTING LIGHTING FIXTURE/ELECTRICAL DEVICE TO REMAIN. (TYPICAL)
- ③ EXISTING CEILING MOUNTED SPEAKER TO BE RELOCATED. REFER TO POWER PLANS ON SHEET E3.1 FOR NEW LOCATIONS. MAINTAIN CONTINUITY TO ANY DOWNSTREAM SPEAKERS AFFECTED BY DEMOLITION (TYPICAL).
- ④ EXISTING FIRE ALARM DEVICE TO BE RELOCATED. REFER TO POWER PLANS ON SHEET E3.1 FOR NEW LOCATIONS. MAINTAIN CONTINUITY TO ANY DOWNSTREAM DEVICES/SPEAKERS AFFECTED BY DEMOLITION (TYPICAL). PROVIDE ACCEPTANCE TESTING PER NFPA.
- ⑤ ALL LIGHTING FIXTURES, ELECTRICAL DEVICES AND SYSTEMS DEVICES WITHIN THIS AREA ARE EXISTING TO REMAIN.


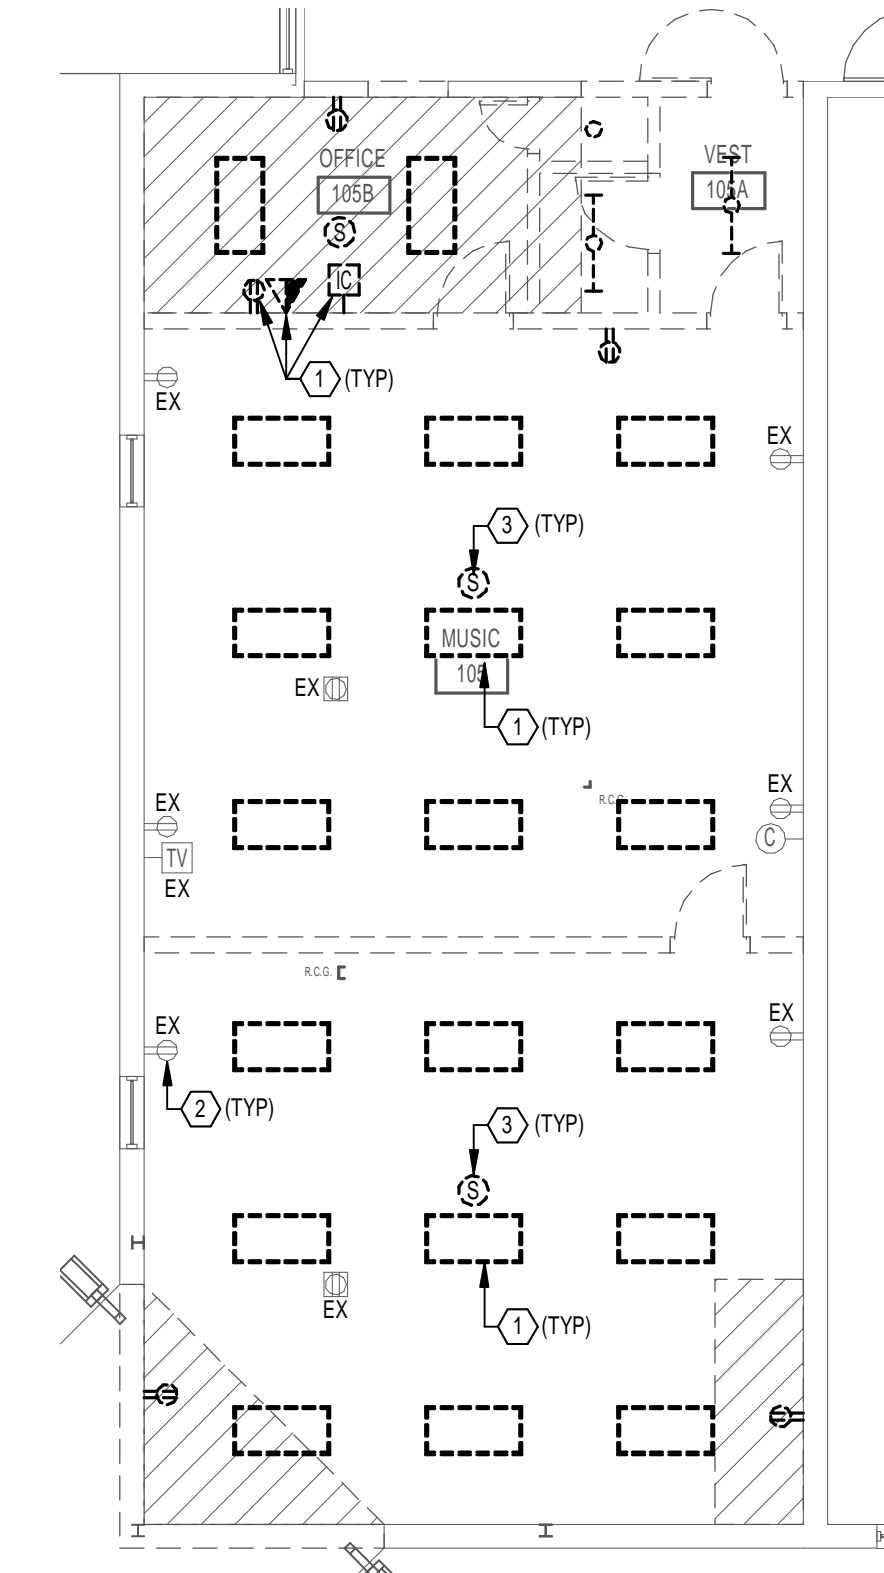


2 ENTRANCE ELECTRICAL DEMOLITION PLAN  
1/8" = 1'-0"

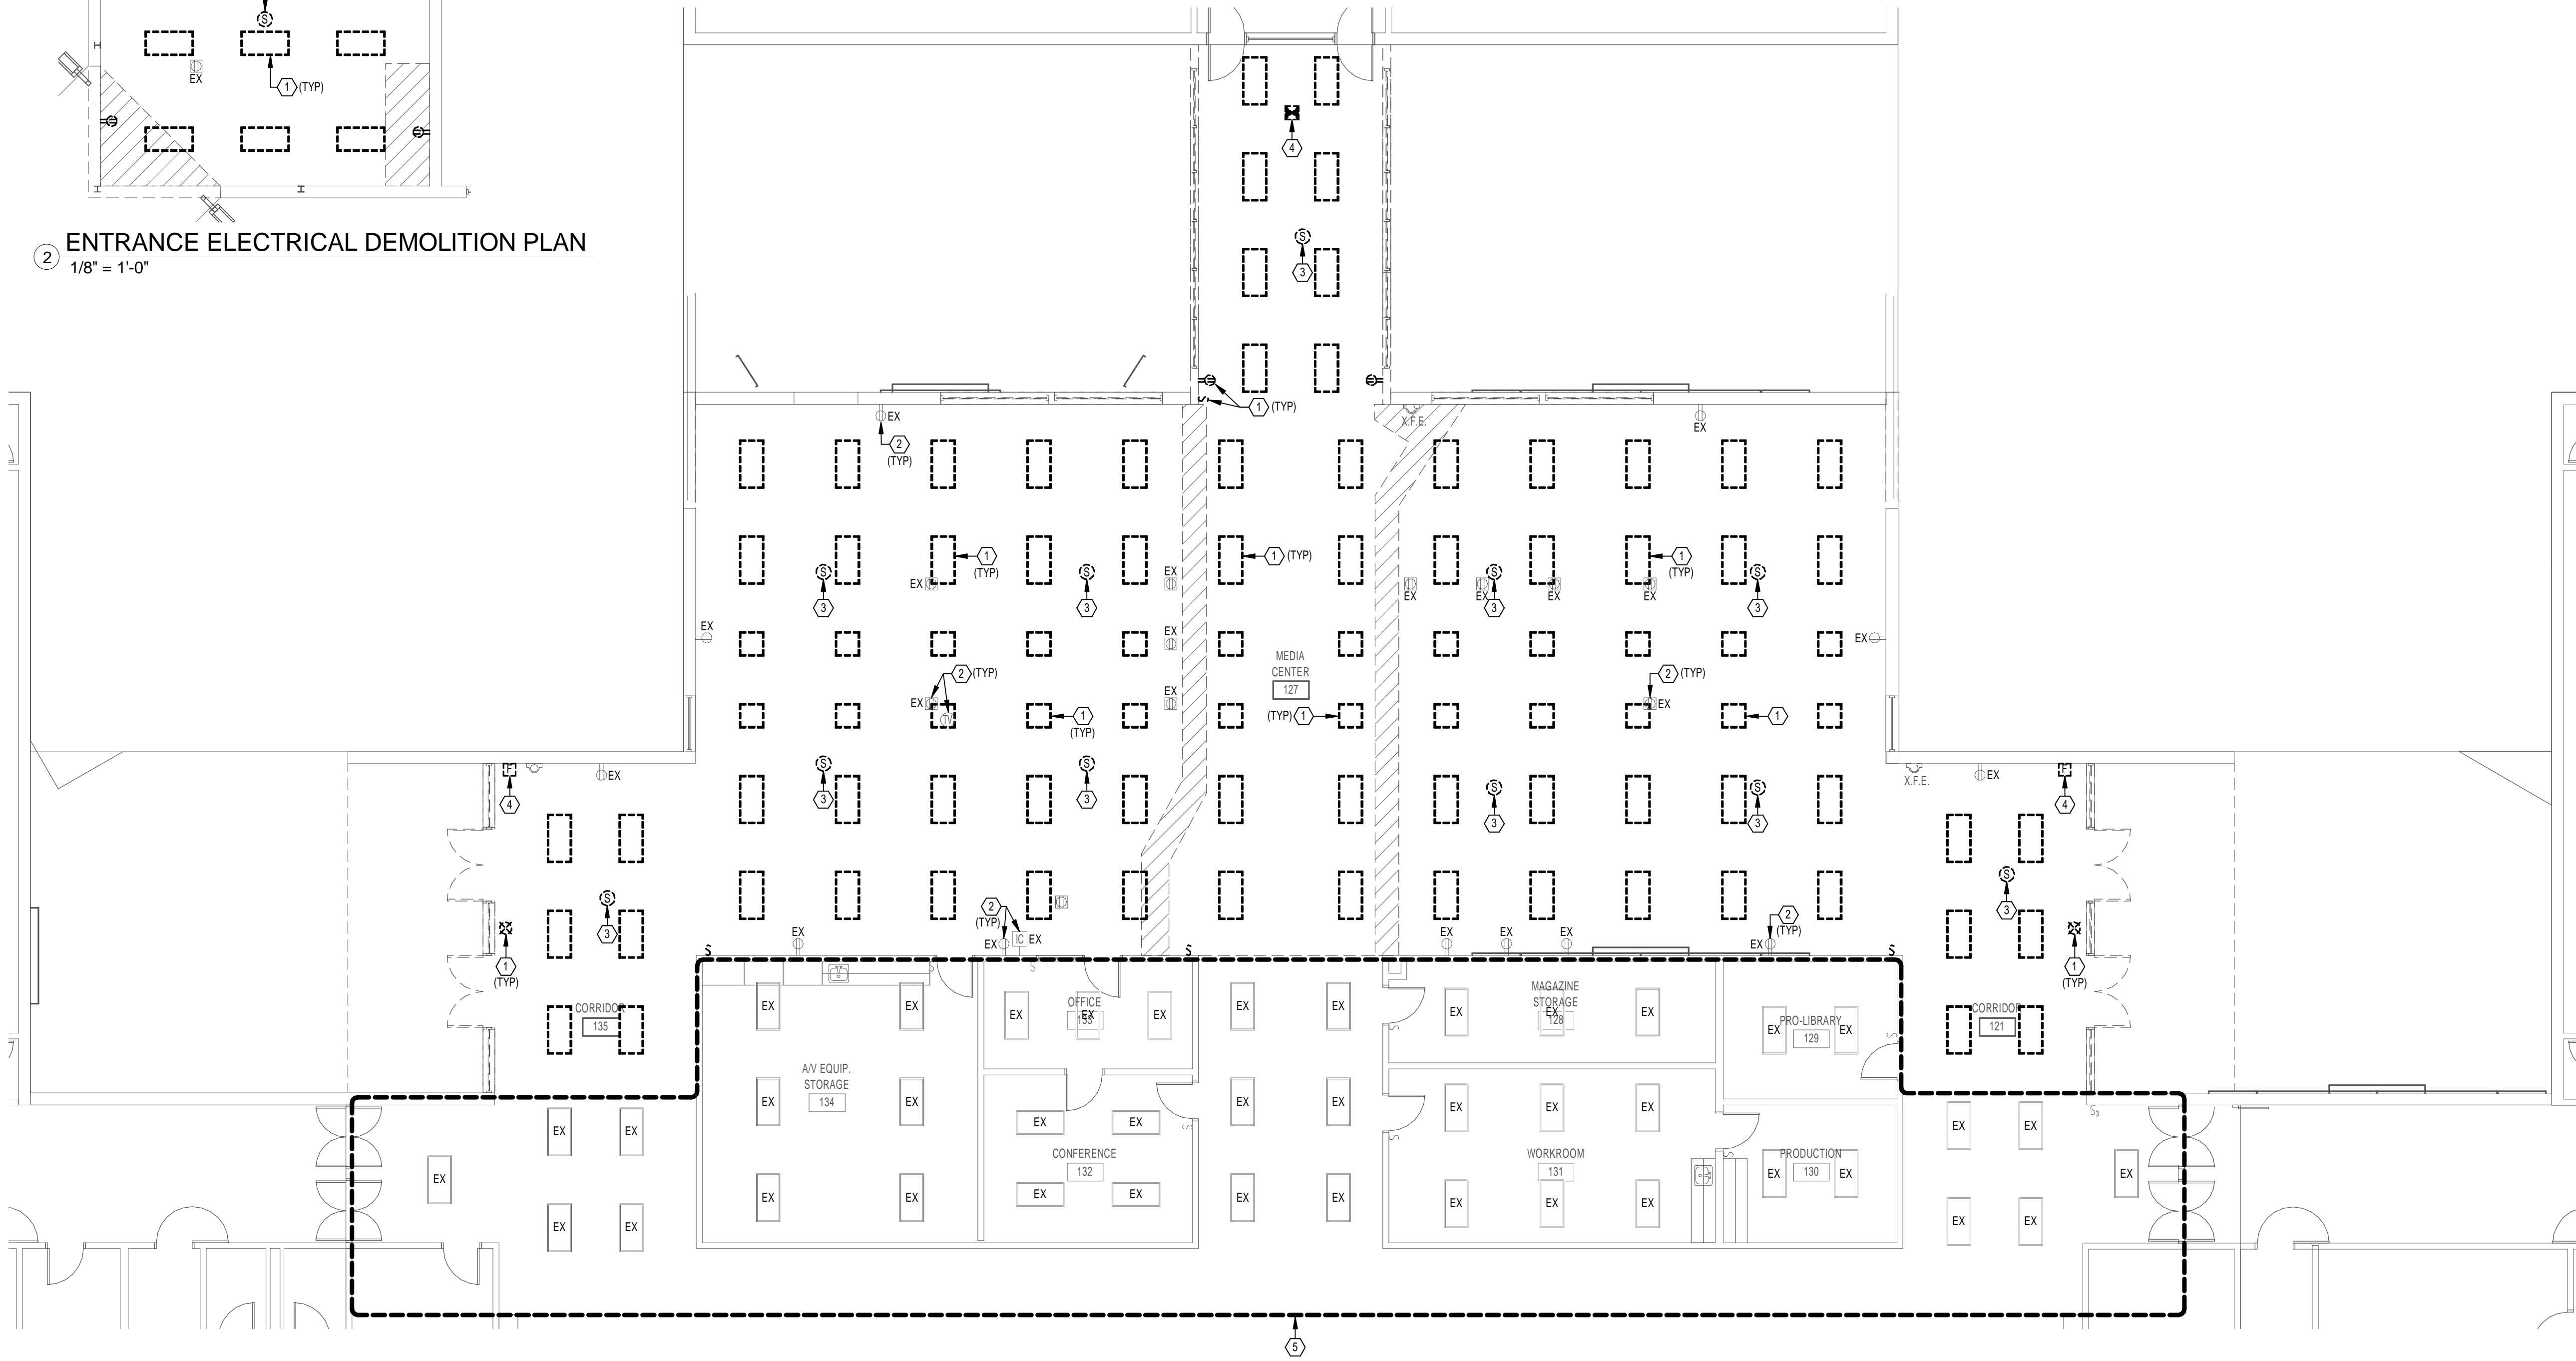

1 ELECTRICAL DEMOLITION PLAN  
1/8" = 1'-0"

KEY PLAN

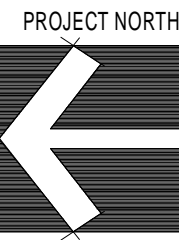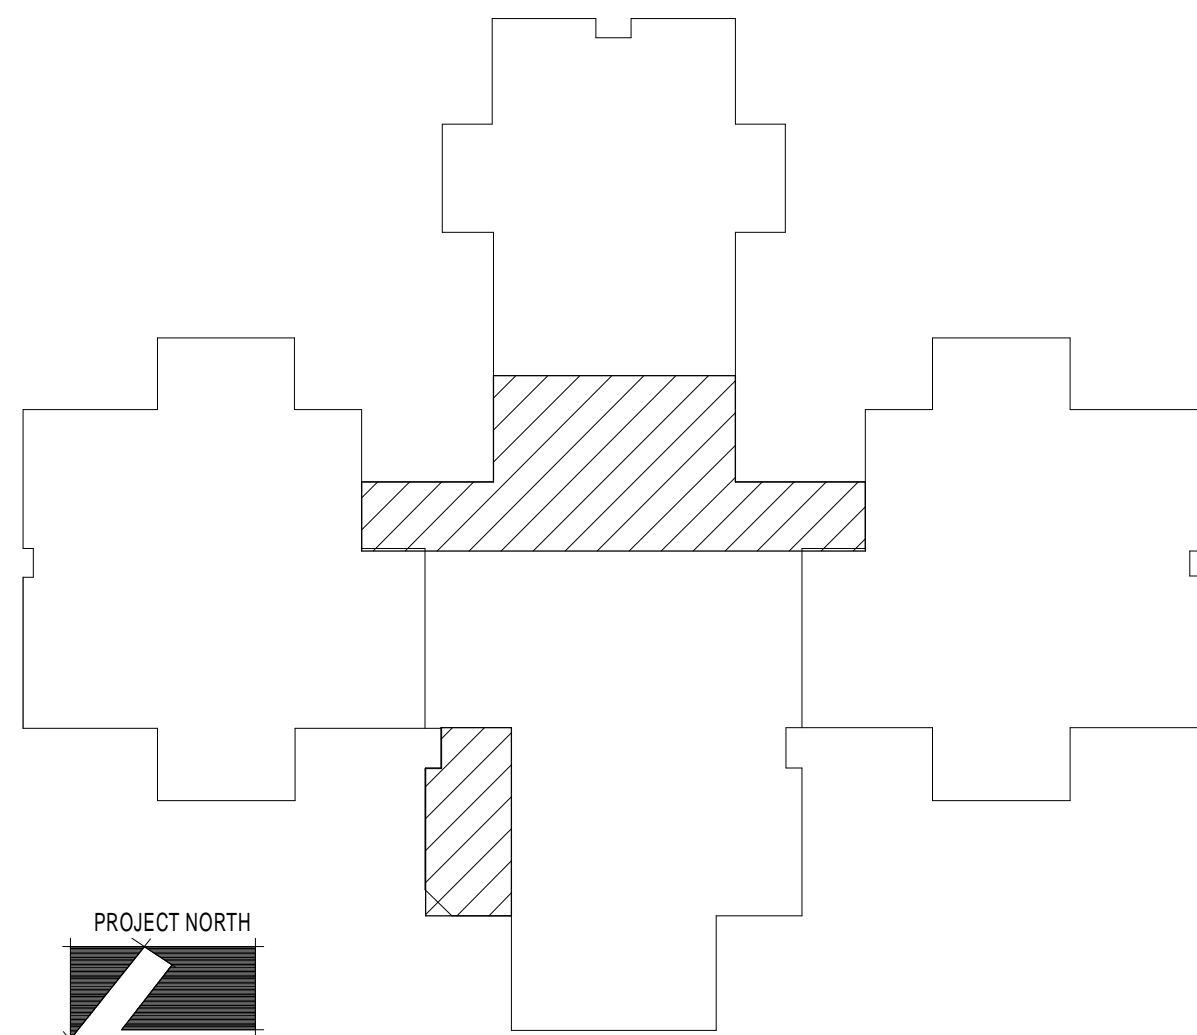


REVISIONS AND UPDATES

DATE	DESCRIPTION
02/14/14	CONSTRUCTION DOCUMENTS FOR BID/PERMIT

SUWANNEE COUNTY SCHOOL BOARD  
SUWANNEE PRIMARY SCHOOL  
ADDITIONS AND REMODELING  
1625 WALKER AVE., SW      LIVE OAK, FLORIDA  
ELECTRICAL DEMOLITION PLAN

drawn: PJM      checked: MMH      approved: MMH

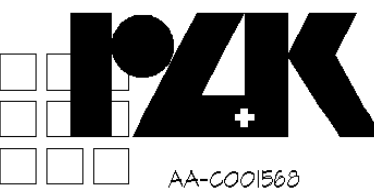

ARCHITECTS RZK, INC.  
600 FLORIDA AVENUE SUITE 202 COCOA, FLORIDA 32922      TELEPHONE (321) 631-8039

job no. 2012.51


E-1.1

M. Moncef Hadji, P.E.  
Florida License #48022

Seal

KEYED NOTES:

- CONNECT NEW CORRIDOR LIGHTING TO EXISTING CORRIDOR LIGHTING CIRCUIT. PROVIDE #12 AWG IN 1/2" CONCEALED CONDUIT.
- CONNECT NEW LIGHTING TO EXISTING 277V CIRCUIT WITHIN PANEL "BL" MADE AVAILABLE FROM DEMOLITION. PROVIDE NEW 1P/20A PANELBOARD MATCHING CIRCUIT BREAKER AND #12AWG IN 1/2" CONCEALED CONDUIT.
- CONNECT NEW LIGHTING TO EXISTING 277V SPARE AVAILABLE CIRCUITRY WITHIN PANEL "DL". PROVIDE NEW 1P/20A PANELBOARD MATCHING CIRCUIT BREAKER AND #12AWG IN 1/2" CONCEALED CONDUIT.
- CONNECT NEW LIGHTING TO EXISTING 277V CIRCUIT WITHIN PANEL "AL" MADE AVAILABLE FROM DEMOLITION. PROVIDE NEW 1P/20A PANELBOARD MATCHING CIRCUIT BREAKER AND #12AWG IN 1/2" CONCEALED CONDUIT.

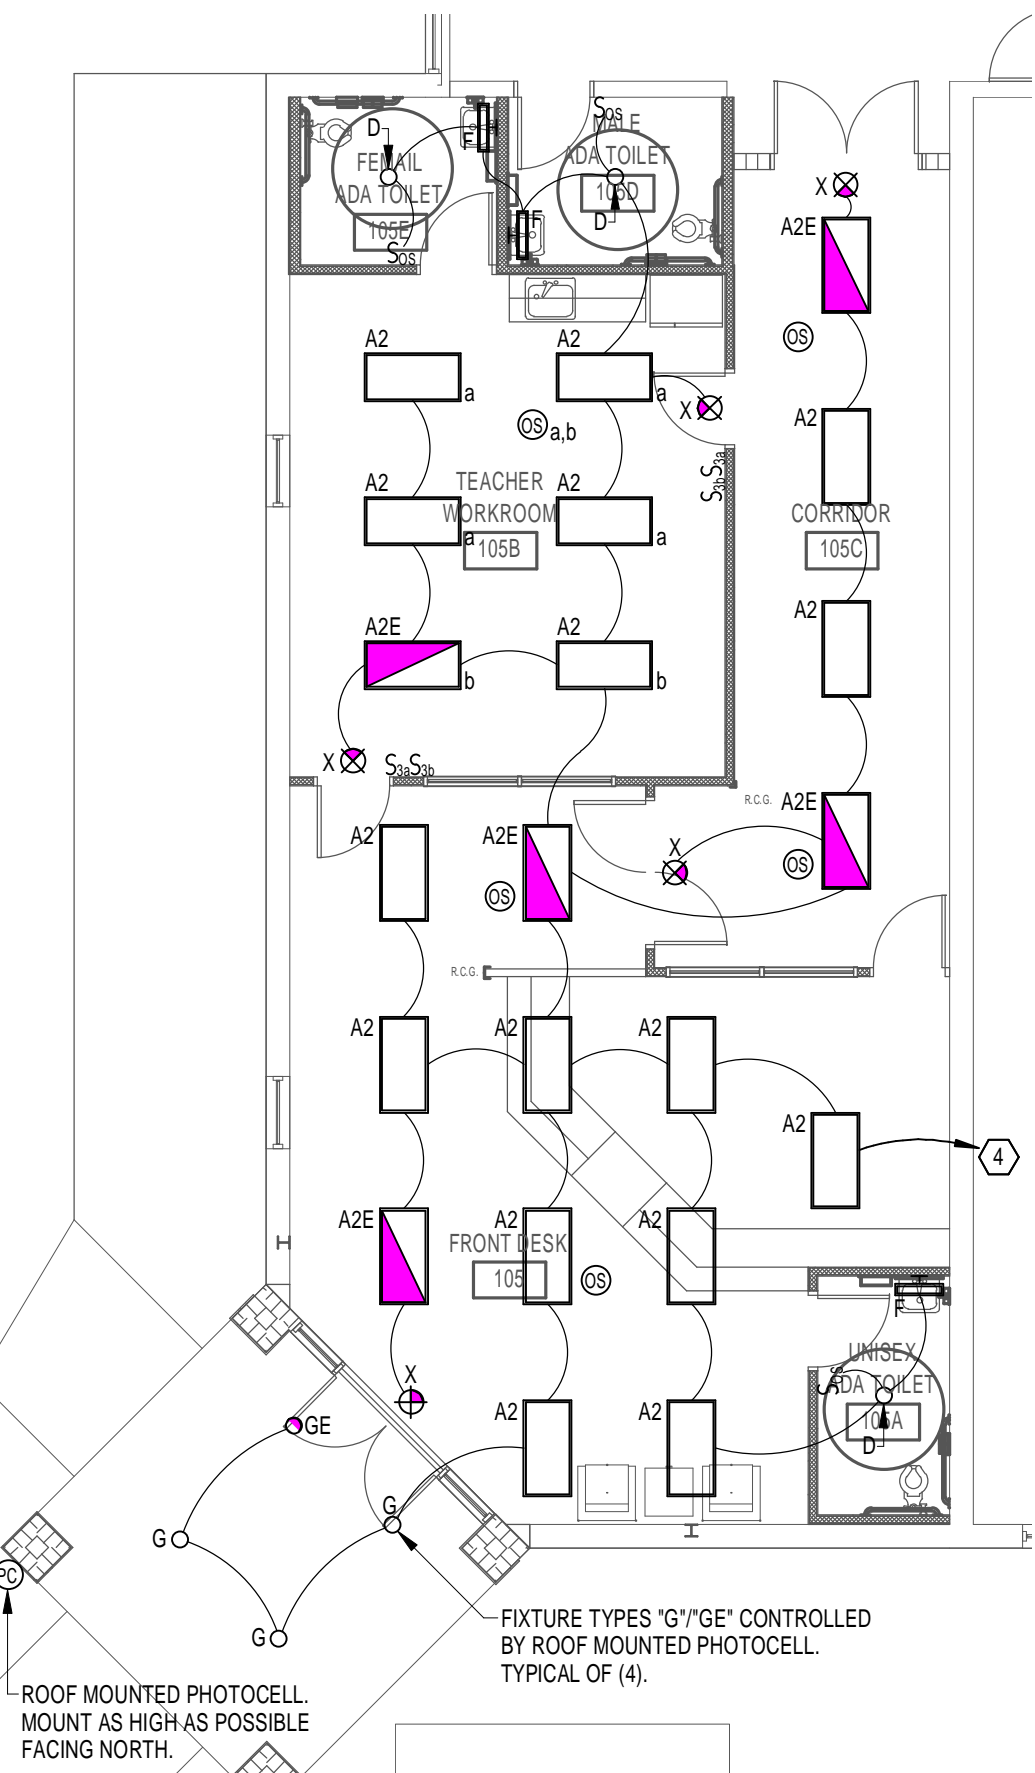


2 ENTRANCE LIGHTING PLAN  
1/8" = 1'-0"



1 LIGHTING PLAN  
1/8" = 1'-0"

KEY PLAN

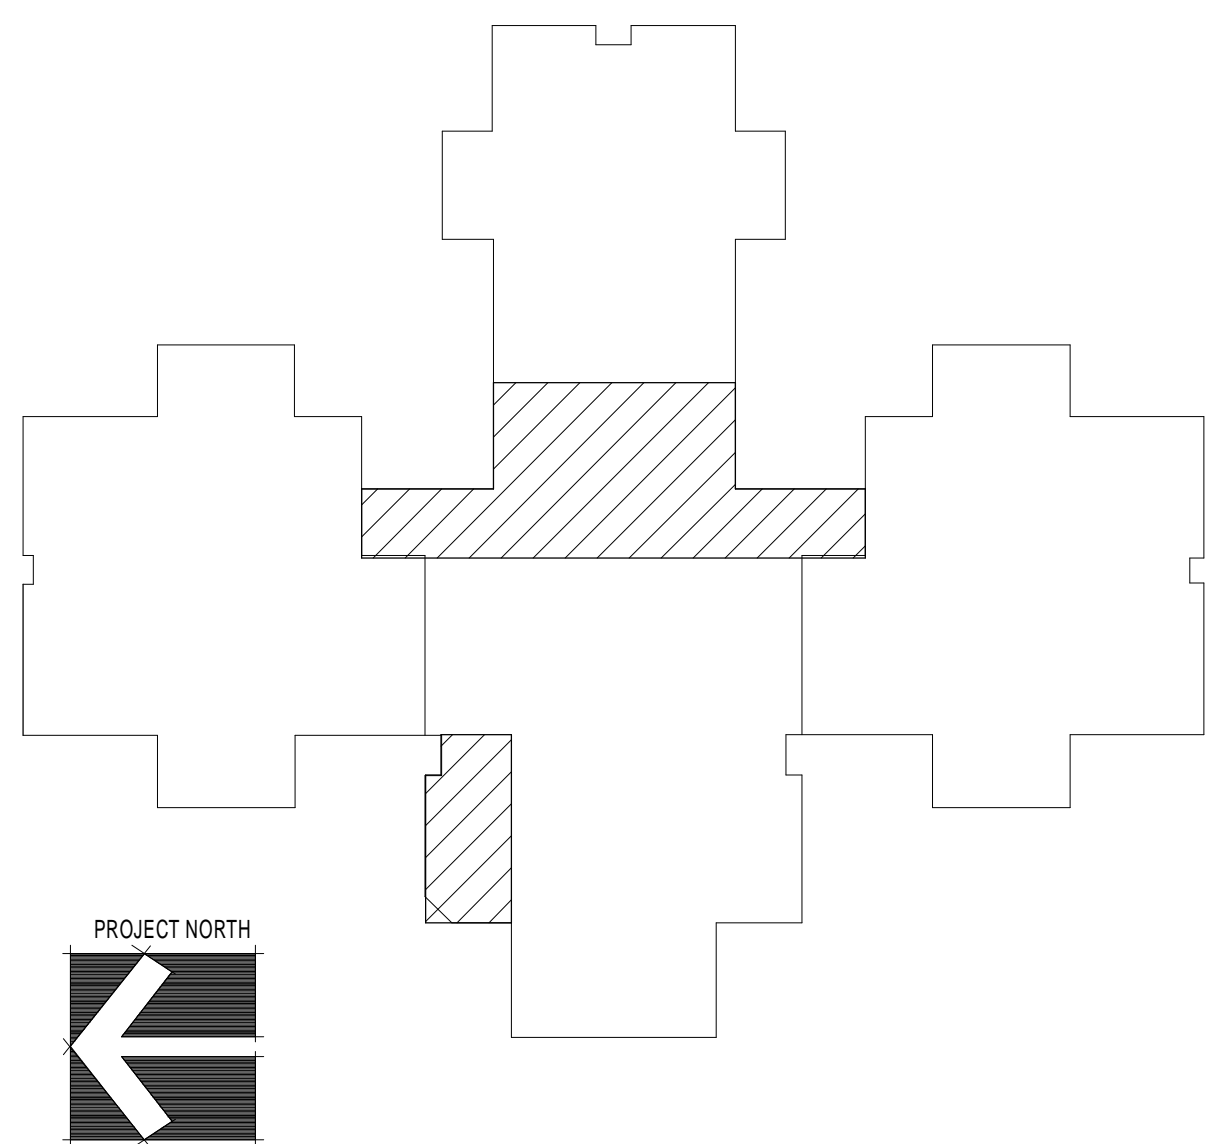


REVISIONS AND UPDATES

DATE	DESCRIPTION
02/14/14	CONSTRUCTION DOCUMENTS FOR BID/PERMIT

SUWANNEE COUNTY SCHOOL BOARD  
SUWANNEE PRIMARY SCHOOL  
ADDITIONS AND REMODELING  
1625 WALKER AVE., SW      LIVE OAK, FLORIDA

LIGHTING PLANS

drawn: PJM      checked: MMH      approved: MMH

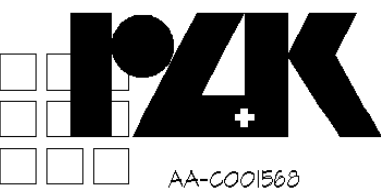

ARCHITECTS RZK, INC.  
600 FLORIDA AVENUE SUITE 202 COCOA, FLORIDA 32922      TELEPHONE (321) 631-8039

job no. 2012.51

E-2.1

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Florida License #48022


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KEYED NOTES:

- (1) 2 1/2" CONDUITS ABOVE ACCESSIBLE CEILING FOR DATA CABLING.
- (2) NEW LOCATION OF EXISTING CEILING MOUNTED INTERCOM SPEAKER. EXTEND/REPLACE WIRING AS REQUIRED TO ACCOMMODATE NEW LOCATION. MAINTAIN CONTINUITY TO EXISTING DOWNSTREAM DEVICES.
- (3) 2 4-GANG FLUSH MOUNTED JUNCTION BOXES WITH 1 1/4" CONDUIT EACH EXTENDED TO ABOVE ACCESSIBLE CEILING. (1) FOR FUTURE POWER AND (1) FOR FUTURE DATA.
- (4) CONNECT NEW RECEPTACLE(S) TO EXISTING RECEPTACLE CIRCUIT. PROVIDE #12AWG IN 1/2" CONCEALED CONDUIT.
- (5) CONNECT NEW RECEPTACLES TO EXISTING 120V SPARE AVAILABLE CIRCUITRY WITHIN PANEL "AP". PROVIDE NEW 1P/20A PANELBOARD MATCHING CIRCUIT BREAKER AND #12AWG IN 1/2" CONCEALED CONDUIT.
- (6) CONNECT NEW EXHAUST FAN TO ROOM LIGHTING CIRCUIT.
- (7) CONNECT TO EXISTING PANEL "P4" LOCATED IN JANITOR CLOSET 107B. PROVIDE (4) #10, (1) #10G IN 3/4" CONCEALED CONDUIT. REFER TO OVERALL PLAN ON SHEET E-1.0 FOR PANEL LOCATION.
- (8) PROVIDE REMOTE INTERCOM CONTROL STATION, WIRING AND MODULE AT EXISTING INTERCOM HEAD END EQUIPMENT TO ENABLE INTERCOM ANNOUNCEMENTS AT THIS LOCATION.
- (9) (2) 3" CONDUITS ABOVE ACCESSIBLE CEILING FOR DATA CABLING.

KEY PLAN




REVISIONS AND UPDATES

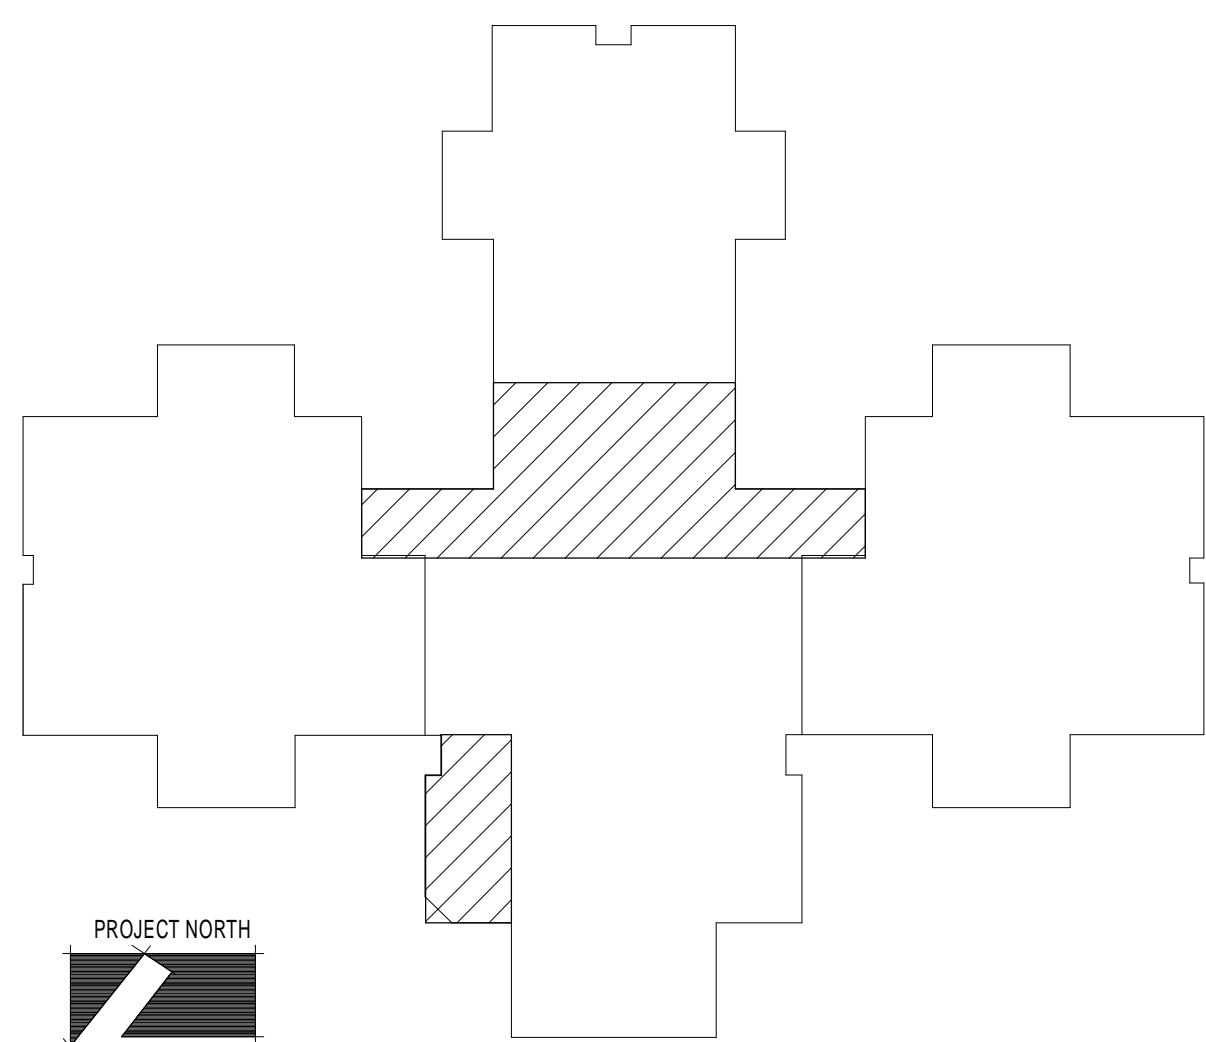DATE	DESCRIPTION
02/14/14	CONSTRUCTION DOCUMENTS FOR BID/PERMIT

SUWANNEE COUNTY SCHOOL BOARD  
SUWANNEE PRIMARY SCHOOL  
ADDITIONS AND REMODELING  
1625 WALKER AVE., SW    LIVE OAK, FLORIDA

POWER/SYSTEMS PLANS

drawn: PJM    checked: MMH    approved: MMH

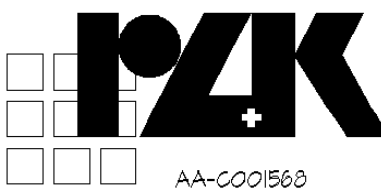

ARCHITECTS RZK, INC.  
600 FLORIDA AVENUE SUITE 202 COCOA, FLORIDA 32922    TELEPHONE (321) 631-8039

job no. 2012.51


E-3.1

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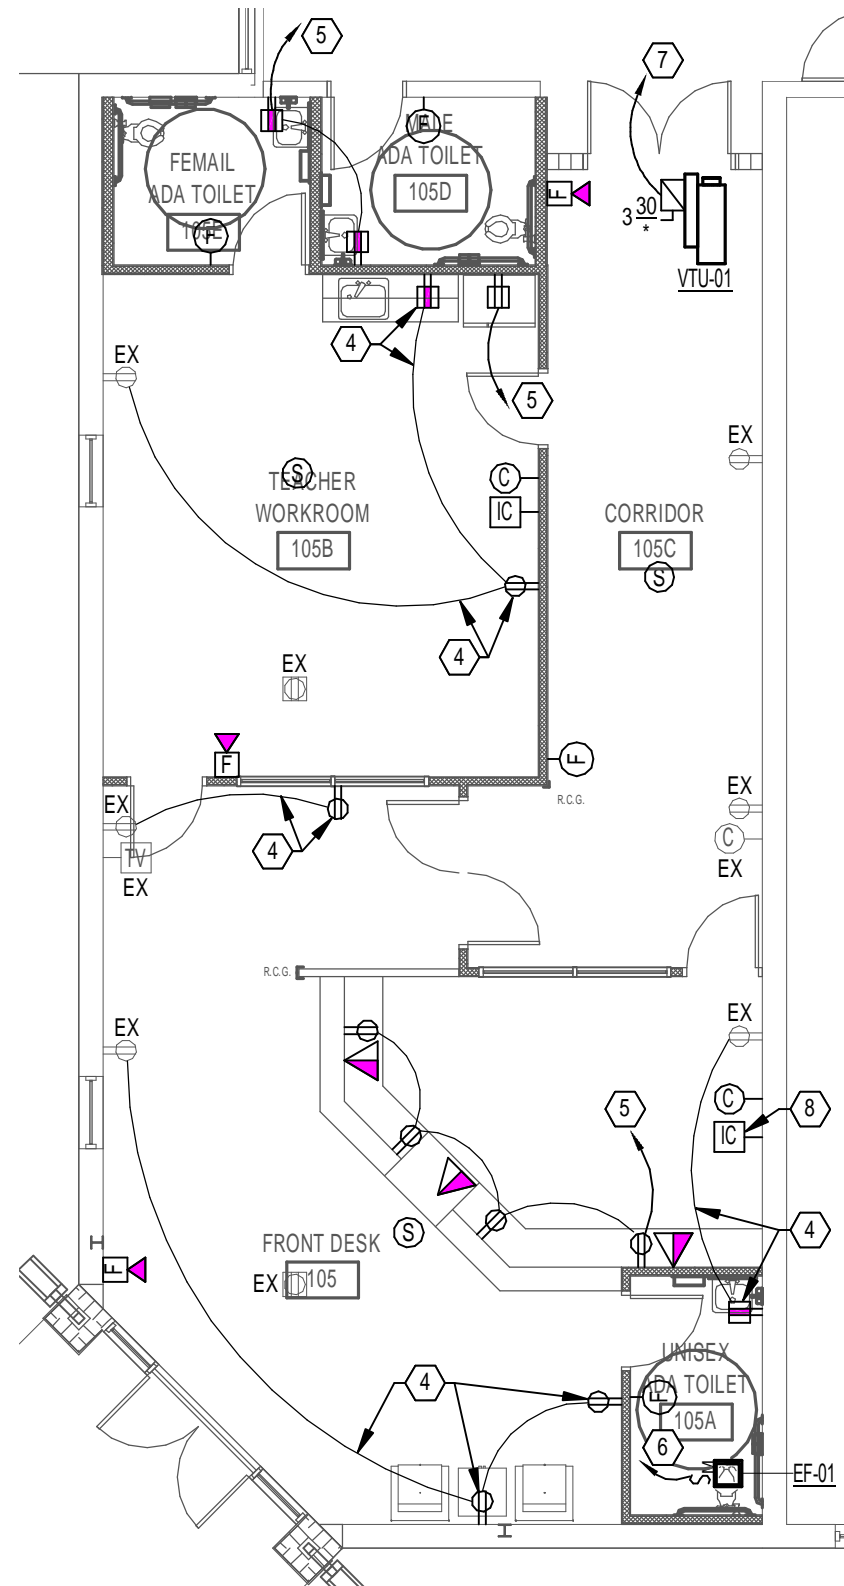
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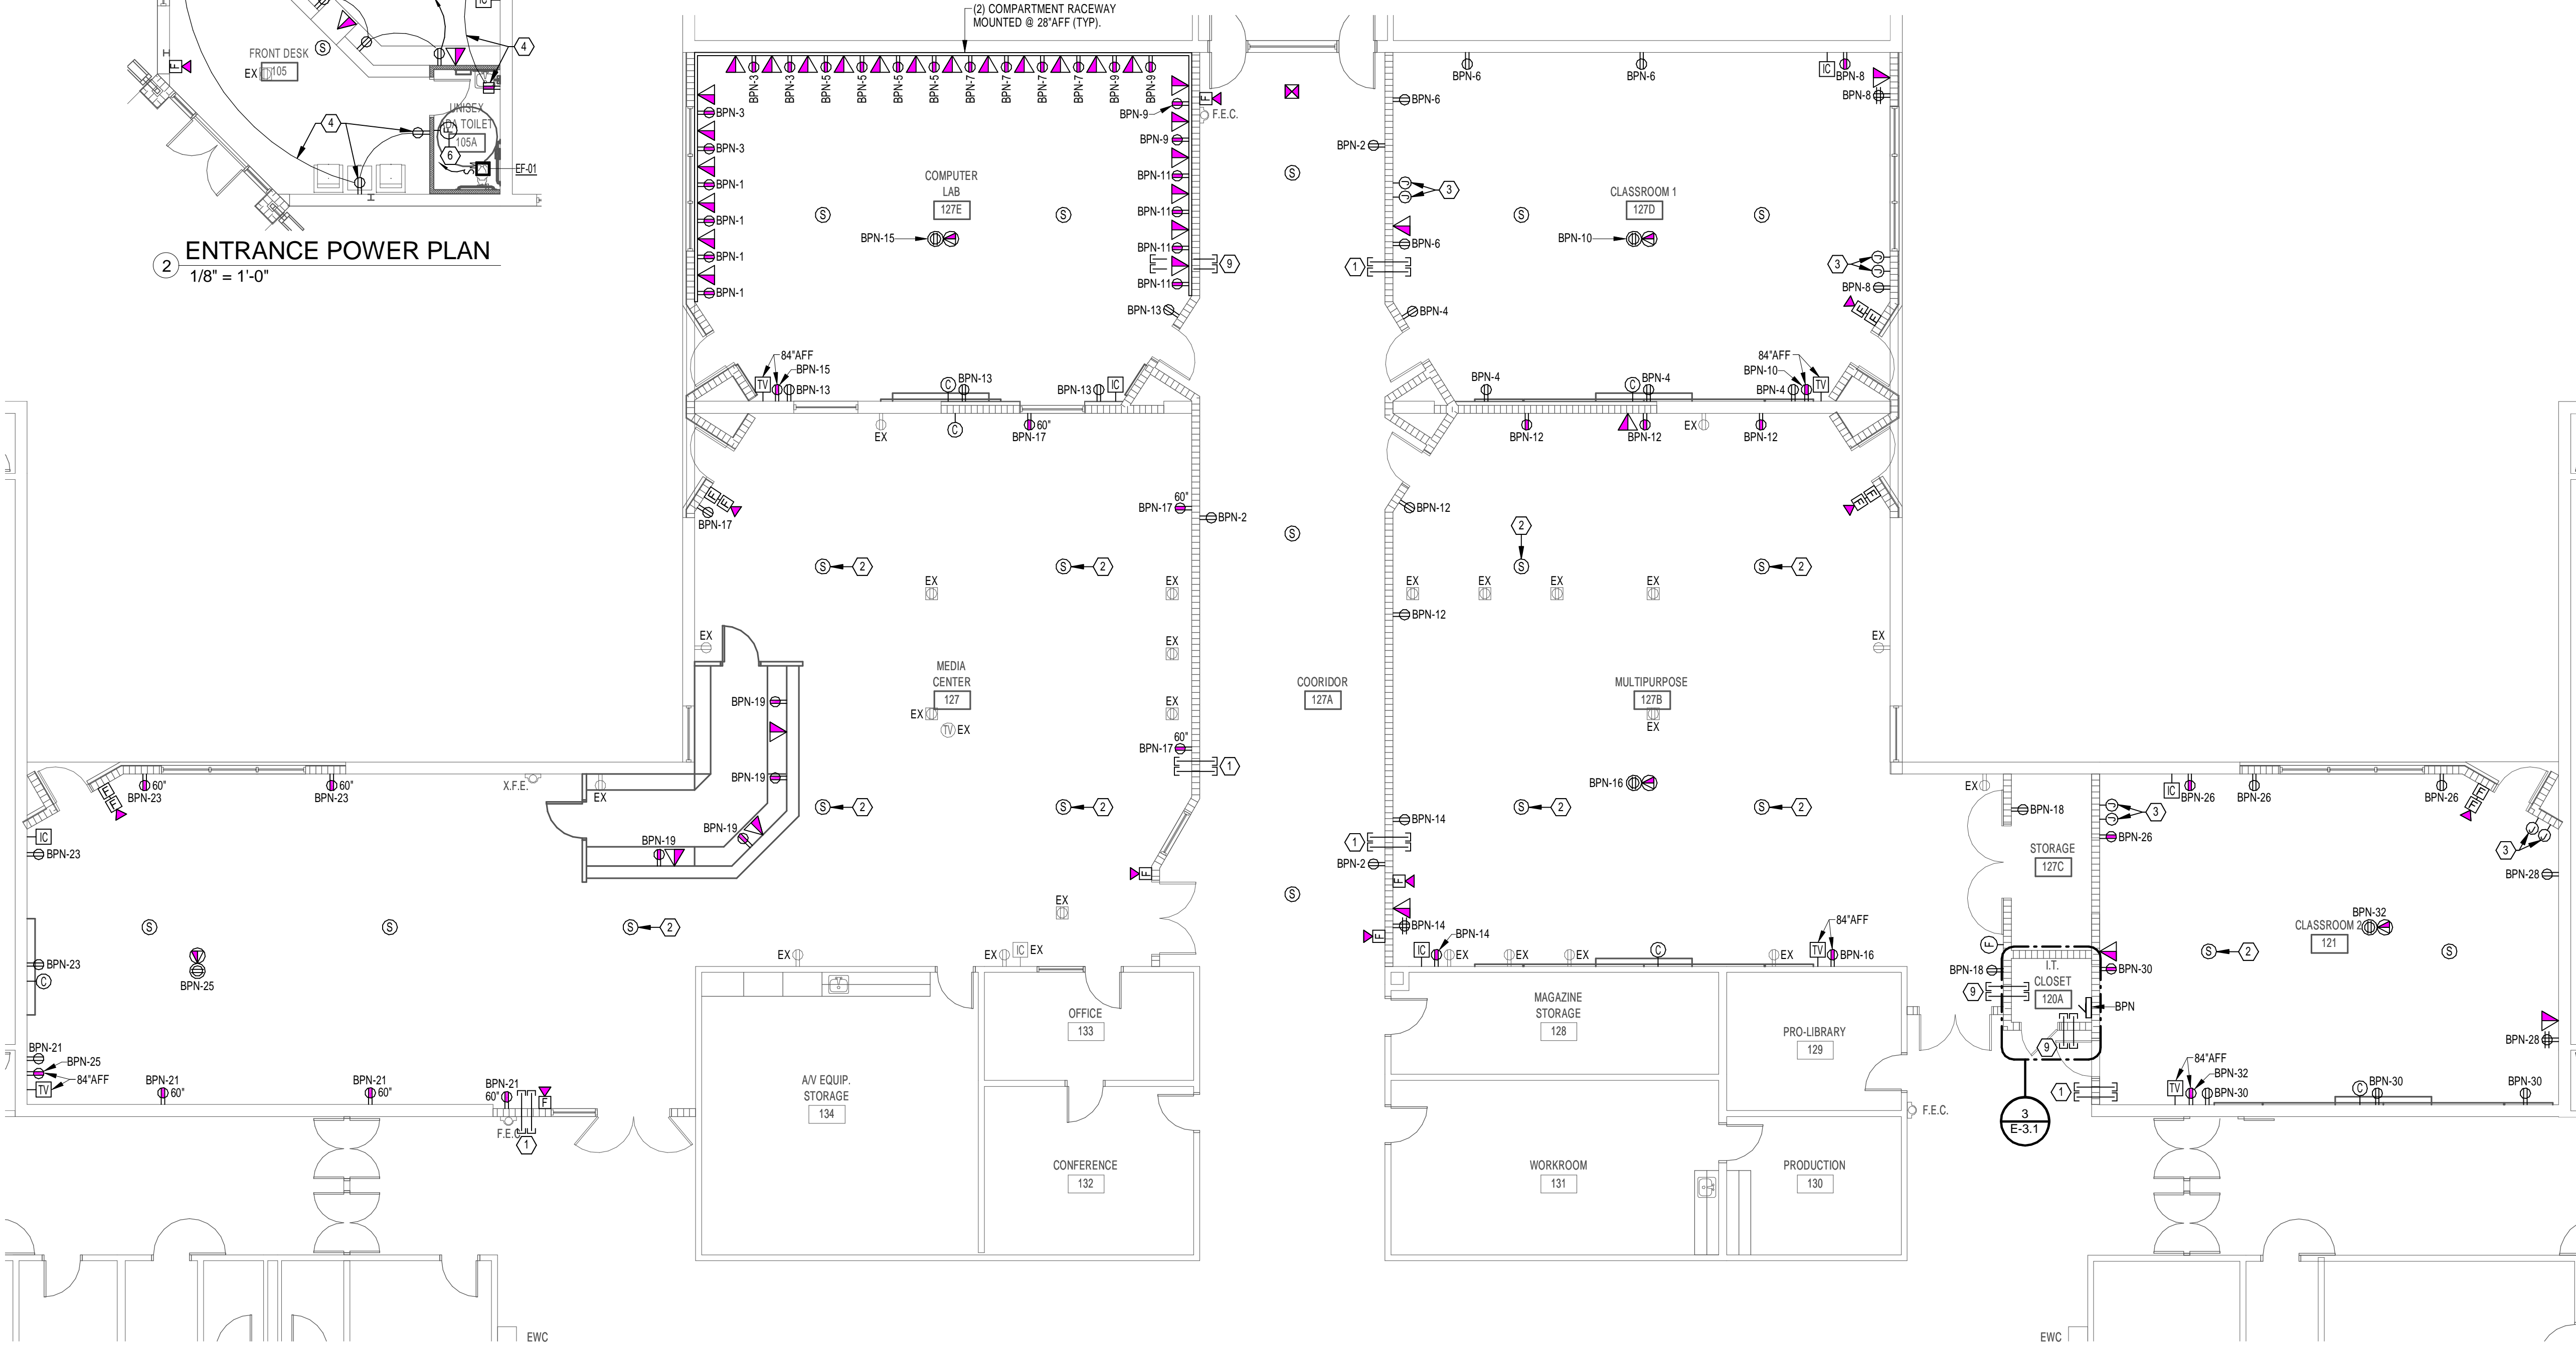
ENLARGED I.T. CLOSET 120A  
1/4" = 1'-0"



ENTRANCE POWER PLAN  
1/8" = 1'-0"

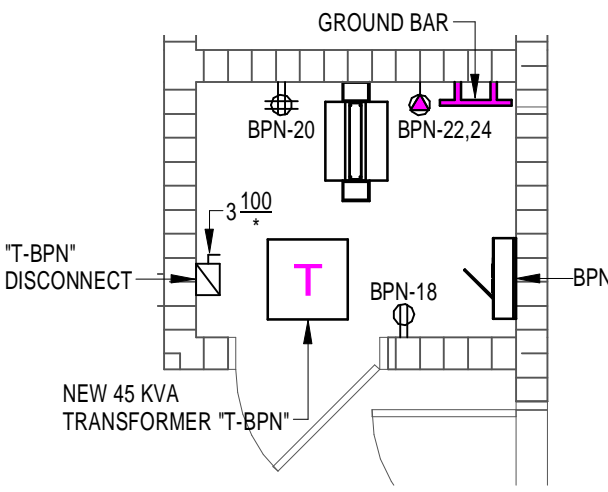

POWER PLAN  
1/8" = 1'-0"







Branch Panel: EL													
Location: Supply From: Mounting: Surface Enclosure: Type 1				Volts: 480/277 Wye Phases: 3 Wires: 4				A.I.C. Rating: 35,000 Mains Type: MLO Mains Rating: 225 A MCB Rating: Neutral Rating:					
Notes:													
CK T	Circuit Description	N o t e	P o l e	A		B		C		P o l e	N o t e	Circuit Description	CK T
1	Existing	20 A	1	2.8 kVA	4.1 kVA					1	20 A	Existing	2
3	Existing	20 A	1			3.1 kVA	2.8 kVA			1	20 A	Existing	4
5	Existing	20 A	1					4.1 kVA	2.8 kVA	1	20 A	Existing	6
7	Existing	20 A	1	3.1 kVA	4.4 kVA					1	20 A	Existing	8
9	Existing	20 A	1			4.1 kVA	4.1 kVA			1	20 A	Existing	10
11	Existing	20 A	1					2.8 kVA	0.0 kVA	1	20 A	Spare	12
13	Spare	20 A	1	0.0 kVA	0.0 kVA					1	20 A	Spare	14
15	Space	--	--			0.0 kVA	1.7 kVA			2	15 A	Existing	16
17	Space	--	--					0.0 kVA	1.7 kVA				18
19				10.0 kVA	0.0 kVA					--	--	Space	20
21	Existing Transformer for Panel "EP"	50 A	3			10.0 kVA	0.0 kVA			--	--	Space	22
23								10.0 kVA	0.0 kVA	--	--	Space	24
25										--	--	Space	26
27	Transformer T-BPN	70 A	3	9.3 kVA	0.0 kVA					--	--	Space	28
29						9.7 kVA	0.0 kVA			--	--	Space	30
31								12.1 kVA	0.0 kVA	--	--	Space	32
33	AHU-1	35 A	3	7.0 kVA	4.4 kVA					3	20 A	AHU-2	34
35						7.0 kVA	4.4 kVA						36
37				6.0 kVA	0.0 kVA			7.0 kVA	4.4 kVA				38
39	AHU-3	30 A	3			6.0 kVA	0.0 kVA			3	30 A	SPD	40
41								6.0 kVA	0.0 kVA				42
Total Load:				51.1 kVA		52.8 kVA		50.9 kVA					
Total Amps:				185 A		191 A		184 A					
Load Classification				Connected Load		Demand Factor		Estimated Demand		Panel Totals			
HVAC				59.9 kVA		108.83%		65.1 kVA					
Receptacle				23.6 kVA		71.19%		16.8 kVA					
										Total Conn. Load: 154.9 kVA			
										Total Est. Demand: 153.33 kVA			
										Total Conn. Current: 186 A			
										Total Est. Demand Current: 184 A			
Notes:													
1. PROVIDE TYPE WRITTEN DIRECTORY STATING SPECIFIC LOAD AND LOCATION.													

Branch Panel: BPN														
Location: Storage 127C					Volts: 120/208 Wye			A.I.C. Rating: 22,000						
Supply From: 45 kVA, 277 V/480 V, Thre...					Phases: 3			Mains Type: MCB						
Mounting: Surface					Wires: 4			Mains Rating: 225 A						
Enclosure: Type 1								MCB Rating: 100 A						
								Neutral Rating:						
Notes:														
CK T	Circuit Description	N o t e	T r i p	P o l e	A	B	C	P o l e	T r i p	N o t e	Circuit Description	CK T		
1	Receptacles - Computer Lab 127E	20 A	1		0.8 kVA	0.6 kVA				1	20 A	Receptacles - Corridor 127A	2	
3	Receptacles - Computer Lab 127E	20 A	1				0.8 kVA	0.8 kVA		1	20 A	Receptacles - Classroom 1 127D	4	
5	Receptacles - Computer Lab 127E	20 A	1					0.8 kVA	0.8 kVA	1	20 A	Receptacles - Classroom 1 127D	6	
7	Receptacles - Computer Lab 127E	20 A	1		0.8 kVA	0.8 kVA				1	20 A	Receptacles - Classroom 1 127D	8	
9	Receptacles - Computer Lab 127E	20 A	1				0.8 kVA	0.4 kVA		1	20 A	Receptacles - Classroom 1 127D	10	
11	Receptacles - Computer Lab 127E	20 A	1					0.8 kVA	1.0 kVA	1	20 A	Receptacles - Multi-purpose 127B	12	
13	Receptacles - Computer Lab 127E	20 A	1		0.8 kVA	0.8 kVA				1	20 A	Receptacles - Multi-purpose 127B	14	
15	Receptacles - Computer Lab 127E	20 A	1				0.4 kVA	0.4 kVA		1	20 A	Receptacles - Multi-purpose 127B	16	
17	Receptacles - Media Center 127	20 A	1					0.8 kVA	0.6 kVA	1	20 A	Receptacles - Room 127B, 127C	18	
19	Receptacles - Media Center 127	20 A	1		0.8 kVA	0.4 kVA				1	20 A	Receptacles - Storage 127C	20	
21	Receptacles - Media Center 127	20 A	1				0.8 kVA	2.0 kVA		2	30 A	Receptacles - I.T. Rack - Storage 127C	22	
23	Receptacles - Media Center 127	20 A	1					0.8 kVA	2.0 kVA		2	30 A	Receptacles - I.T. Rack - Storage 127C	24
25	Receptacles - Media Center 127	20 A	1		0.4 kVA	0.8 kVA				1	20 A	Receptacles - Classroom 121	26	
27	Receptacles - Exterior/Rooftop	20 A	1				0.8 kVA	0.6 kVA		1	20 A	Receptacles - Classroom 121	28	
29	CU-01/SS-01	30 A	2		1.9 kVA	0.4 kVA		1.9 kVA	0.8 kVA	1	20 A	Receptacles - Classroom 121	30	
31							1.9 kVA	0.0 kVA		1	20 A	Receptacles - Classroom 121	32	
33	CU-02/SS-02	30 A	2					1.9 kVA	0.0 kVA	1	20 A	Spare	34	
35										1	20 A	Spare	36	
37	Space	--	--	--	0.0 kVA	0.0 kVA				1	20 A	Spare	38	
39	Space	--	--	--			0.0 kVA	0.0 kVA		1	20 A	Spare	40	
41	Space	--	--	--				0.0 kVA	0.0 kVA	1	20 A	Spare	42	
Total Load:					9.3 kVA		9.7 kVA		12.1 kVA					
Total Amps:					77 A		81 A		102 A					
Load Classification					Connected Load		Demand Factor		Estimated Demand		Panel Totals			
HVAC					7.5 kVA		112.50%		8.4 kVA					
Receptacle					23.6 kVA		71.19%		16.8 kVA					
											Total Conn. Load: 31.1 kVA			
											Total Est. Demand: 25.22 kVA			
											Total Conn. Current: 86 A			
											Total Est. Demand Current: 70 A			
Notes:														
1. PROVIDE TYPE WRITTEN DIRECTORY STATING SPECIFIC LOAD AND LOCATION.														

LIGHTING FIXTURE SCHEDULE									
Type	Description	Manufacturer	Model	Voltage	Required Lamps		VA		Comments
					Type	Lamp Quantity			
A2	2x4 FLUORESCENT TROFFER WITH .125 LENS, (2) F32T8 LAMPS	WILLIAMS LITHONIA METALUX	50G-S24-232-SA12125-EB2-UNV 2GT8-232-A12125M-MVOLT-GE10PS-LP835 2GR8-232A125-UNV-EB81	277 V	32W T8	2	58 VA		
A2E	2x4 FLUORESCENT TROFFER WITH .125 LENS, (2) F32T8 LAMPS, EMERGENCY BATTERY PACK	WILLIAMS LITHONIA METALUX	50G-S24-232-SA12125-EM1400-EB2-UNV 2GT8-232-A12125M-277-GE10PS-EL14-LP835 2GR8-232A125-UNV-EB81-EL	277 V	32W T8	2	58 VA	PROVIDE 1400 LUMEN EMERGENCY BATTERY PACK.	
B3	2x4', 3 LAMP, RECESSED DIRECT/INDIRECT DROP BASKET FIXTURE WITH WHITE PERFORATED DIFFUSER	WILLIAMS LITHONIA METALUX	DIG-S24-332-WPR-EB3-UNV 2GT8-332-A12125M-MVOLT-1/3-GE10PS-LP835 2RDI-332RP-UNV-EB81	277 V	32W T8	3	88 VA		
B3E	2x4', 3 LAMP, RECESSED DIRECT/INDIRECT DROP BASKET FIXTURE WITH WHITE PERFORATED DIFFUSER, EMERGENCY BATTERY PACK	WILLIAMS LITHONIA METALUX	DIG-S24-332-WPR-EM1400-EB3-UNV 2GT8-332-A12125M-277-1/3-GE10PS-EL14-LP835 2RDI-332RP-UNV-EB81-EL	277 V	32W T8	3	88 VA	PROVIDE 1400 LUMEN EMERGENCY BATTERY PACK.	
C2	4', 2 LAMP FLUORESCENT STRIP FIXTURE	WILLIAMS LITHONIA METALUX	76-4-232-EB2-UNV C-232-MVOLT-GE10PS SSF-232-UNV-EB81	277 V	32W T8	2	58 VA		
D	6" DIA HORIZONTAL DOWNLIGHT, CLEAR SEMI-SPECULAR REFLECTOR, WHITE TRIM RING	WILLIAMS LITHONIA HALO (COMMERCIAL)	PH60-126Q-CS-EB1-UNV LFN6N-1/26TRT-F601AZ-MVOLT-TRW-WLP PDBH126-62HHWF	277 V	26W PL-T	1	28 VA		
F	2'-0" WALL MOUNTED FLUORESCENT WRAPAROUND, CLEAR ACRYLIC PRISMATIC DIFFUSER	WILLIAMS LITHONIA METALUX	20-2-217-A-EB2-UNV WOC-217-A12-MVOLT-GE10PS CR-232A-UNV-EB81 / CR-WALLKIT	277 V	F17T8	2	34 VA	MOUNT DIRECTLY ABOVE MIRROR	
G	8" DIA HORIZONTAL DOWNLIGHT, CLEAR SEMI-SPECULAR REFLECTOR, WHITE TRIM RING	WILLIAMS LITHONIA HALO (COMMERCIAL)	PH85-232T-CS-EB1-UNV LFN8N-2/32TRT-F803AZ-MVOLT-TRW-WLP PDBH242-82HHWF	277 V	32W PL-T	2	68 VA		
GE	8" DIA HORIZONTAL DOWNLIGHT, CLEAR SEMI-SPECULAR REFLECTOR, WHITE TRIM RING, EMERGENCY BATTERY PACK	WILLIAMS LITHONIA HALO (COMMERCIAL)	PH85-232T-CS-EB1-UNV-EM LFN8N-2/32TRT-F803AZ-MVOLT-TRW-WLP PDBH242-82HHWF	277 V	32W PL-T	2	68 VA		
X	LED EXIT SIGN, UNIVERSAL MOUNTING, RED LETTERS, BRUSHED ALUMINUM BACKGROUND, BLACK HOUSING AND SINGLE OR DOUBLE FACE	BEGHELLI EXITRONIX SURELITES	LC1-SA-LR-1/2-B-AT 400U-WB-BL-G2 CX71	277 V	LED	PROVIDED WITH FIXTURE	10 VA	NUMBER OF FACES AND DIRECTIONAL ARROWS AS INDICATED ON PLANS.	

#### NOTES:

- ALL FLUORESCENT FIXTURES SHALL USE T8 LAMPS AND PROGRAMMED START ELECTRONIC BALLASTS, UNLESS OTHERWISE NOTED. ALL BALLAST SHALL BE HIGH EFFICIENCY TYPE BF 0.88 MINIMUM. PROVIDE UNIVERSAL VOLTAGE BALLAST ON ALL NON-DIMMABLE FLUORESCENT LIGHT FIXTURES. ALL FLUORESCENT FIXTURES INSTALLED IN AREAS WHERE EMI AND/OR RFI ARE A CONCERN SHALL BE EQUIPPED WITH LOW FREQUENCY ELECTRONIC BALLAST.
- REFER TO ARCHITECTURAL REFLECTED CEILING PLAN FOR EXACT LOCATION OF LIGHT FIXTURES. COORDINATE TYPE OF CEILING FOR EACH FIXTURE WITH ARCHITECTURAL REFLECTED CEILING PLANS AND PROVIDE FIXTURE TRIM AS REQUIRED.
- ALL MAGNETIC BALLASTED FIXTURES SHALL BE FUSED.
- PROVIDE APPROVED FIRE RATED ENCLOSURES FOR ALL LIGHT FIXTURES LOCATED IN FIRE RATED CEILINGS.
- PROVIDE ALL REQUIRED HARDWARE TO MOUNT FIXTURES PER MANUFACTURER'S INSTALLATION INSTRUCTIONS.
- PROVIDE ZERO DEGREE BALLASTS FOR ALL OUTDOOR LIGHTING FIXTURES.
- ALL ACRYLIC LENSED FIXTURES SHALL HAVE A LENS THICKNESS OF .125 INCHES MINIMUM.
- IF THERE IS A DISCREPANCY BETWEEN A FIXTURE DESCRIPTION, AND THE CATALOG NUMBER LISTED, THE FIXTURE DESCRIPTION SHALL DICTATE.
- COORDINATE DIMMING BALLAST AND DIMMING CONTROL PRODUCTS (PANEL, SWITCH, ETC.) FOR COMPATIBLE OPERATION.
- ALL EXIT SIGNS AND FIXTURES WITH INTEGRAL BATTERY SHALL HAVE INTEGRAL TEST SWITCH AND LED INDICATOR LIGHT.
- LOW-MERCURY LAMPS: COMPLY WITH EPA'S TOXICITY CHARACTERISTIC LEACHING PROCEDURE TEST; SHALL YIELD LESS THAN 0.2MG OF MERCURY PER LITER WHEN TESTED ACCORDING TO NEMA LL 1.
- PROVIDE LAMP AND BALLAST INFORMATION DATA CUT SHEETS THAT INCLUDE ALL TECHNICAL INFORMATION AS PART OF SHOP DRAWINGS.

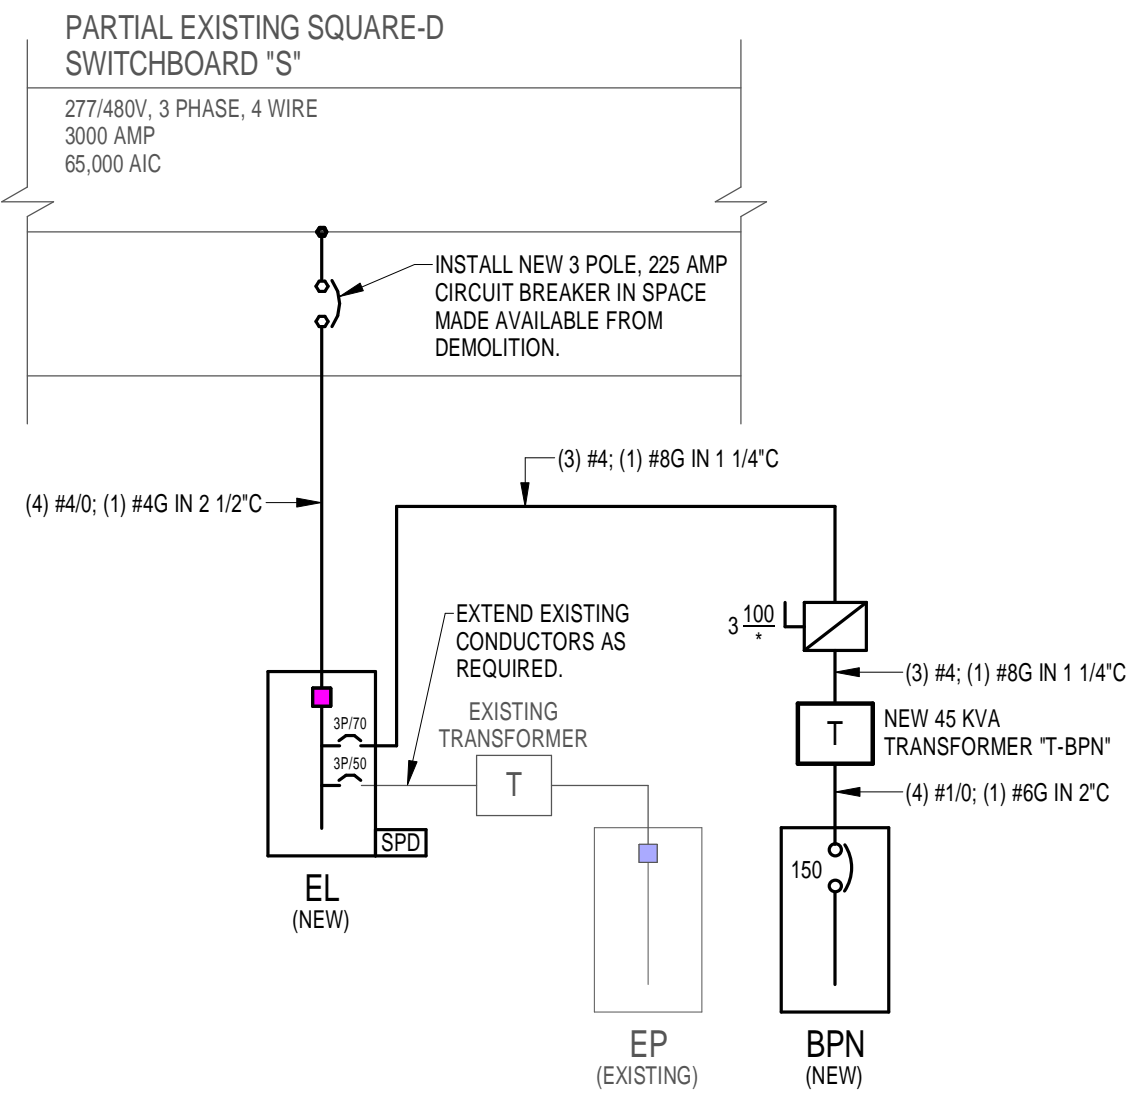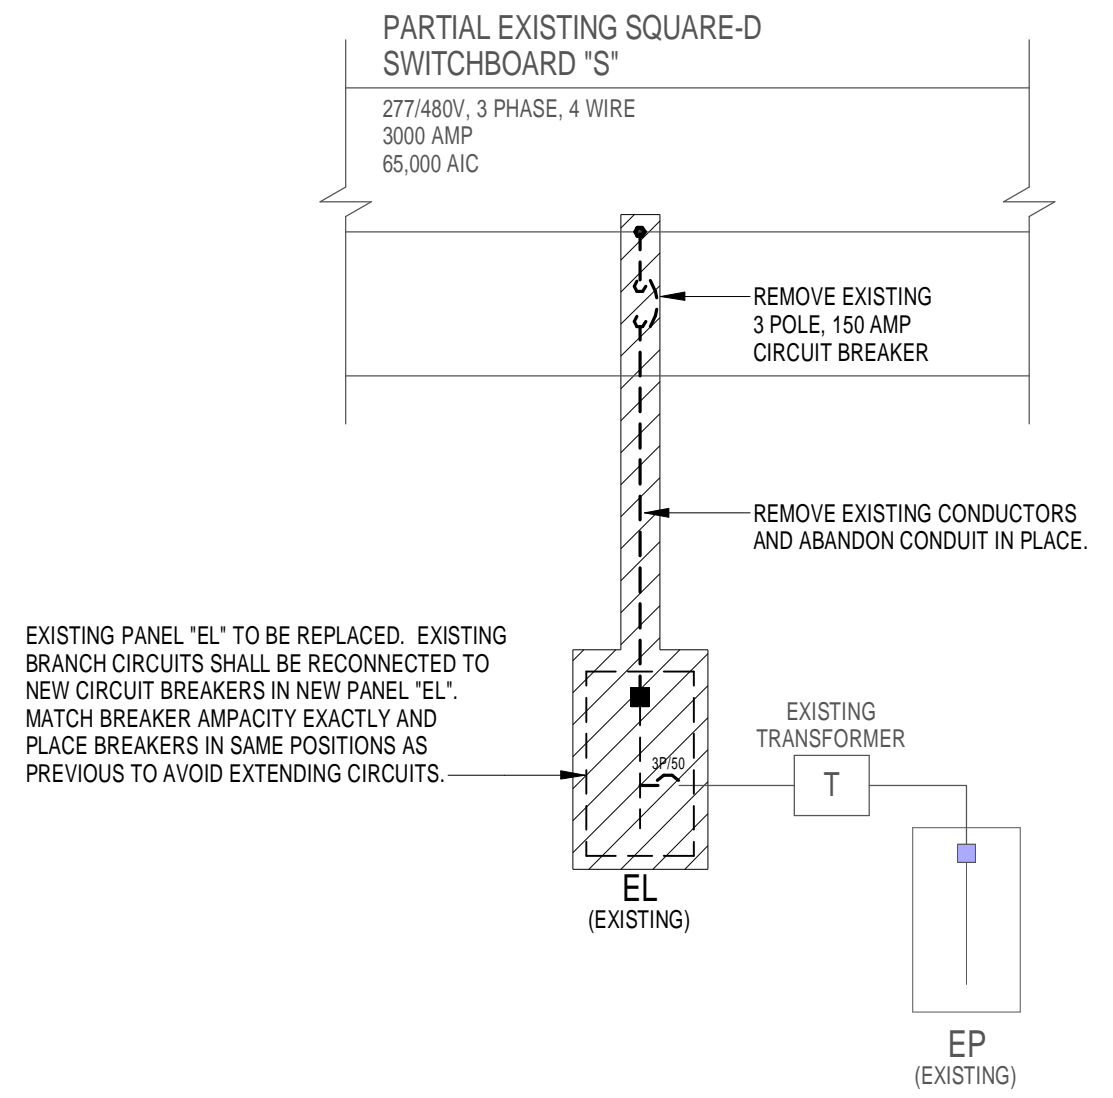

#### LOAD SUMMARY - EXISTING SWITCHBOARD "S"

3000A MCB, 277/480V, 3 PHASE, 4WIRE

DESCRIPTION	REMOVED LOAD (KVA)	ADDED LOAD (KVA)	TOTAL LOAD (KVA)
DESIGNED LOAD FROM 1997 PROJECT	--	--	2145.00 KVA
PANEL "EL" / "BNP"	--	83.5 KVA	83.5 KVA
EXISTING PANEL "AL"	3.7 KVA	1.7 KVA	-2.0 KVA
EXISTING PANEL "BL"	12.00 KVA	10.5 KVA	-1.5 KVA
EXISTING PANEL "P4"	--	5.0 KVA	5.0 KVA
TOTAL	15.7 KVA	100.7 KVA	2227.00 KVA

2230.00 KVA @ 277/480V, 3 PHASE = 2684 AMPS

#### LOAD SUMMARY - EXISTING PANEL "P4"

400A MCB, 277/480V, 3 PHASE, 3 WIRE

DESCRIPTION	REMOVED LOAD (KVA)	ADDED LOAD (KVA)	TOTAL LOAD (KVA)
DESIGNED LOAD FROM 1997 PROJECT	--	--	165.00 KVA
ADDED "VTU-1"	--	5.0 KVA	5.0 KVA
TOTAL	--	5.0 KVA	170.00 KVA

170.00 KVA @ 277/480V, 3 PHASE = 205 AMPS

#### LOAD SUMMARY - EXISTING PANEL "AL"

100A MLO, 277/480V, 3 PHASE, 4 WIRE

DESCRIPTION	REMOVED LOAD (KVA)	ADDED LOAD (KVA)	TOTAL LOAD (KVA)
DESIGNED LOAD FROM 1997 PROJECT	--	--	70.00 KVA
LIGHTING*	3.7	1.7 KVA	-2.0 KVA
TOTAL	3.7	1.7 KVA	68.00 KVA

68.00 KVA @ 277/480V, 3 PHASE = 82 AMPS

#### LOAD SUMMARY - EXISTING PANEL "BL"

225A MLO, 277/480V, 3 PHASE, 4 WIRE

DESCRIPTION	REMOVED LOAD (KVA)	ADDED LOAD (KVA)	TOTAL LOAD (KVA)
DESIGNED LOAD FROM 1997 PROJECT	--	--	104.00 KVA
LIGHTING*	12.0	10.5 KVA	-1.5 KVA
TOTAL	12.0	10.5 KVA	102.5 KVA

102.5 KVA @ 277/480V, 3 PHASE = 123 AMPS



#### REVISIONS AND UPDATES

02/14/14	CONSTRUCTION DOCUMENTS FOR BID/PERMIT


SUWANNEE COUNTY SCHOOL BOARD SUWANNEE PRIMARY SCHOOL ADDITIONS AND REMODELING 1625 WALKER AVE., SW ELECTRICAL ONE-LINE AND SCHEDULES LIVE OAK, FLORIDA		
drawn PJM	checked MMH	approved MMH
<b>RZK</b> AA-C007503		
ARCHITECTS RZK, INC. 600 FLORIDA AVENUE SUITE 202 COCOA, FLORIDA 32922 TELEPHONE (321) 631-8039		
job no. 2012.51 <b>E-4.1</b>		

M. Moncef Hadji, P.E. Florida License #48022
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TYPICAL EQUIPMENT

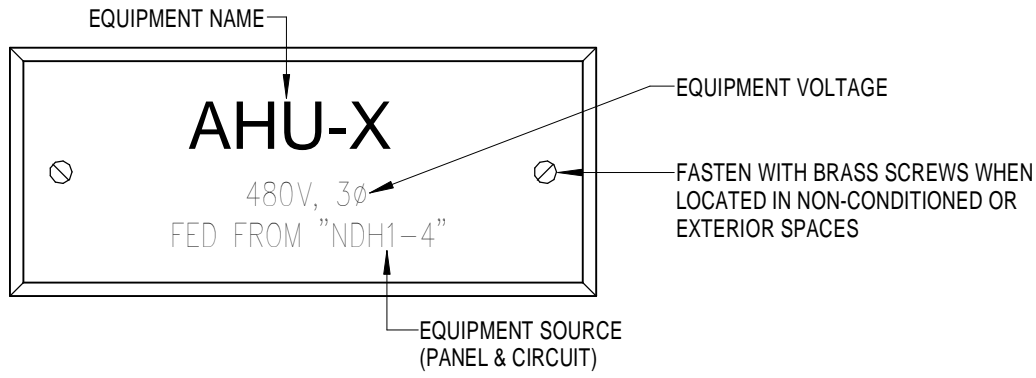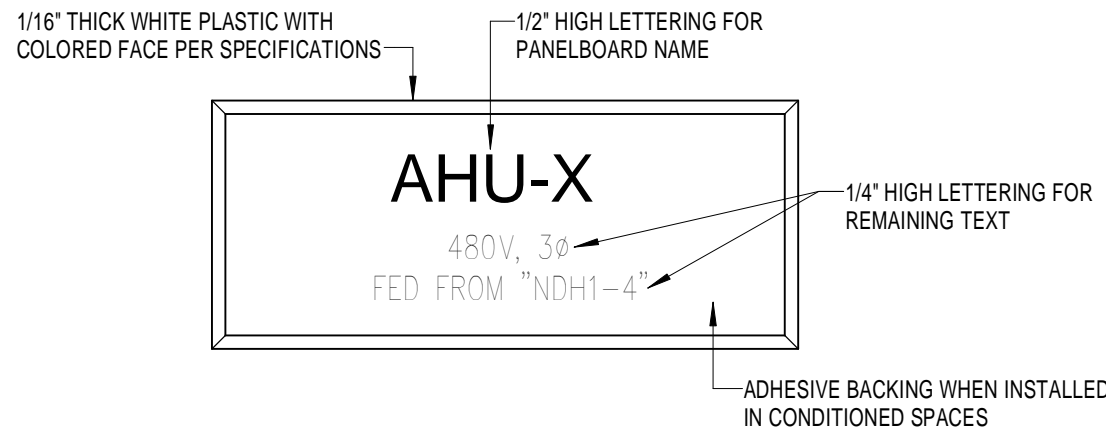


EQUIPMENT NAMEPLATE  
No Scale


3

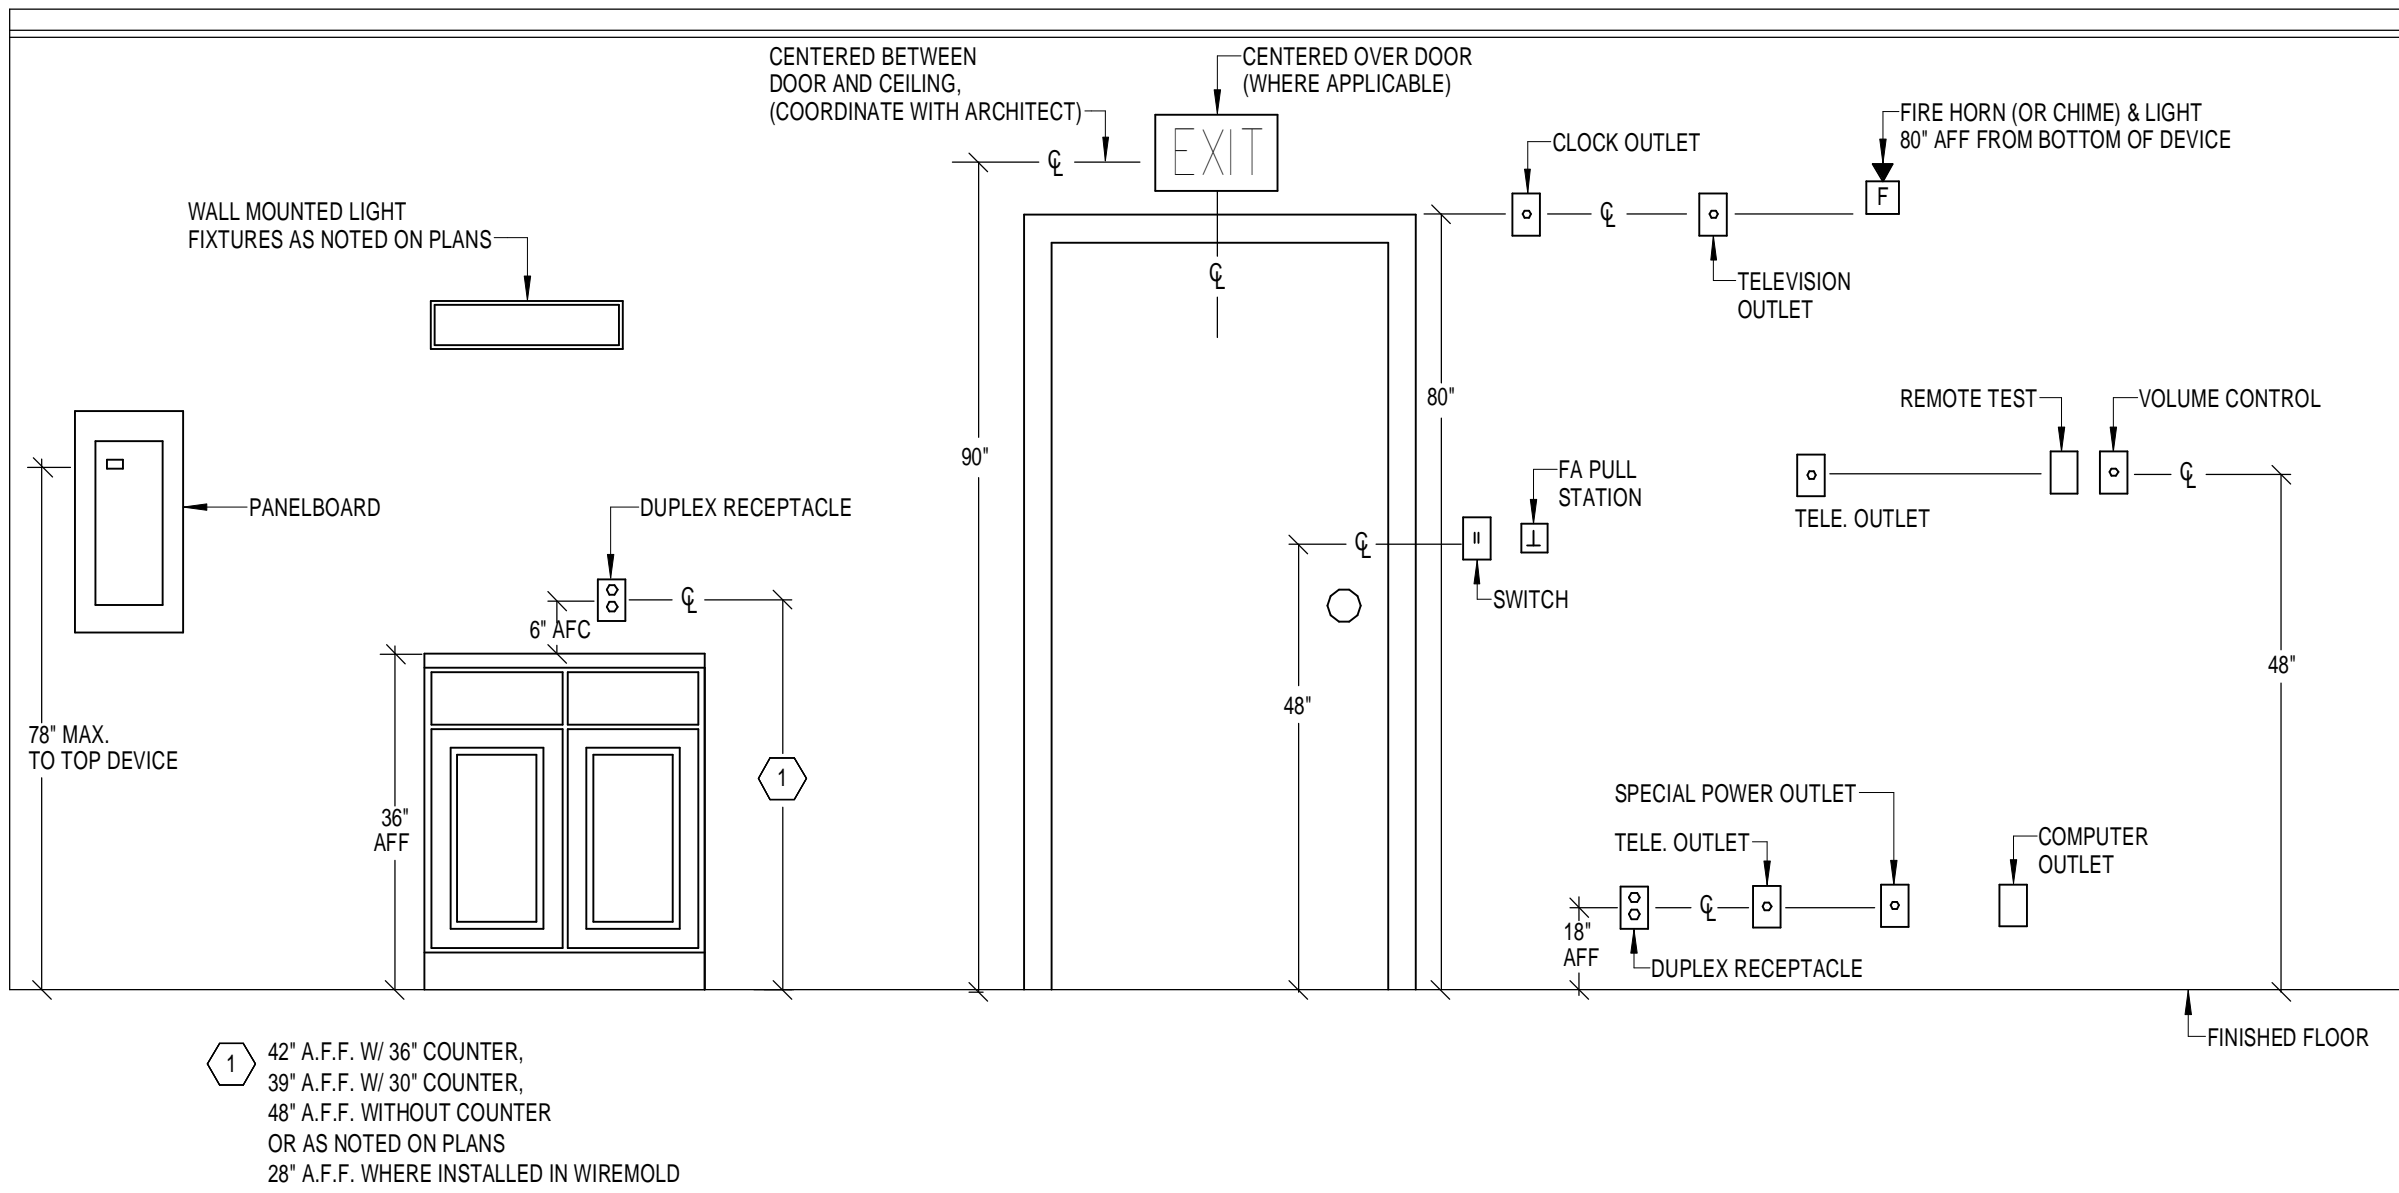MOUNTING HEIGHTS  
No Scale

1

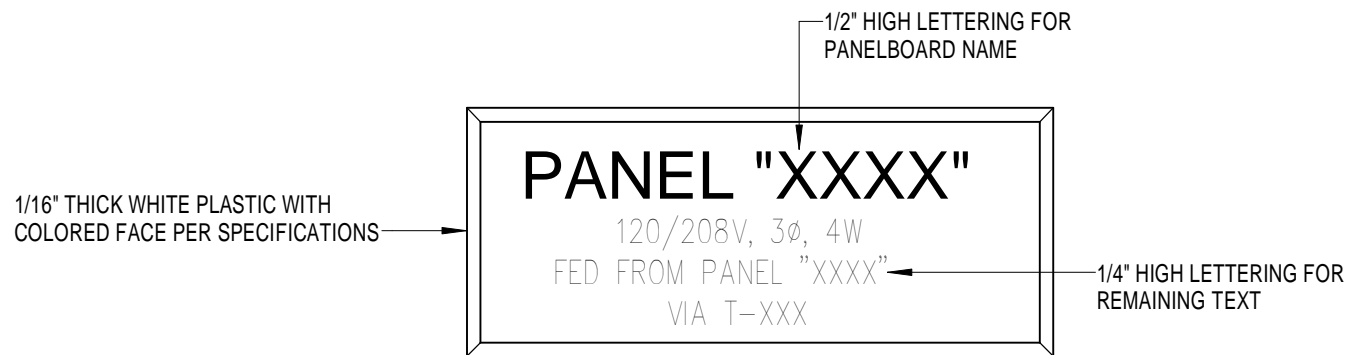

TYPICAL 120/208V PANELBOARD

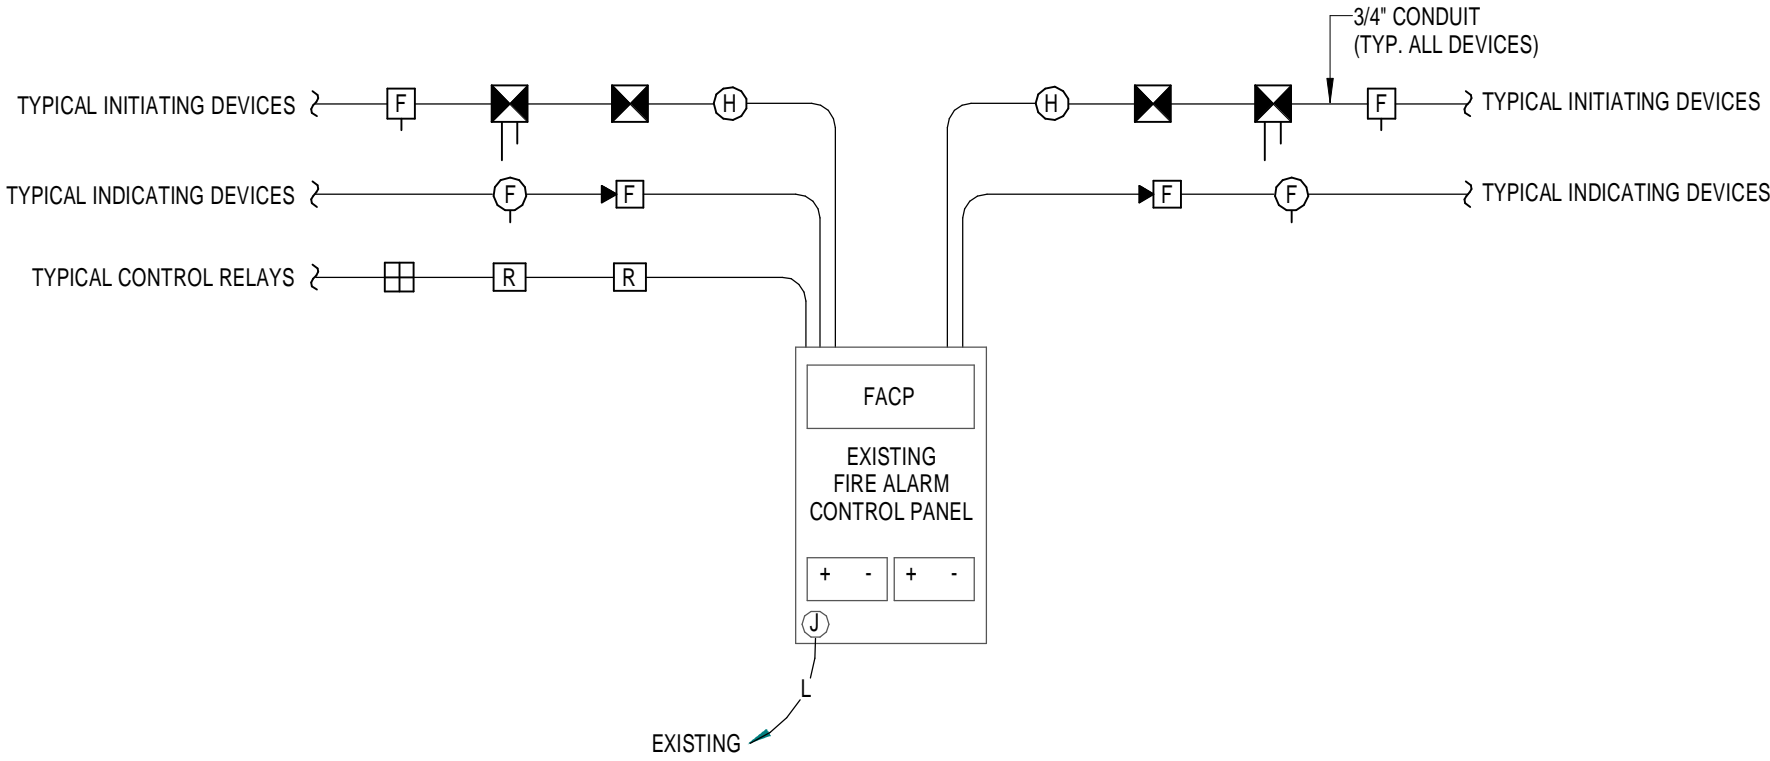

GROUND FLOOR

PANELBOARD NAMEPLATE  
No Scale

4

FIRE ALARM RISER  
No Scale


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REVISIONS AND UPDATES

02/14/14	CONSTRUCTION DOCUMENTS FOR BID/PERMIT

SUWANNEE COUNTY SCHOOL BOARD  
SUWANNEE PRIMARY SCHOOL  
ADDITIONS AND REMODELING  
1625 WALKER AVE., SW LIVE OAK, FLORIDA  
ELECTRICAL DETAILS

drawn: PJM checked: Checker approved: Approver

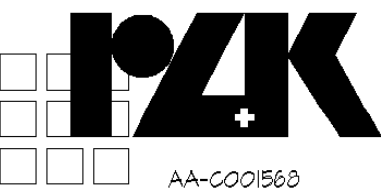

ARCHITECTS RZK, INC.  
600 FLORIDA AVENUE SUITE 202 COCOA, FLORIDA 32922 TELEPHONE (321) 631-8039


job no. 2012.51

E-5.1

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Florida License #48022

Seal

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- NOTES:**
- 1) PROVIDE BACKBOXES AND CONDUITS ONLY. ALL VOICE/DATA OUTLETS AND SYSTEM WIRING WILL BE PROVIDED BY THE HOSPITAL.
  - 2) PROVIDE 1" CONDUIT FROM EACH DEVICE BACKBOX TO THE NEAREST CABLETRAY.

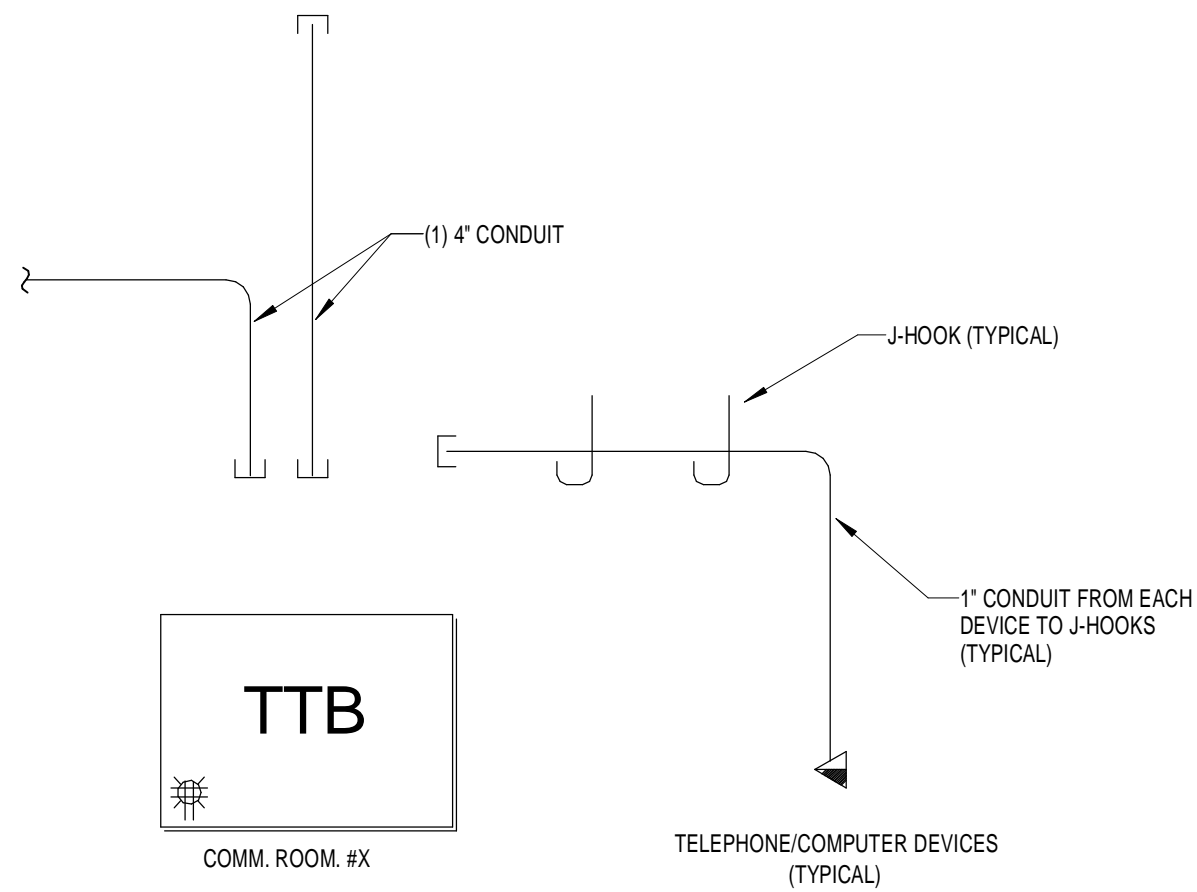**TELE/DATA RISER (J-HOOK)**  
No Scale


5

**CONDUIT PENETRATION OF FIREWALL**  
UL SYSTEM NO. W-L-1001

3




**GROUND BAR**  
No Scale

1

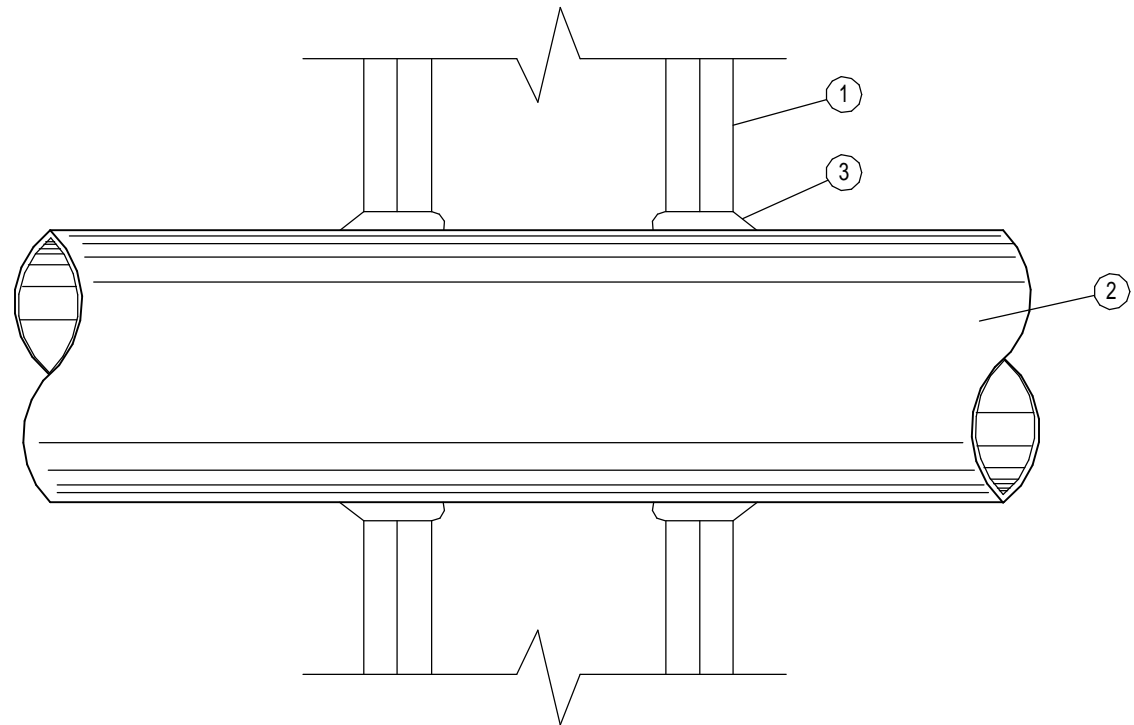

- NOTES:**
- 1) WALL ASSEMBLY - THE 1, 2, 3, OR 4 HOUR FIRE-RATED GYPSUM WALLBOARD/STUD WALL ASSEMBLY SHALL BE CONSTRUCTED OF THE MATERIALS AND IN THE MANNER DESCRIBED IN THE INDIVIDUAL U300 OR U400 SERIES WALL OR PARTITION DESIGNS IN THE UL FIRE RESISTANCE DIRECTORY.
  - 2) CONDUIT - NOM 4" DIA OR SMALLER STEEL ELECTRICAL METALLIC TUBING. A MAX OF ONE CONDUIT IS PERMITTED IN THE FIRESTOP SYSTEM. CONDUIT TO BE INSTALLED NEAR CENTER OF STUD CAVITY WIDTH AND TO BE RIGIDLY SUPPORTED ON BOTH SIDES OF WALL ASSEMBLY.
  - 3) FILL VOID OR CAVITY MATERIAL - CAULK FILL MATERIAL BEARING THE UL CLASSIFICATION MARKING INSTALLED TO COMPLETELY FILL ANNULAR SPACE BETWEEN PIPE OR CONDUIT AND GYPSUM WALLBOARD AND WITH A MIN 1/4" DIAM BEAD OF CAULK APPLIED TO PERIMETER OF CONDUIT AT ITS EGRESS FROM THE WALL. CAULK INSTALLED SYMMETRICALLY ON BOTH SIDES OF WALL ASSEMBLY. THE HOURLY F RATING OF THE FIRESTOP SYSTEM IS DEPENDENT UPON THE HOURLY FIRE RATING OF THE WALL ASSEMBLY IN WHICH IT IS INSTALLED, AS SHOWN IN THE FOLLOWING TABLE. THE HOURLY T RATING OF THE FIRESTOP SYSTEM IS DEPENDENT UPON THE TYPE OR SIZE OF THE CONDUIT AND THE HOURLY FIRE RATING OF THE WALL ASSEMBLY IN WHICH IT IS INSTALLED, AS TABULATED BELOW:

MAX CONDUIT DIAM, IN.	ANNULAR SPACE, IN.	F RATING, HR.	T RATING, HR.
1	0 TO 3/16	1 OR 2	0, 1 OR 2
1	1/4 TO 1/2	3 OR 4	3 OR 4
4	0 TO 1-1/2	1 OR 2	0
6	1/4 TO 1/2	3 OR 4	0
12	3/16 TO 3/8	1 OR 2	0

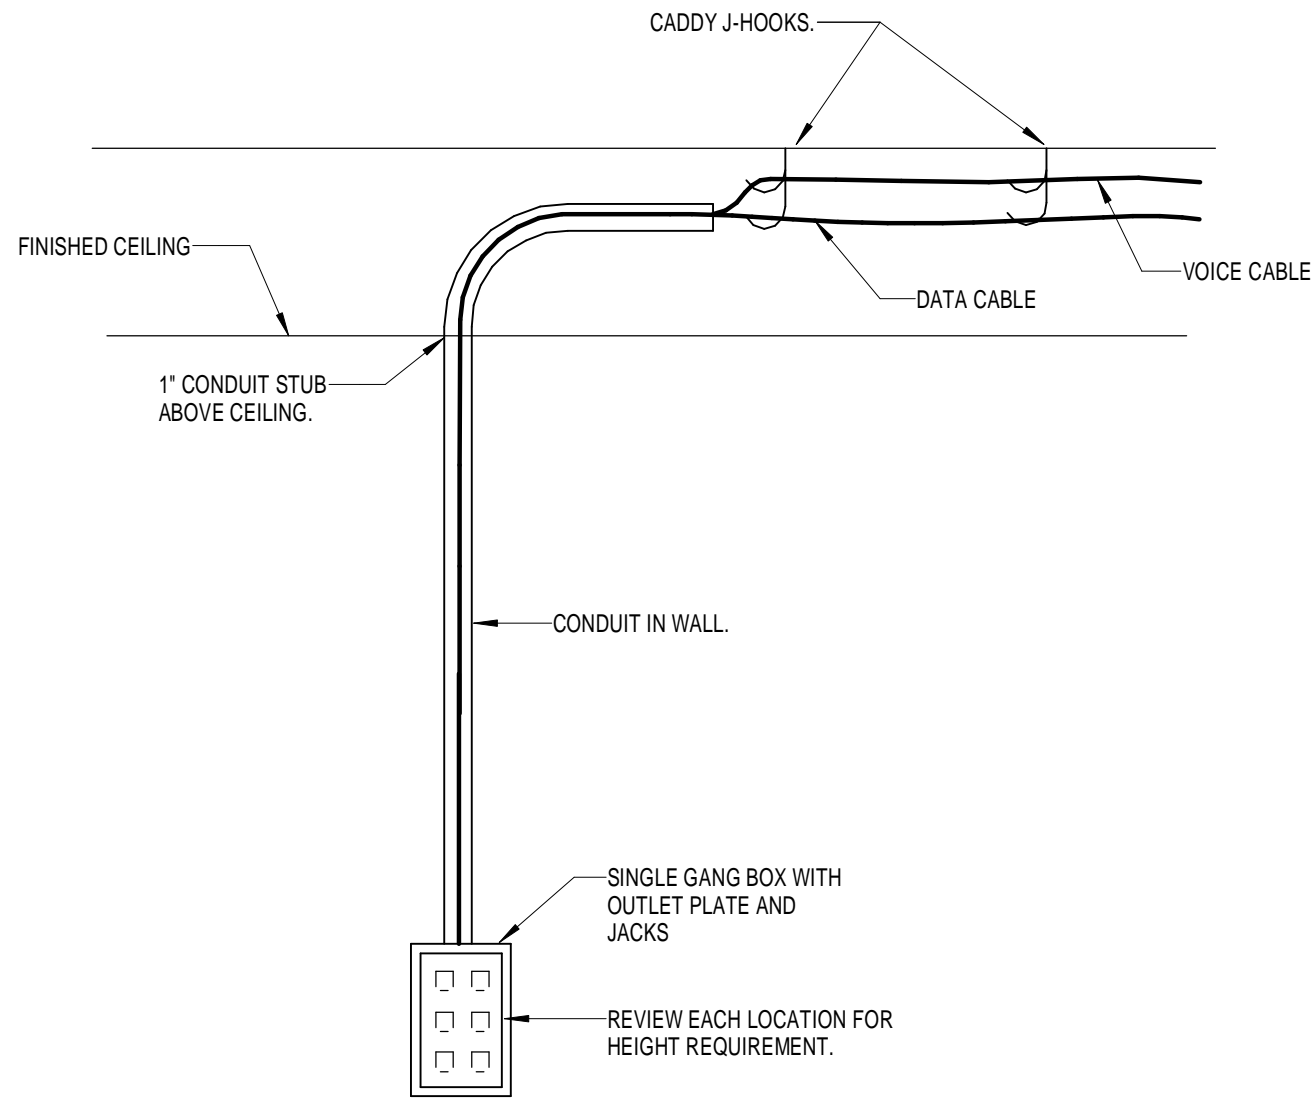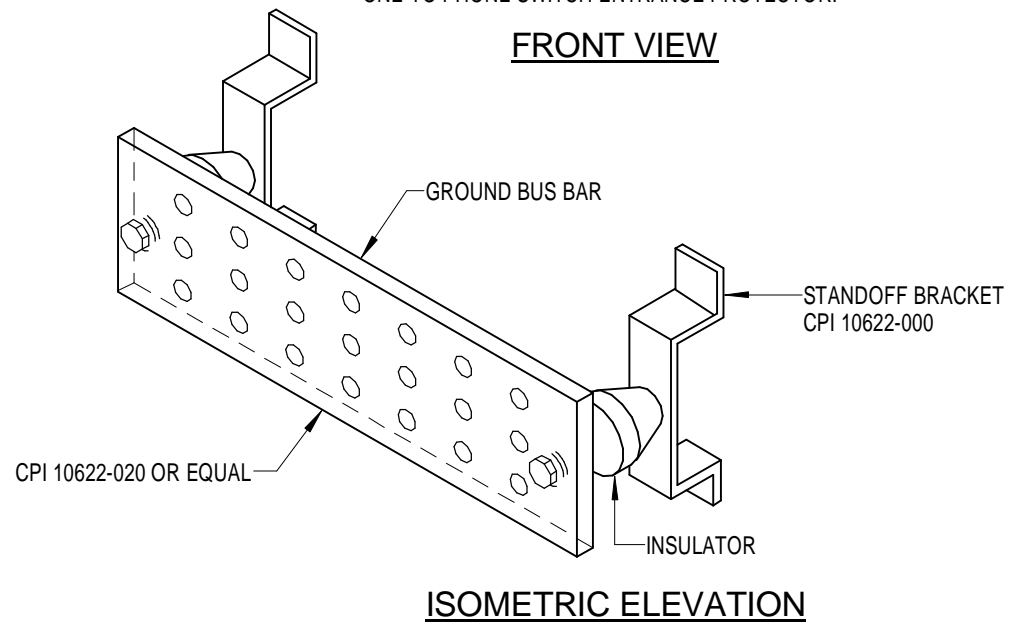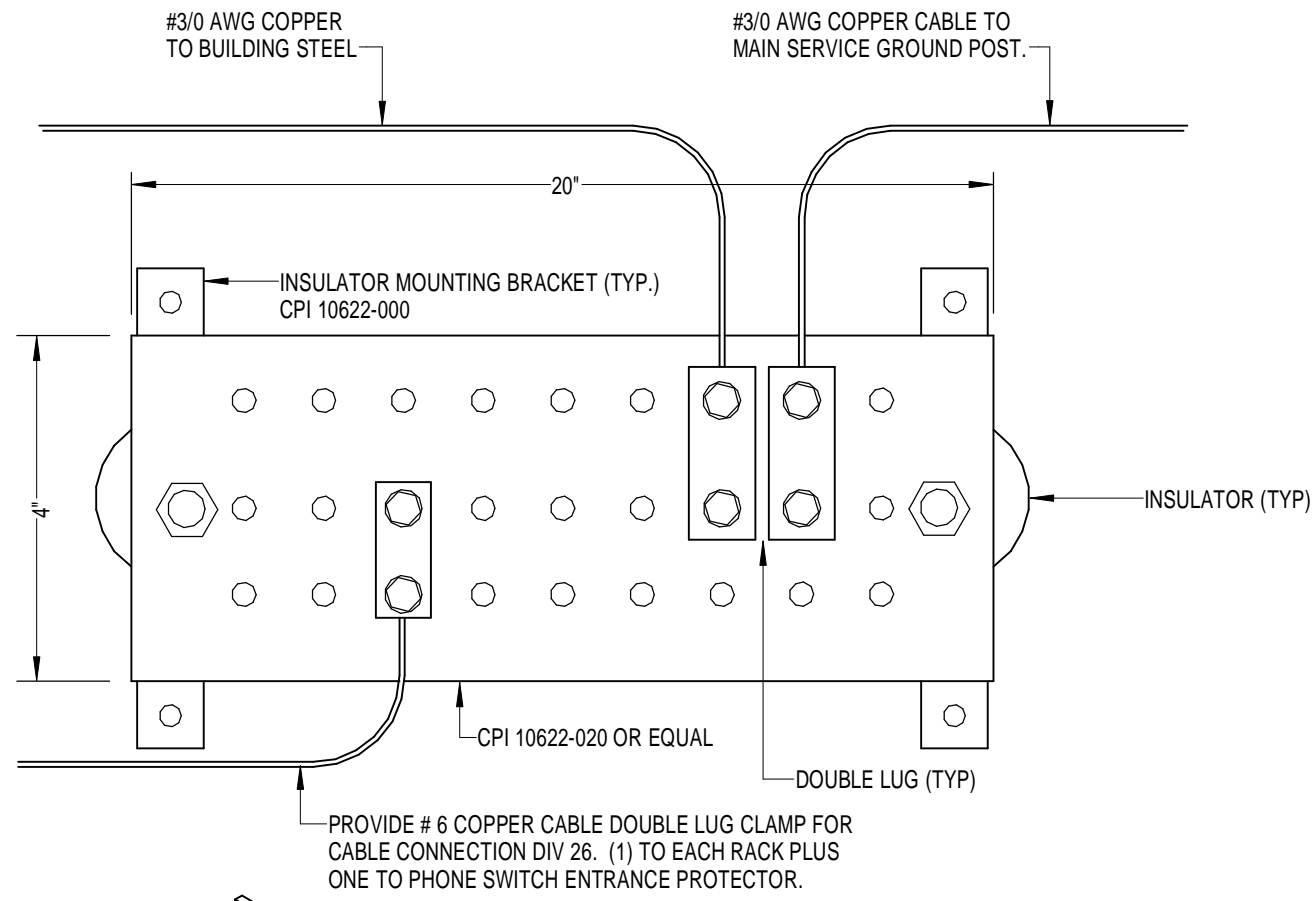

**TYPICAL VOICE / DATA OUTLET**  
No Scale


6

**CABLE TV/ POWER OUTLET DETAIL**  
No Scale


4

**TYPICAL RECEPTACLE MOUNTING DETAIL**  
No Scale

2

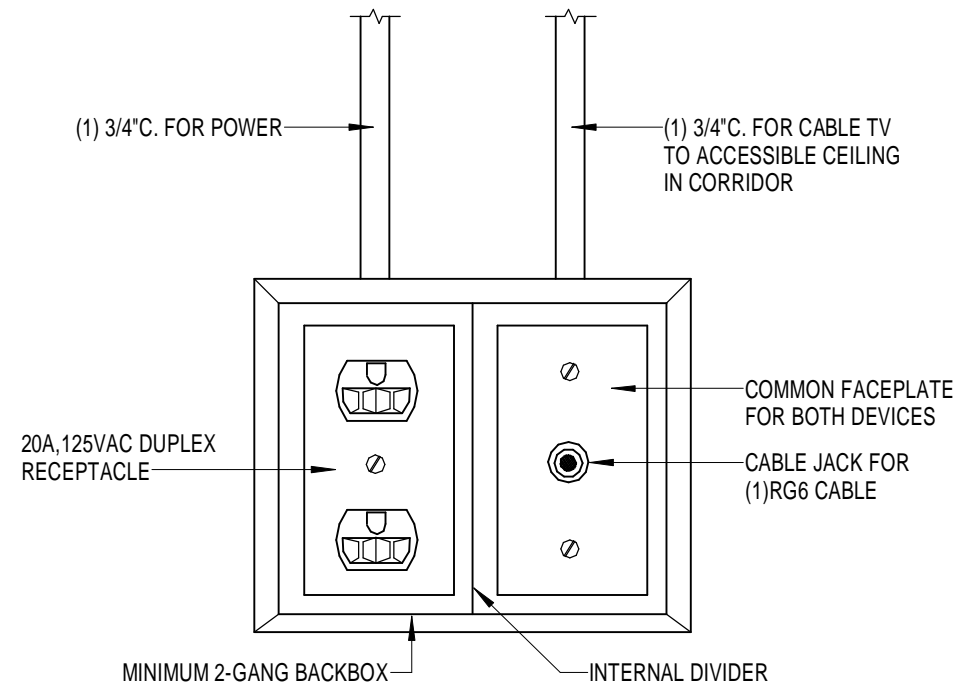

- NOTE:**  
COORDINATE DEVICE LOCATION AND MOUNTING HEIGHT WITH ARCHITECTURAL ELEVATIONS.

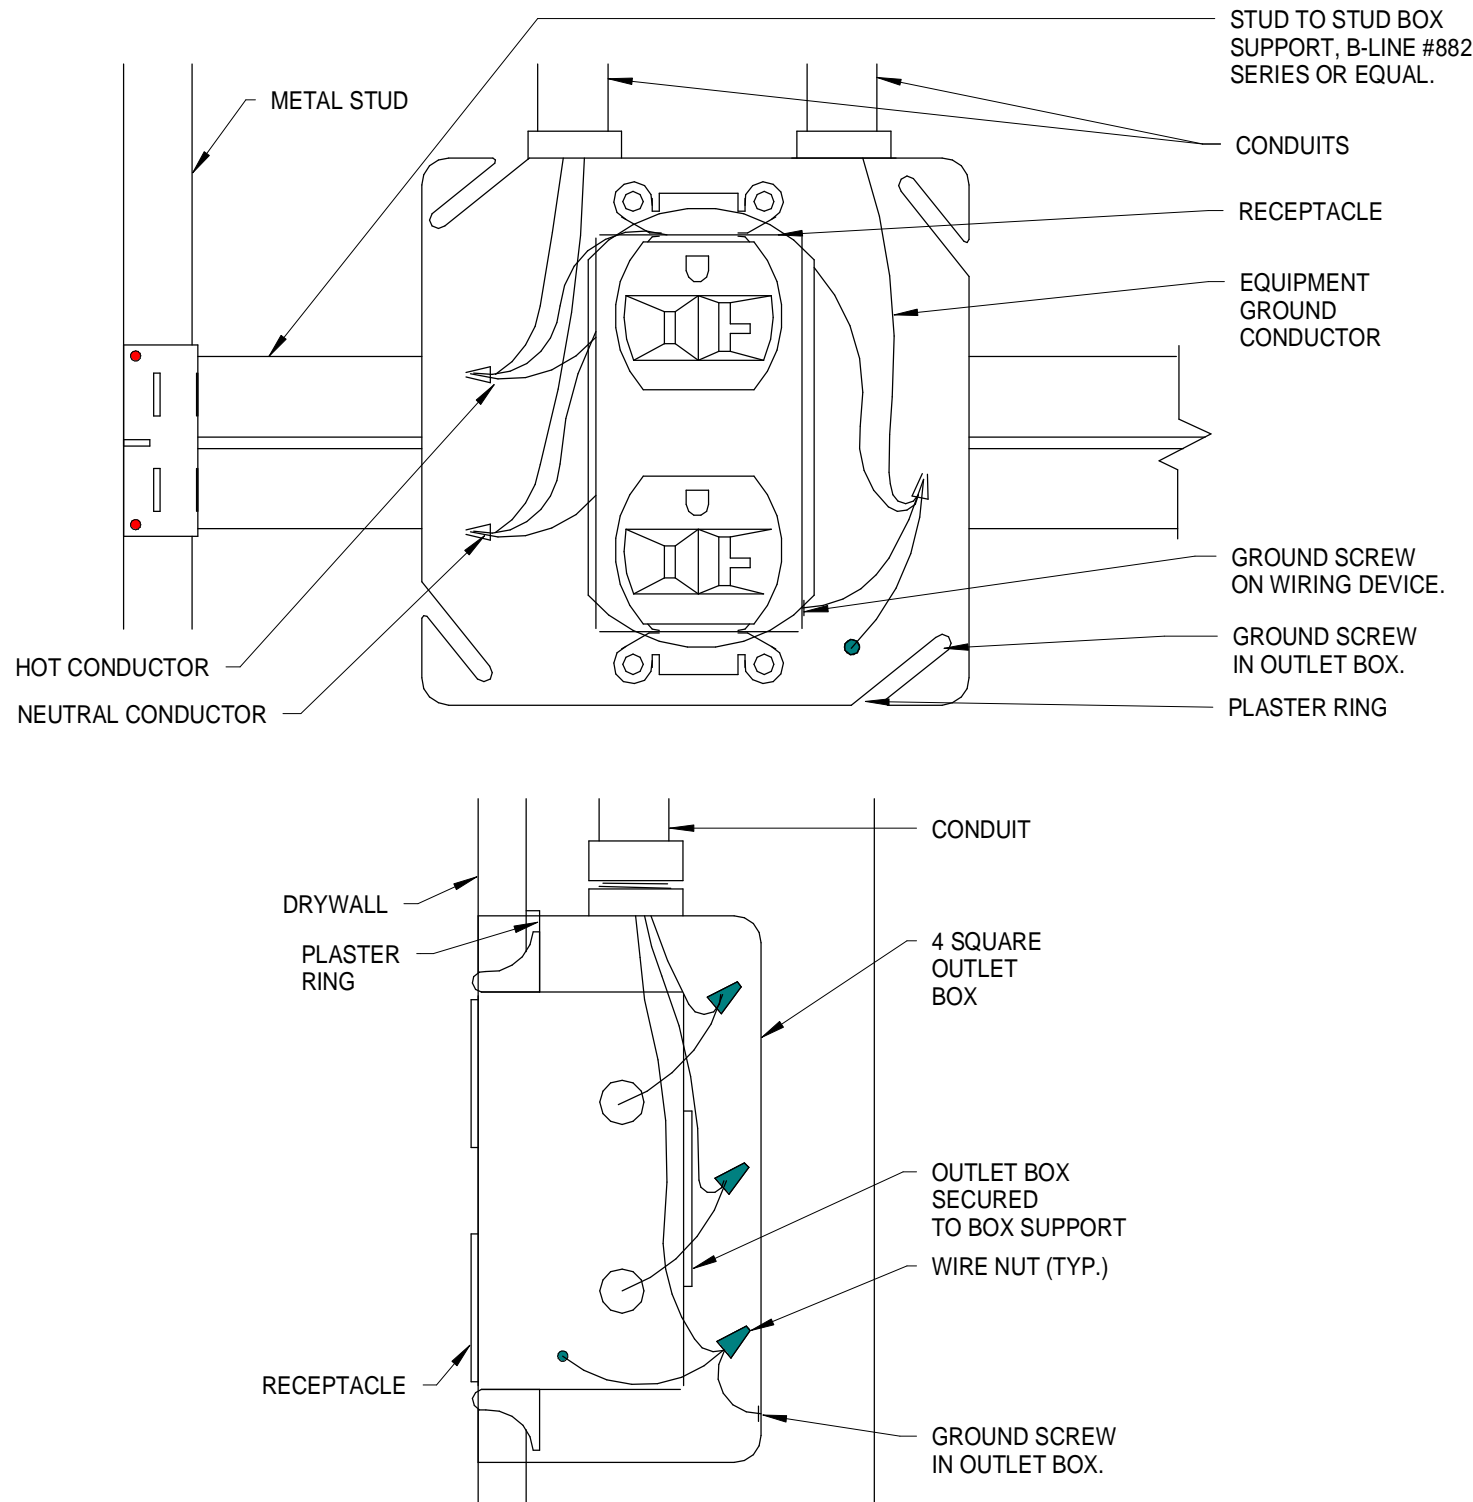


**REVISIONS AND UPDATES**

DATE	DESCRIPTION
02/14/14	CONSTRUCTION DOCUMENTS FOR BID/PERMIT

SUWANNEE COUNTY SCHOOL BOARD  
**SUWANNEE PRIMARY SCHOOL  
ADDITIONS AND REMODELING**  
1625 WALKER AVE., SW LIVE OAK, FLORIDA  
**ELECTRICAL DETAILS**

drawn Author checked Checker approved Approver

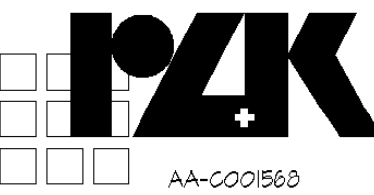

**ARCHITECTS RZK, INC.**  
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job no. 2012.51

**E-5.2**

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Seal